

READING TERMINAL MARKET CAPITAL IMPROVEMENTS

READING TERMINAL MARKET


51 NORTH 12TH STREET,
PHILADELPHIA PA 19107

PROJECT NUMBER: 071274
02/03/23
GENERAL PACKAGE


GENERAL	
G001	COVER SHEET
G002	CODE FLOOR PLANS
ARCHITECTURAL	
A001	GENERAL NOTES, SYMBOLS, LEGENDS & ABBREVIATIONS
A101	FLOOR PLAN & DETAILS
A102	FLOOR PLAN & DETAILS
A501	OVERHEAD DOOR DETAILS
MECHANICAL	
M001	LEGEND
M002	GENERAL NOTES AND ABBREVIATIONS
MD101	DEMOLITION GROUND FLOOR OVERALL PLAN
MD102	DEMOLITION GROUND FLOOR PLAN - AREA A
MD103	DEMOLITION GROUND FLOOR PLAN - AREA B
MD104	DEMOLITION GROUND FLOOR PLAN - AREA C
MD105	DEMOLITION GROUND FLOOR PLAN - AREA D
M101	NEW WORK GROUND FLOOR OVERALL PLAN
M102	NEW WORK GROUND FLOOR PLAN - AREA A
M103	NEW WORK GROUND FLOOR PLAN - AREA B
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M401	ENLARGED SCALE DRAWINGS - PLANS
M501	DETAILS
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P001	LEGEND, GENERAL NOTES & ABBREVIATIONS
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P501	DETAILS & SCHEDULES
ELECTRICAL	
E001	GENERAL NOTES, SYMBOLS, LEGENDS & ABBREVIATIONS
ED101	GROUND FLOOR DEMOLITION OVERALL PLAN
ED102	GROUND FLOOR ENLARGED DEMOLITION PLANS
E101	GROUND FLOOR OVERALL PLAN
E102	GROUND FLOOR ENLARGED NEW WORK PLANS




Local File Autodesk Docs\\071274-RTM_Renovation_Project\\071274_ReadTermMarket_A_R22.rvt
Central File: BM0801_A_Central_R20.rvt
Project Number: 071274
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PROJECT LOCATION
SCALE: NTS

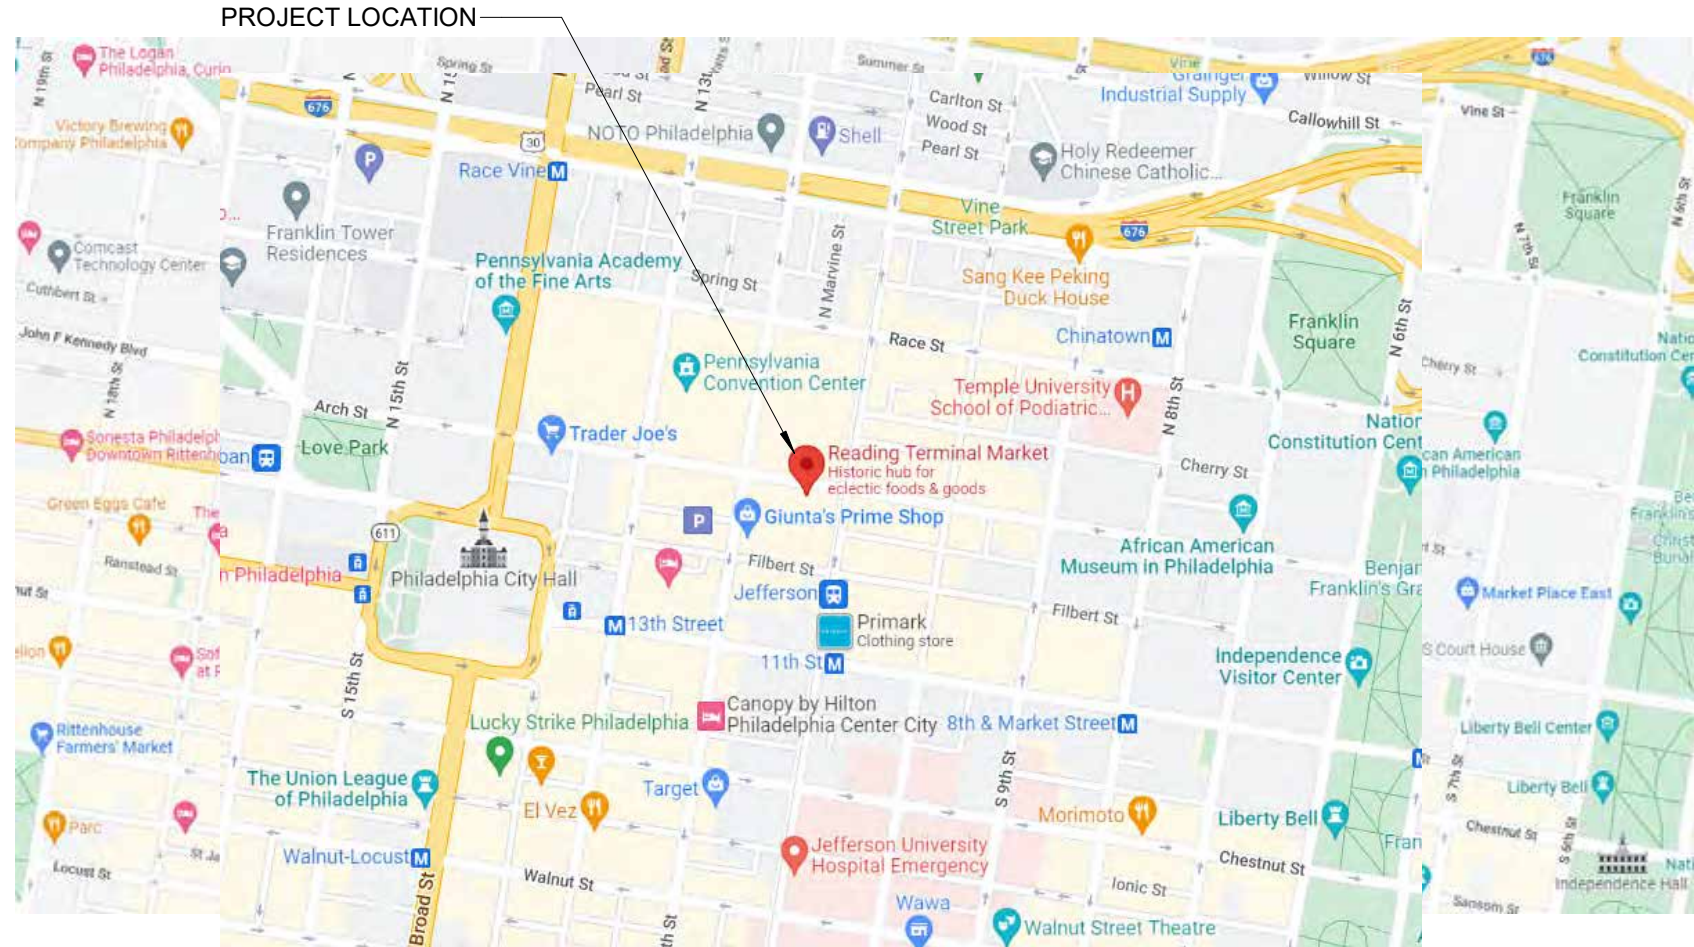

OVERALL GROUND FLOOR PLAN
SCALE: 1/32" = 1'-0"

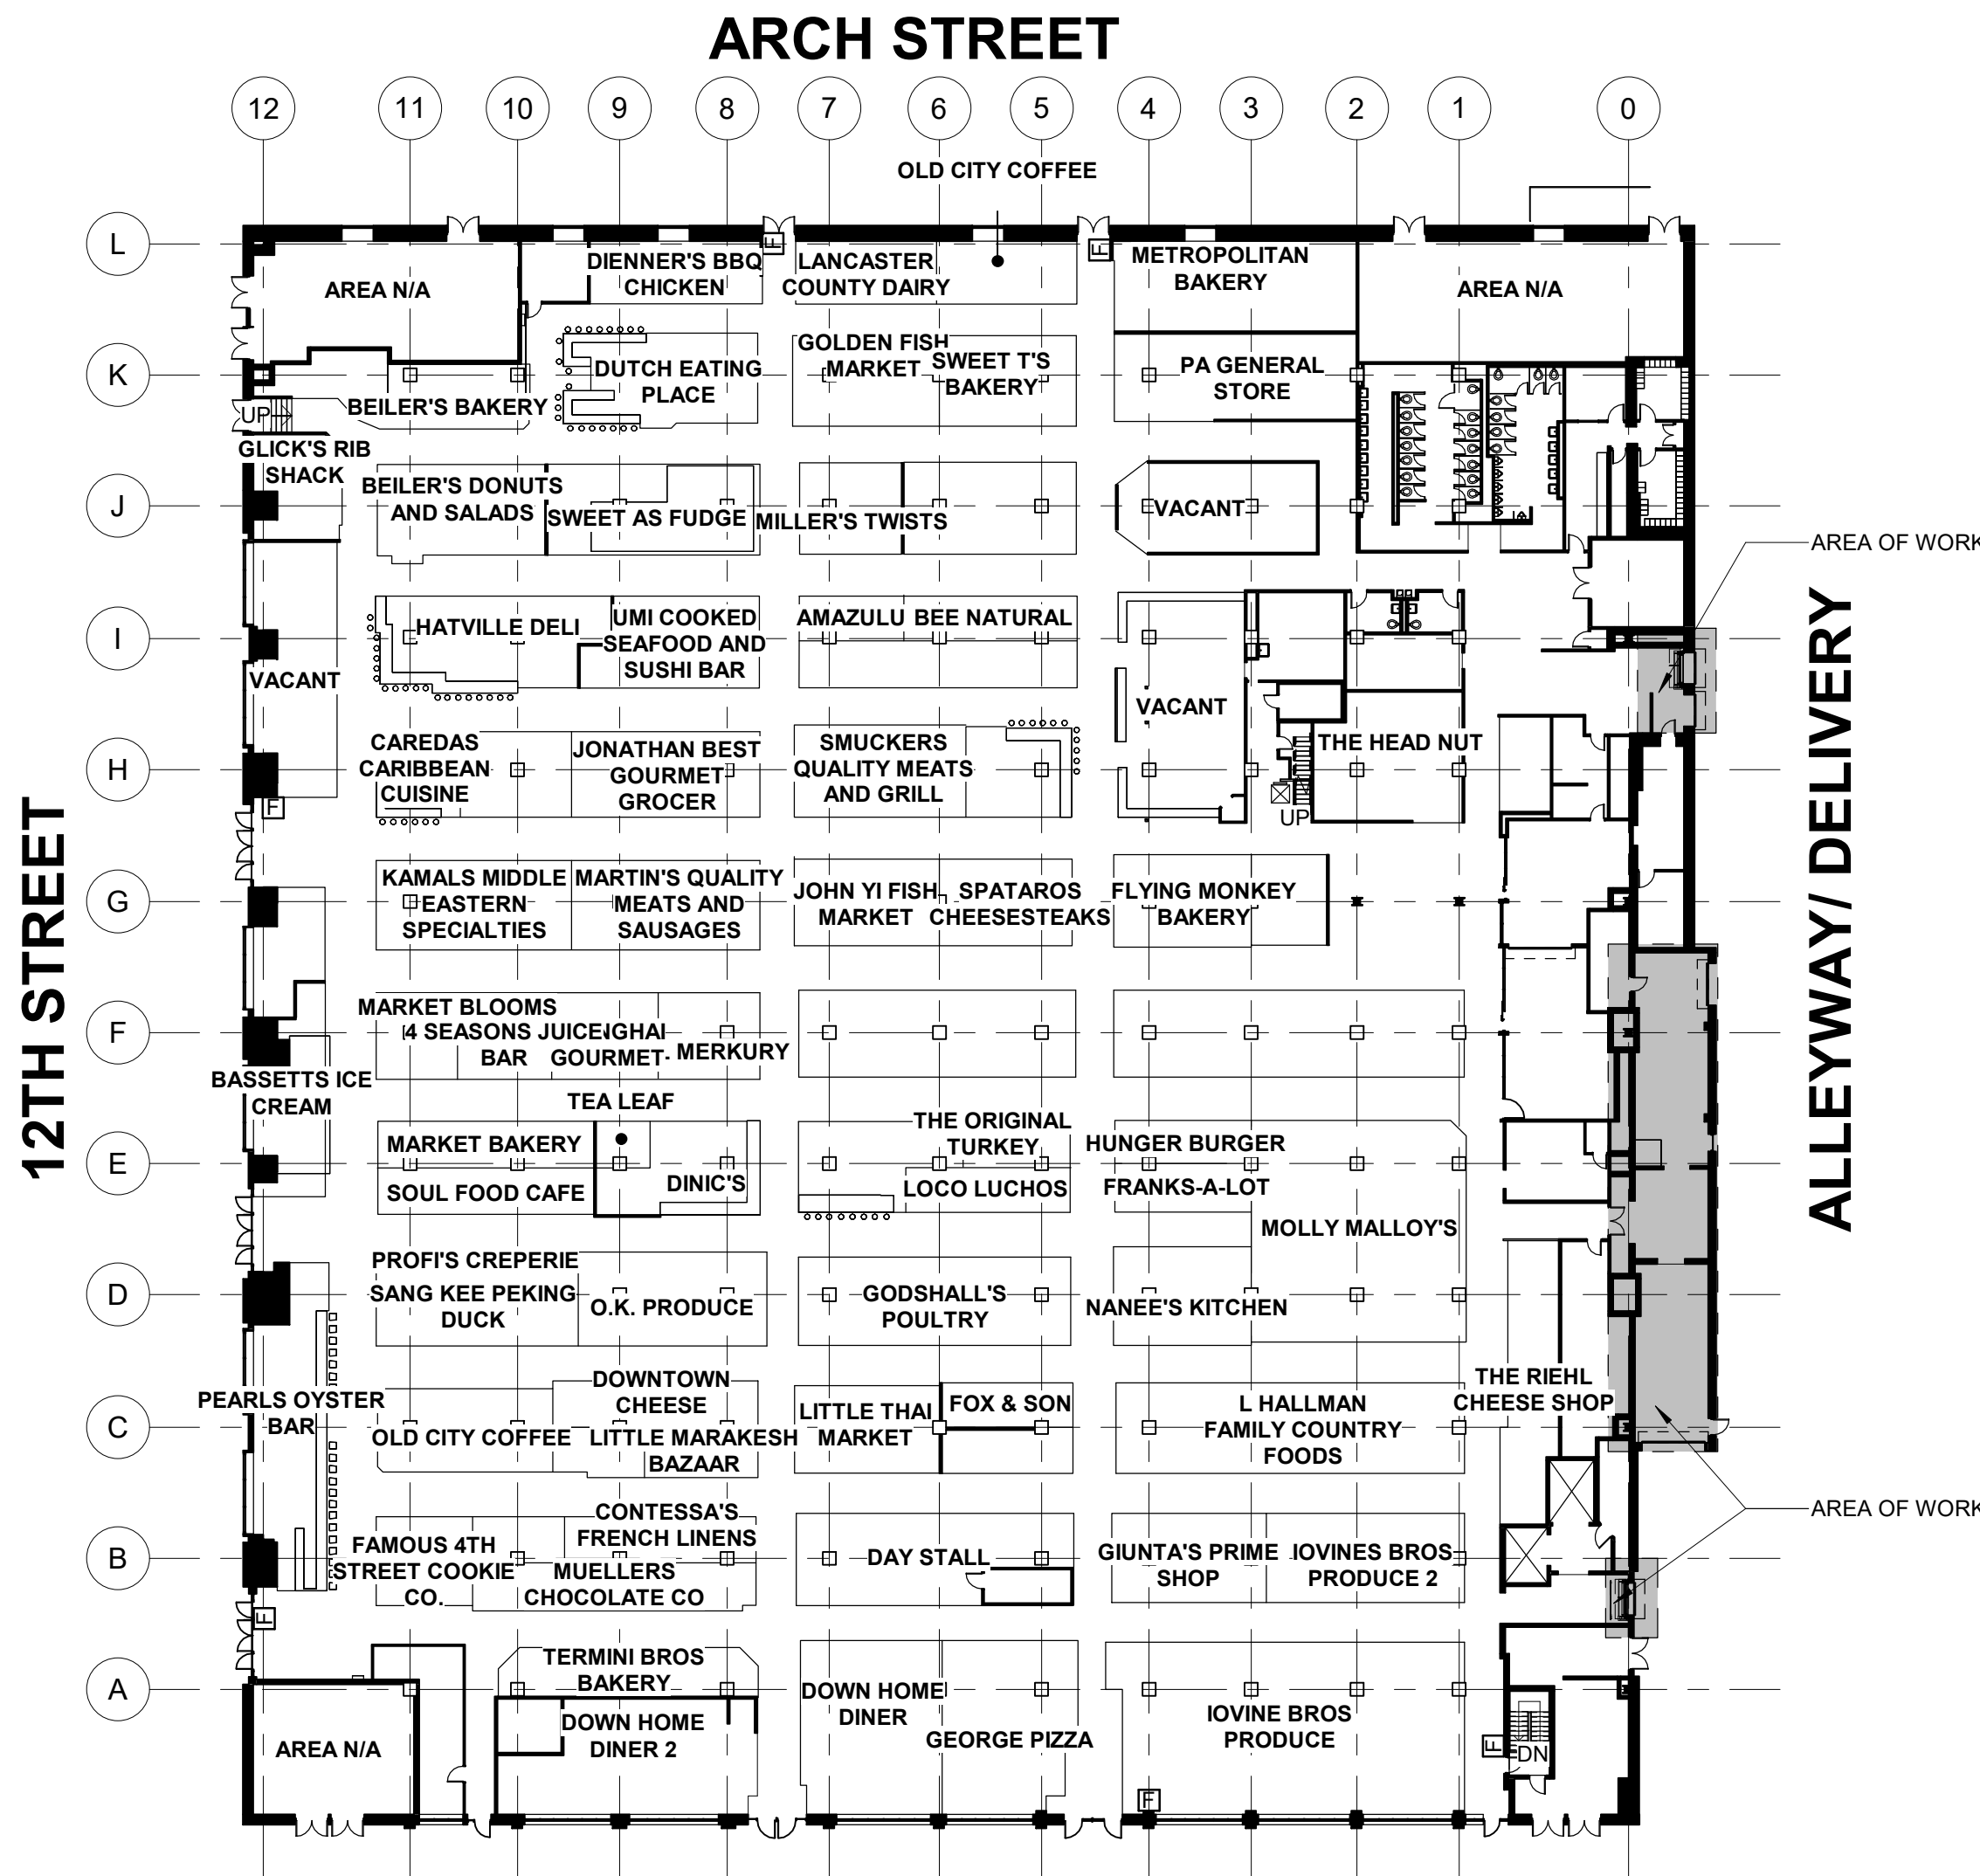

OVERALL BASEMENT PLAN
SCALE: 1/32" = 1'-0"

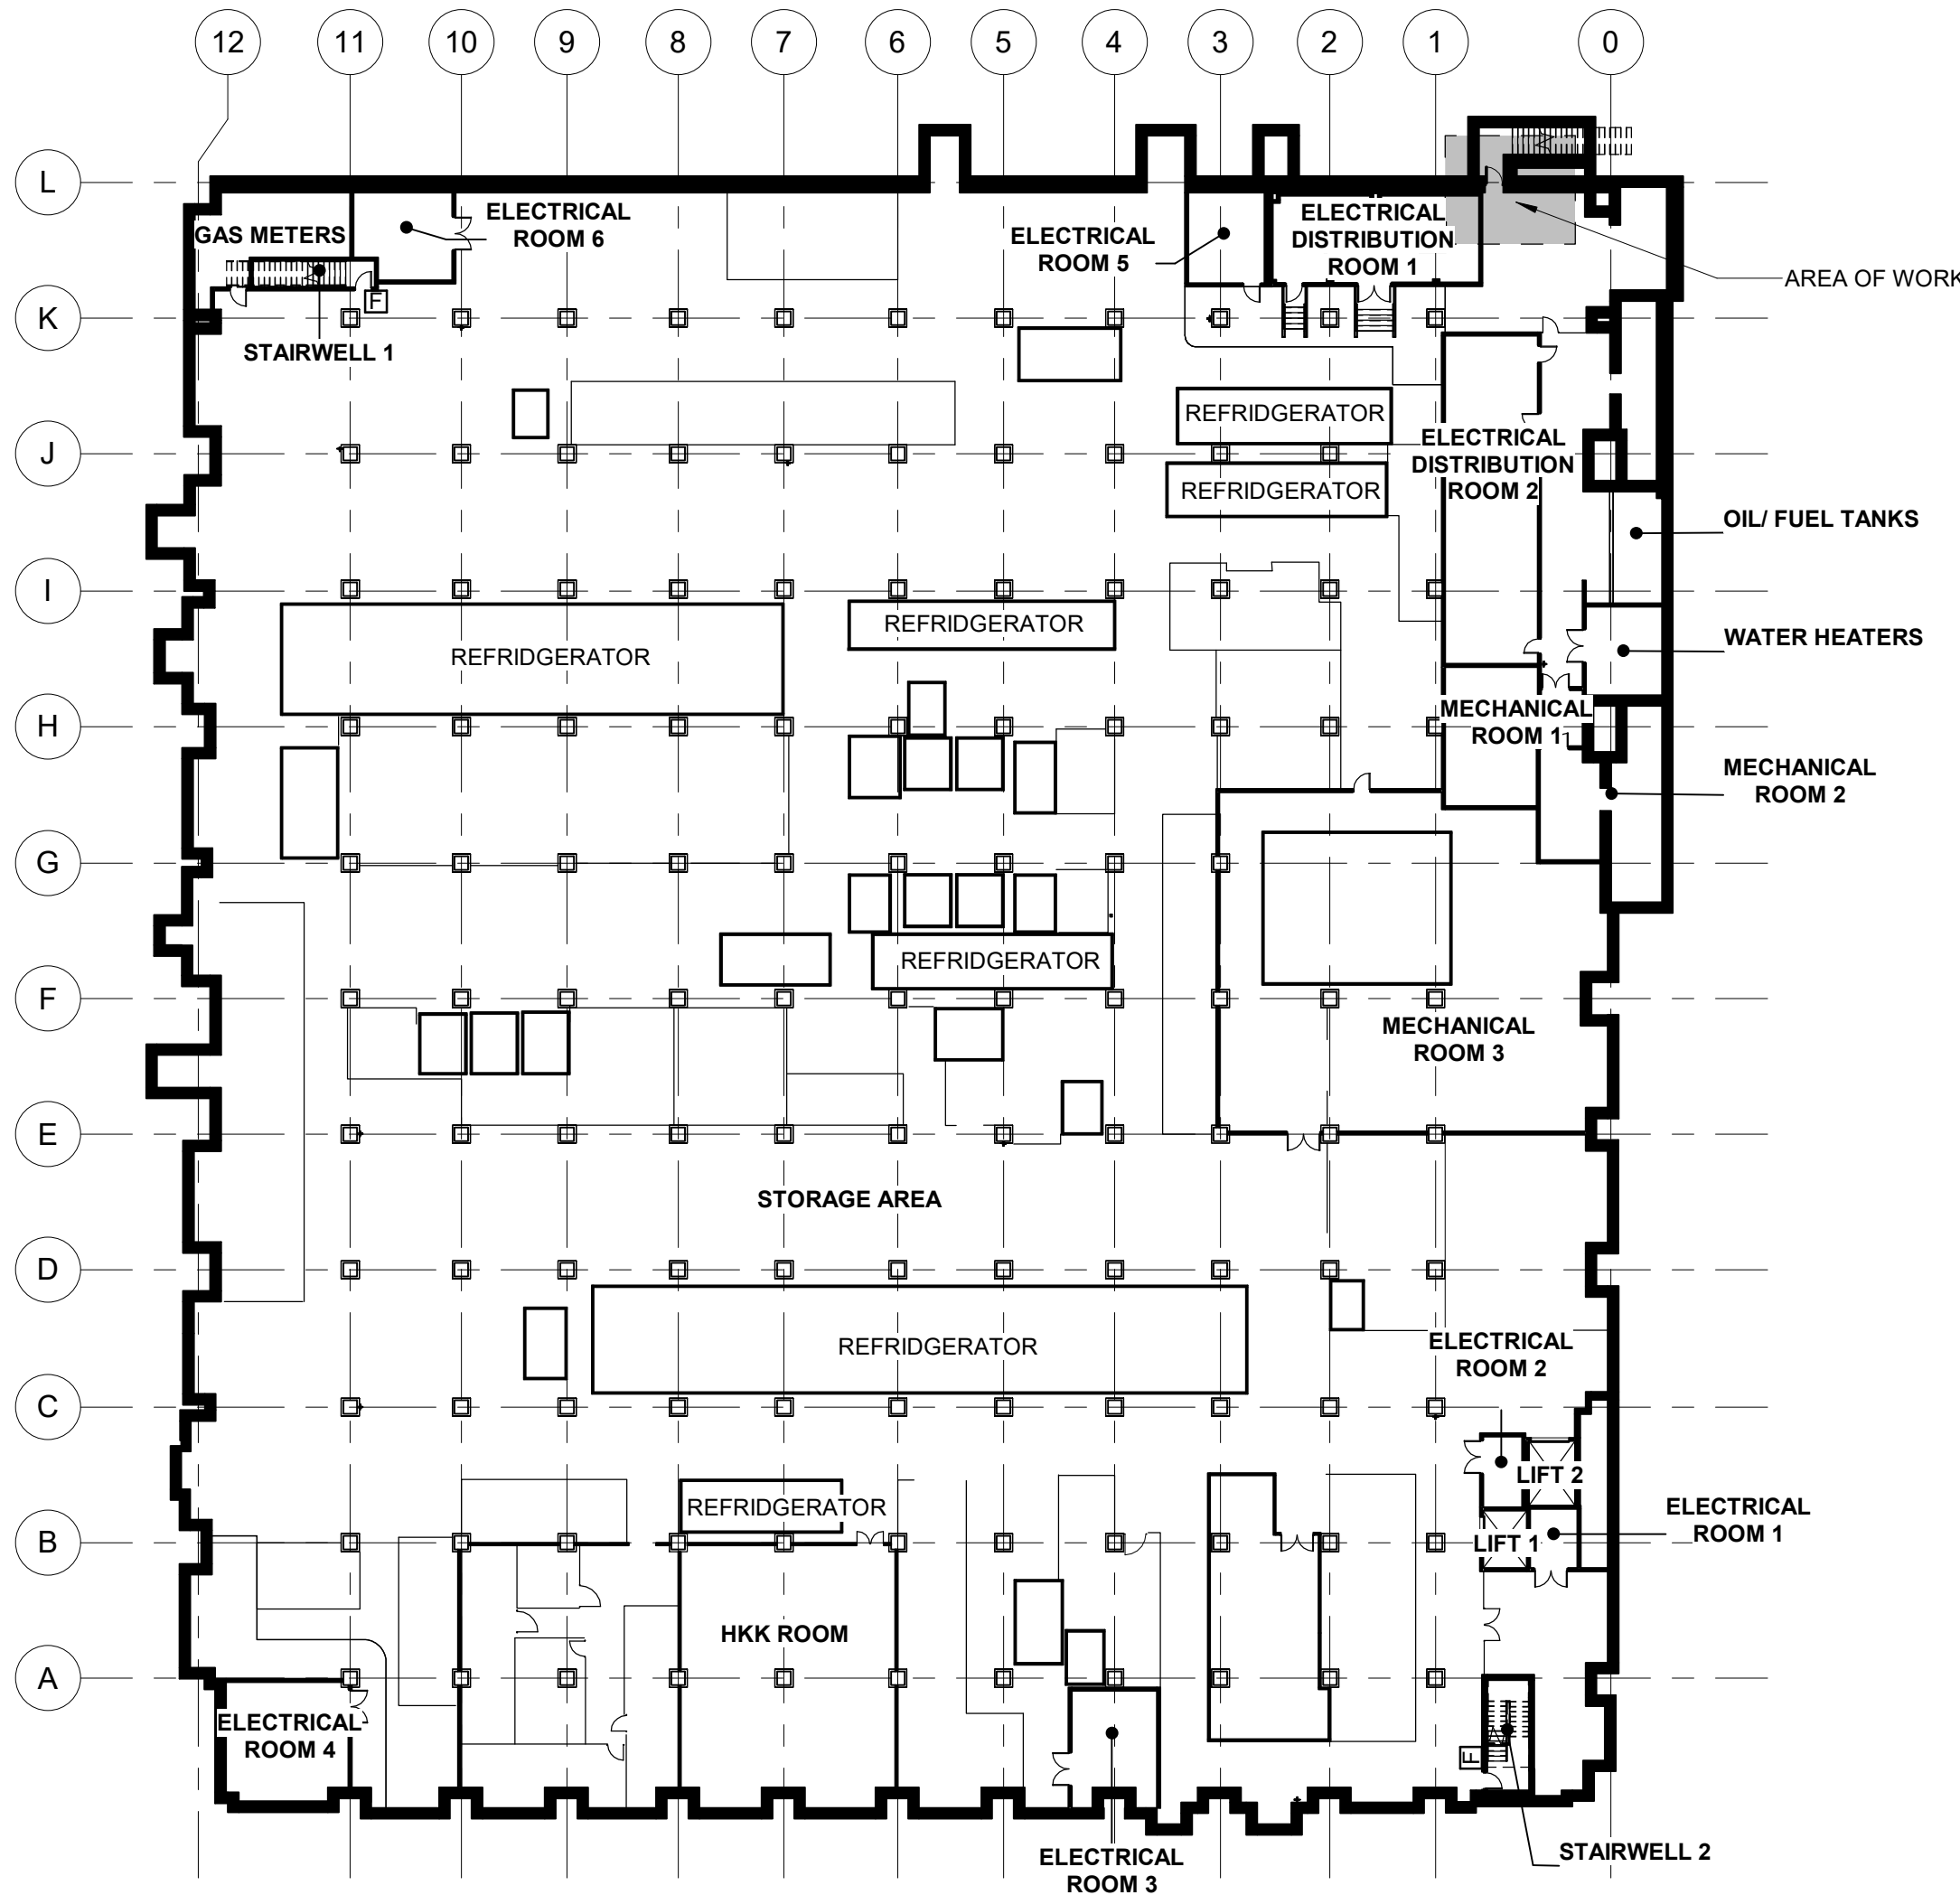BUILDING CODE SUMMARY

READING TERMINAL MARKET
PHILADELPHIA, PA

PROJECT DESCRIPTION: ARCHITECTURAL REPAIRS, PLUMBING REPLACEMENTS, MECHANICAL REPLACEMENTS, AND ELECTRICAL REPLACEMENTS ARE PROPOSED FOR THIS PROJECT. THERE IS NO CHANGE IN OCCUPANCY OR USE. REFER TO THE SUMMARY OF WORK.

APPLICABLE CODE(S):
THE PHILADELPHIA BUILDING CONSTRUCTION AND OCCUPANCY CODE (PBCOC)
INTERNATIONAL EXISTING BUILDING CODE (IEBC) 2018, ALTERATION LEVEL 2.

ALT 2 - THE RECONFIGURATION OF SPACE, THE ADDITION OR ELIMINATION OF ANY DOOR OR WINDOW, THE RECONFIGURATION OR EXTENSION OF ANY SYSTEM OR THE INSTALLATION OF ANY ADDITIONAL EQUIPMENT.

OCCUPANCY CLASSIFICATION:

THERE IS NO CHANGE IN OCCUPANCY OR USE GROUP FOR THIS SCOPE OF WORK.

HISTORIC BUILDING:

THE READING TERMINAL MARKET IS LISTED ON THE NATIONAL REGISTER OF HISTORIC PLACES AND THE PHILADELPHIA REGISTER OF HISTORIC PLACES. THE PROPOSED WORK INCLUDES REPAIRS AND REPLACEMENTS, AND SHOULD NOT IMPACT THE HISTORIC NATURE OF THE SPACE.

SUMMARY OF WORK:

BASEMENT - EXTERIOR DOOR B01:

- REMOVE EXISTING HOLLOW METAL DOOR AND FRAME, AND REPLACE WITH NEW FIBERGLASS DOOR AND FRAME.
- PROVIDE ALL NEW DOOR HARDWARE.
- INSTALL NEW SURFACE-MOUNTED DOOR CONTACT ON INTERIOR FACE OF DOOR AND RECONNECT TO SECURITY SYSTEM AS DIRECTED BY OWNER.
- CUT AND PATCH EXTERIOR CEMENT PLASTER WALL FINISH ADJOINING DOOR FRAME.
- SEAL PERIMETER JOINTS OF FRAME ON INTERIOR AND EXTERIOR.
- INFILL OPEN PENETRATION AROUND EXISTING CONDUIT IN MASONRY WALL ABOVE DOOR; SEAL WEATHERTIGHT.

GROUND FLOOR - STORAGE/RECYCLING AND TRASH COMPACTOR ROOMS:

- OWNER WILL TEMPORARILY REMOVE, IN TWO PHASES, ALL MOVABLE EQUIPMENT AND OTHER NON-FIXED ITEMS STORED IN THESE SPACES.
- CLEAN, REPAIR, AND OTHERWISE PREPARE CONCRETE FLOOR SURFACE TO RECEIVE APPLIED FINISH.
- INSTALL THICKSET FLUID-APPLIED EPOXY FLOOR FINISH SYSTEM.
- COORDINATE WORK WITH PLUMBING CONTRACTOR AND PLUMBING ALTERATIONS.

GROUND FLOOR - EXTERIOR DOORS 01 & 02:

- THE EXISTING OVERHEAD METAL COILING SERVICE DOORS ON EXTERIOR OF THE OPENINGS ARE TO REMAIN UNDISTURBED, IN PLACE, AND IN USE.
- COORDINATE WORK WITH ELECTRICAL CONTRACTOR AND ELECTRICAL ALTERATIONS (SEE ELECTRICAL CONTRACT DESCRIPTION).
- PREPARE EXISTING OPENINGS AND INSIDE FACE OF WALLS FOR NEW RAPID-OPENING OVERHEAD DOORS. REMOVE EXISTING PLASTIC STRIP BARRIER ASSEMBLIES FROM THE OPENINGS. SELECTIVELY REMOVE EXISTING WOOD RAILS AND TRIM AS INDICATED; SECURELY FASTEN REMAINING PORTIONS OF RAILS AND TRIM.
- DESIGN, FABRICATE, AND INSTALL STEEL FOREFRAME ASSEMBLIES FOR SUPPORT OF NEW RAPID-OPENING OVERHEAD DOORS. SECURELY ANCHOR FOREFRAMES BY BOLTING TO EXISTING MASONRY OR WELDING TO EXISTING-TO-REMAIN STEEL ASSEMBLIES IN THE OPENINGS. PAINT FOREFRAMES AFTER INSTALLATION.
- FURNISH, ASSEMBLE, AND INSTALL NEW RAPID-OPENING OVERHEAD DOORS.
 - ANCHOR TO FOREFRAME ASSEMBLIES AND/OR EXISTING MASONRY WALLS.
 - INSTALL MOTOR CONTROLLER AND WIRED CONNECTIONS TO MOTOR AND MAIN POWER DISCONNECT.
 - INSTALL DOOR ACTIVATION AND SAFETY DEVICES AND RELATED POWER/CONTROL WIRING AND CONNECTIONS.
 - SEAL PERIMETERS OF FOREFRAMES AND NEW OVERHEAD DOOR ASSEMBLIES WEATHERTIGHT.
- TEST OPERATION OF NEW DOORS. DEMONSTRATE TO AND TRAIN OWNER'S PERSONNEL.

PLUMBING:

- REPLACE THE EXISTING EMERGENCY SHOWER WITH A NEW EMERGENCY EYE/FACE WASH FIXTURE, MIXING VALVE AND ALARM IN THE TRASH ROOM.
- REMOVE COLD WATER PIPING, VALVES AND HOSE BIBS THROUGHOUT THE TRASH ROOM AND INSTALL NEW PIPING, INSULATION, VALVES AND HOSE BIBS.
- REMOVE THE (3) EXISTING WALL HYDRANTS ON THE EXTERIOR OF THE BUILDING. REMOVE COLD WATER PIPING BACK INTO THE BUILDING. PROVIDE NON-FREEZE WALL HYDRANT, BALL VALVE, COLD WATER PIPING AND INSULATION.
- REMOVE AND REPLACE TRENCH DRAINS AND ASSOCIATED PIPING IN TRASH / STORAGE ROOM UP TO THE EXTERIOR ENVELOPE.

MECHANICAL:

- REPLACE HEAT PUMPS.
- CLEAN DUCTWORK.
- REMOVE ELECTRIC AIR CURTAIN HEATERS AT GROUND FLOOR DOORS 01 & 02. SALVAGE FOR OWNER. COORDINATE DISCONNECTION WITH ELECTRICAL CONTRACTOR.

ELECTRICAL:

- BASEMENT - DOOR B01
 - REMOVE EXISTING DOOR CONTACT. REPLACE WITH NEW CONTACT AFTER INSTALLATION OF NEW DOOR AND FRAME. RECONNECT TO SECURITY SYSTEM AS DIRECTED BY OWNER.
- GROUND FLOOR - EXTERIOR DOORS 01 & 02 - NEW RAPID-OPENING OVERHEAD DOORS:
 - DISCONNECT EXISTING ELECTRIC AIR CURTAIN HEATERS.
 - RELOCATE AND RECONNECT EXISTING ACTIVE WIRING, CONDUITS, BOXES, AND DEVICES THAT WILL OBSTRUCT WITH THE NEW OVERHEAD DOOR WORK.
 - REMOVE ANY INACTIVE/ABANDONED ELECTRICAL WORK THAT WILL OBSTRUCT THE NEW OVERHEAD DOOR WORK.
 - PROVIDE MAIN DISCONNECT AND POWER FOR THE NEW OVERHEAD DOORS.
- HEAT PUMP REPLACEMENTS:
 - PROVIDE RELATED POWER REMOVALS AND NEW CONNECTIONS.



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READING TERMINAL MARKET CAPITAL IMPROVEMENTS

NO.	DATE	DESCRIPTION
REVISIONS		
GENERAL PACKAGE		
PROJECT NUMBER: 071274		
DESIGNED: TY	MODELED: EVH	CHECKED: JS
DATE: 02/03/23		
DRAWING TITLE: GENERAL		
CODE FLOOR PLANS		
DRAWING NO.: G002		

Local File Autodesk Docs\\071274-RTM_Renovation_Project\\071274_ReadTermMarket_A_R322.rvt
Central File: BM0801_A_cerital R320.rvt

Project Number: 071274
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ABBREVIATIONS

ABV	ABOVE	GA	GAUGE / GAGE	R	RADIUS
AC	AIR CONDITIONING	GALV	GALVANIZED	R	RISER
ACST	ACOUSTIC	GAR	GARAGE	R	ROOF DRAIN
ADCL	ADDITIONAL	GEN	GENERATOR	RECP	RECEPTACLE
ADJ	ADJACENT	GFCI	GOVERNMENT FURNISHED, CONTRACTOR INSTALLED	REFR	REFRIGERATOR
AFF	ABOVE FINISH FLOOR			REG	REGISTER
AGGR	AGGREGATE	GFGI	GOVERNMENT FURNISHED, GOVERNMENT INSTALLED	REIN	REINFORCE
AL	ALUMINUM			REOD	REQUIRED
ALT	ALTERNATE	GL	GLASS	RET	RETURN
ARCH	ARCHITECTURAL	GLU-LAM	GLUE-LAMINATED	REV	REVISION
ASB	ASBESTOS	GOVT	GOVERNMENT	RFG	ROOFING
ASPH	ASPHALT	GR	GRADE	RH	RIGHT HAND
ASSN	ASSOCIATION	GRD	GROUND	RM	ROOM
ASST	ASSISTANT	GVL	GRAVEL	RWC	RAIN WATER CONDUCTOR
ASSY	ASSEMBLY	GYP	GYP SUM		
AVE	AVENUE			S	SOUTH
AVG	AVERAGE	H	HIGH	SAPC	SUSPENDED ACOUSTICAL PANEL CEILING
		HDWE	HARDWARE	SCHED	SCHEDULE
B	BOTTOM	HM	HOLLOW METAL	SDG	SIDING
BALC	BALCONY	HORIZ	HORIZONTAL	SEC	SECTION
BD	BOARD	HPT	HIGH POINT	SF	SQUARE FOOT
BETW	BETWEEN	HT	HEIGHT	SGFT	STRUCTURAL GLAZED FACING TILE
BLDG	BUILDING	HTR	HEATER	SH	SHOWER
BLKG	BLOCKING	HVAC	HEATING, VENTILATION AND AIR CONDITIONING	SHM	SECURITY HOLLOW METAL
BLR	BOLTER			SHI	SHEET
BM	BEAM			STVY	STAIRWAY
BM	BENCHMARK			SUP	SUPERINTENDENT
BP	BASE PLATE	I.E.	THAT IS	SUPVR	SUPERVISOR
BRDG	BRIDGING	ICF	INSULATED CONCRETE FORM	SURF	SURFACE
BRG	BEARING	ID	INSIDE DIAMETER	SUSP	SUSPENDED / SUSPENSION
BS	BOTH SIDES	IH	INTAKE HOOD	SYS	SYSTEM
BSMT	BASEMENT	INSUL	INSULATED	T	TREAD
		INTR	INTERIOR	T&B	TOP AND BOTTOM
CAB	CABINET	JST	JOIST	T&G	TONGUE AND GROOVE
CAP	CAPACITY	JT	JOINT	TJ	TOP OF
CDR	COLING DOOR			TAN	TANGENT
CDR	CERAMIC			TEL	TELEPHONE
CFCI	CONTRACTOR FURNISHED, CONTRACTOR INSTALLED	L	LONG	TEMP	TEMPERORARY
CFGI	CONTRACTOR FURNISHED, GOVERNMENT INSTALLED	LAB	LABORATORY	TER	TERRAZZO
		LAM	LAMINATE	THRU	THROUGH
CI	CAST IRON	LAV	LAVATORY	TLT	TOILET
CIP	CAST IRON PIPE	LG	LENGTH	TRTD	TREATED
CJ	CONTROL JOINT	LH	LEFT HAND	TRY	TYPICAL
CL	CENTERLINE	LIB	LIBRARY		
CLG	CEILING	LN	LINEAR	UNO	UNLESS NOTED OTEHRWISE
CLO	CLOSET	LL	LIVE LOAD	VAT	VINYL ASBESTOS TILE
CLR	CLEAR	LLH	LONG LEG HORIZONTAL	VCT	VINYL COMPOSITION TILE
		LLV	LONG LEG VERTICAL	VERT	VERTICAL
CMU	CONCRETE MASONRY INSULATED UNIT	LPT	LOW POINT	VIF	VERIFY IN FIELD
CMU	CONCRETE MASONRY UNIT	LT	LIGHT	VTR	VERTICAL
CNO	CONCEALED	LWC	LIGHTWEIGHT CONCRETE		
CO	CLEANOUT			W	WEST
CO	COMPANY	M	METER	W	WIDE
COL	COLUMN	MAINT	MAINTENANCE	W/	WITH
COMP	COMPOSITION	MAS	MASONRY	W/O	WITHOUT
CONC	CONCRETE	MATL	MATERIAL	WC	WATER CLOSET
CONSTR	CONSTRUCTION	MAX	MAXIMUM	WD	WOOD
CONT	CONTINUOUS	MECH	MECHANICAL	WDR	WOOD DOOR
CPT	CARPET	MEMB	MEMBRANE	WH	WATER HEATER
CRV	CURVED	MET	METAL	WTRPRF	WATERPROOFING
CSK	CONTERSINK/COUNTERSUNK	MEZZ	MEZZANINE	WWF	WELDED WIRE FABRIC
CTD	COATED	MFR	MANUFACTURER	XFMR	TRANSFORMER
CTR	CENTER	MGR	MANAGER		
CUH	CABINET UNIT HEATER	MH	MANHOLE		
		MIL	MILITARY		
D	DEPTH	MIN	MINIMUM		
DBL	DOUBLE	MISC	MISCELLANEOUS		
DEG	DEGREE	ML	METAL LATH		
DEP	DEPARTMENT	MOLDG	MOLDING		
DET	DETAIL	MLP	METAL LATH AND PLASTER		
DIA	DIAMETER	MM	MILLIMETER		
DIAG	DIAGONAL	MO	MASONRY OPENING		
DIM	DIMENSION	MOD	MOTOR OPERATED DAMPER		
DIV	DIVISION	MTG	MOUNTING		
DL	DEAD LOAD	N	NORTH		
DMPF	DAMP-PROOFING	NA	NOT APPLICABLE		
DN	DOWN	NC	NOT IN CONTRACT		
DR	DOOR	NO	NUMBER		
DS	DOWNSPOUT	NRC	NOISE-REDUCTION COEFFICIENT		
DW	DISHWASHER	NTS	NOT TO SCALE		
DWG	DRAWING				
		OA	OVERALL		
E	EAST	OC	ON CENTER		
E.G.	FOR EXAMPLE	OD	OUTSIDE DIAMETER		
EA	EACH	OFF	OFFICE		
EF	EXHAUST FAN	OH	OPPOSITE HAND		
EGEN	EMERGENCY GENERATOR	CHDR	OVERHEAD DOOR		
EIFS	EXTERIOR INSULATION AND FINISH SYSTEM	OPNG	OPENING		
		OPP	OPPOSITE		
EL	ELEVATION	OSB	ORIENTED STRAND BOARD		
ELEC	ELECTRICAL				
ELEV	ELEVATOR	P/L	PROPERTY LINE		
ENTR	ENTRANCE	PASS	PASSENGER		
EQ	EQUAL	PERF	PERFORATED		
EQUIP	EQUIPMENT	PL	PLATE		
EWC	ELECTRIC WATER COOLER	PLAM	PLASTIC LAMINATE		
EXH	EXHAUST	PLAS	PLASTER		
EXIST	EXISTING	PLBG	PLUMBING		
EXP	EXPANSION	PLYWD	PLYWOOD		
EXT	EXTERIOR	PNL	PANEL		
		PNT	PAINT		
FAB	FABRICATE	PORC	PORCELAIN		
FBD	FIBERBOARD	PR	PAIR		
FD	FLOOR DRAIN	PREFAB	PREFABRICATED		
FDN	FOUNDATION	PROJ	PROJECT		
FDR	FIRE DOOR	PSF	POUNDS PER SQUARE FOOT		
FE	FIRE EXTINGUISHER	PSI	POUNDS PER SQUARE INCH		
FEC	FIRE EXTINGUISHER CABINET	PT	POINT		
FHY	FIRE HYDRANT	PTD	PAINTED		
FIN	FINISH	PTN	PARTITION		
FL	FLASHING	PVC	POLYVINYL CHOLRIDE		
FLEX	FLEXIBLE				
FLG	FLANGE				
FLR	FLOOR	QTF	QUARRY TILE FLOOR		
FLRG	FLOORING				
FP	FIREPROOF				
FRP	FIBER-REINFORCED PLASTIC				
FRT	FIRE RETARDANT TREATED				
FTG	FOOTING				
FURN	FURNITURE				

GENERAL DEMOLITION NOTES

- 1 UNOBSTRUCTED ACCESS TO EXISTING EMERGENCY EXITS SHALL BE MAINTAINED AT ALL TIMES.
- 2 ALL DEBRIS AND UNUSED MATERIAL RESULTING FROM DEMOLITION SHALL BE DISPOSED OF OFF SITE IN COMPLIANCE WITH ALL LOCAL, STATE, AND FEDERAL AUTHORITIES.
- 3 REMOVE EXISTING EQUIPMENT, & DEVICES AS INDICATED.
- 4 REMOVAL OF EXISTING HVAC & PLUMBING FIXTURES & SAFING TO BE BY APPROPRIATE TRADES.
- 5 ALL CONTRACTORS ARE TO REPORT ALL UNEXPECTED, UNCOVERED EXISTING CONDITIONS WHICH IMPACT LAYOUT OF NEW WORK IMMEDIATELY TO ARCHITECT.
- 6 FOR EXTENT & SCOPE OF PLUMBING, MECHANICAL & ELECTRICAL REMOVALS, SEE INDIVIDUAL TRADE DRAWINGS.
- 7 CARE MUST BE TAKEN NOT TO DAMAGE EXISTING CONSTRUCTION, COORDINATE TIME OF LOUD/HEAVY NOISE CONSTRUCTION WITH OWNER TO LIMIT DISTURBANCE.
- 8 PROVIDE PORTABLE LIGHTING DURING DEMOLITION & CONSTRUCTION AS REQUIRED.
- 9 PROVIDE DUMPSTERS AND OTHER DEMOLITION EQUIPMENT AS REQUIRED.
- 10 REMOVE EXISTING WORK AS REQUIRED TO ACCOMMODATE NEW WORK, INCLUDING EXISTING WALL & FLOOR FINISHES IN SPACES SCHEDULED TO BE REFINISHED.
- 11 PROVIDE APPROPRIATE FULL HEIGHT PROTECTION/TEMPORARY PARTITIONS PRIOR TO COMMENCING DEMOLITION, PLACED IN LOCATIONS APPROVED BY OWNER.
- 12 ALL BUILDING ACCESS AND REMOVAL OF MATERIALS MUST BE APPROVED BY OWNER.
- 13 COORDINATE CONSTRUCTION SCHEDULE WITH THE OWNER AND PROVIDE A PHASING PLAN/SCHEDULE FOR REVIEW. WORK WHICH MAY INTERRUPT BUSINESS OPERATIONS MUST BE RETURNED TO SERVICE EACH DAY PRIOR TO BUSINESS HOURS.

GENERAL NOTES

- 1 ALL WORK TO CONFORM TO REQUIREMENTS OF THE GOVERNING BUILDING CODE, OSHA AND ALL OTHER APPLICABLE CODES, RULES, REGULATIONS, ORDINANCES, ETC. IN THEIR LATEST EDITION, CONFORM ALL WORK TO REQUIREMENTS OF ALL AUTHORITIES HAVING JURISDICTION.
- 2 ALL WORK THAT IS IMPLIED OR REASONABLY INFERRED BY THE DRAWINGS IS THE RESPONSIBILITY OF THE CONTRACTOR. THE INCLUSION OF ANY AND ALL WORK BY MENTION, NOTATION, DETAIL, ITEMIZATION OR IMPLICATION, HOWEVER BRIEF, MEANS THAT THE CONTRACTOR TO PROVIDE AND INSTALL SAME AT NO ADDITIONAL COST OR BURDEN TO THE OWNER. ALL WORK PERFORMED TO INCLUDE ALL APPURTENANCES AND APPARATUS NORMALLY DEEMED TO BE PART OF A COMPLETE PACKAGE WITHIN THE DEFINITIONS OF ORDINARY INDUSTRY STANDARDS. ALL TRADES ARE RESPONSIBLE FOR REVIEWING THE ENTIRE SET OF DRAWINGS THEREBY NOTING AND INCLUDING THEIR WORK AS APPLICABLE. THE INTENT OF THE DRAWING SET IS TO RESULT IN A COMPLETE AND FINISHED PROJECT IN ALL REGARDS AT THE CONCLUSION OF THE WORK. INCLUDE ALL WORK, WHETHER SHOWN OR NOT, AS MAY BE NECESSARY TO ACCOMPLISH THE INTENDED RESULT.
- 3 APPLY AND PAY FOR ALL PERMITS, INSPECTIONS, APPROVALS, ETC. ARRANGE AND COORDINATE ALL REQUIRED INSPECTIONS AND SECURE ALL NECESSARY APPROVALS OF THE WORK.
- 4 BECOME FAMILIAR WITH THE PROJECT THROUGH INSPECTION OF THE SITE AND REVIEW OF THE DRAWINGS SO AS TO THOROUGHLY UNDERSTAND THE NATURE AND REQUIREMENTS OF THE WORK. ANY AND ALL DISCREPANCIES OR OMISSIONS TO BE REPORTED TO THE OWNER PRIOR TO THE COMMENCEMENT OF ANY WORK AFFECTED BY SUCH DISCREPANCY OR OMISSION. ENSURE THAT DISCREPANCIES OR OMISSIONS ARE REPORTED AND CLARIFICATION OBTAINED PRIOR TO WORK BEING PERFORMED. ANY AND ALL WORK PROCEEDING OTHERWISE AND THEN FOUND TO BE INCORRECT OR INCONSISTENT WITH THE INTENDED RESULT WILL BE REMOVED, REPLACED AND/OR CORRECTED BY THE CONTRACTOR AT NO ADDITIONAL COST OR BURDEN TO THE OWNER. VERIFY ALL DIMENSIONS AND LOCATIONS IN THE FIELD. COORDINATE ALL WORK WITH CONDITIONS ENCOUNTERED IN THE FIELD AND MAKE ALL NECESSARY ADJUSTMENTS ACCORDINGLY.
- 5 CONTRACTOR IS RESPONSIBLE FOR FINAL FIT, FINISH, APPEARANCE AND PERFORMANCE OF ALL WORK.
- 6 VERIFY ALL DIMENSIONS AND CONDITIONS AT THE WORK SITE PRIOR TO THE COMMENCEMENT OF WORK.
- 7 VERIFY EXISTING CONDITIONS AFFECTING THE WORK PRIOR TO BIDDING AND ALL ASPECTS OF THE WORK PRIOR TO COMMENCEMENT.
- 8 APPLY, INSTALL OR UTILIZE ALL MATERIALS IN ACCORDANCE WITH MANUFACTURER'S PRINTED LITERATURE.
- 9 ALL WORK TO BE PERFORMED IN A FIRST-CLASS WORKMANLIKE MANNER, MATCHING AND ALIGNING ALL SURFACES SO AS TO AFFORD A NEAT FINISHED APPEARANCE. CLEAN ALL SURFACES FREE OF SOIL, DIRT, REFUSE AND DEBRIS RESULTANT FROM THE WORK. ALL ADJACENT SURFACES TO BE LEFT AS THEY APPEARED PRIOR TO COMMENCEMENT OF THE WORK. PROVIDE ADEQUATE PROTECTION OF ALL ADJACENT AND EXISTING SURFACES TO REMAIN SUFFICIENT TO ENSURE AGAINST DAMAGE DURING CONSTRUCTION OPERATIONS. AT CONCLUSION OF THE WORK, ALL FINISHED EXPOSED SURFACES INCLUDING GLASS, ALUMINUM AND FINISHED HARDWARE TO BE THOROUGHLY CLEANED TO THE SATISFACTION OF THE OWNER.
- 10 ALL WORK TO BE PROPERLY AND ADEQUATELY PROTECTED FROM DAMAGE AT ALL TIMES REGARDLESS OF THE STAGE OF COMPLETION. TAKE RESPONSIBILITY FOR SAFETY AT ALL TIMES, IN ALL PLACES AND UNDER ALL CONDITIONS AFFECTING OR AFFECTED BY THE WORK. ADHERE TO ALL ACCEPTED SAFETY PRACTICES AND PROVIDE ALL FENCES, BARRICADES, GUARDRAILS, PARTITIONS, ETC. AS MAY BE NECESSARY IN ORDER TO PROTECT LIFE AND PROPERTY FROM INJURY OR DAMAGE AND AS MAY BE REQUIRED BY ANY AND ALL AUTHORITIES HAVING JURISDICTION. REPAIR ANY AND ALL DAMAGE TO THE PREMISES ARISING FROM OR ASSOCIATED WITH WORK SITE OPERATIONS AND/OR ACTIVITIES CONNECTED TO THE WORK.
- 11 LEAVE ALL CHASES, HOLES, OPENINGS, ETC. PLUMB LEVEL, TRUE AND OF A PROPER SIZE OR CUT SAME INTO EXISTING WORK AS MAY BE NECESSARY FOR PROPER INSTALLATION OF WORK. CONSULT, CONFIR AND OTHERWISE COORDINATE WITH ANY AND ALL OTHER CONTRACTORS AND CONCERNED PARTIES REGARDING PROPER LOCATION, SIZE, PLACEMENT, ALIGNMENT AND ORIENTATION OF SAME. IN CASE OF ANY FAILURE TO LEAVE OR CUT SUCH OPENINGS OR OTHERWISE LEAVE SUCH ACCOMMODATIONS IN PROPER PLACE, CUT THEM AFTERWARDS AT OWN EXPENSE. NO EXCESSIVE CUTTING WILL BE PERMITTED NOR ANY STRUCTURAL MEMBERS TO BE CUT WITHOUT THE CONSENT OF THE ARCHITECT.
- 12 ALL EQUIPMENT TO BE INSTALLED IN ACCORDANCE WITH MANUFACTURER'S RECOMMENDATIONS. ALL LABOR, EQUIPMENT AND MATERIAL, TO BE GUARANTEED AS PER PROJECT SPECIFICATIONS.
- 13 COMPLY WITH ALL OWNER SAFETY TRAINING REQUIREMENTS AND SITE PROCEDURES, AND COORDINATE THE FOREGOING WITH OWNER'S DESIGNATED REPRESENTATIVES.
- 14 PERFORM ALL WORK WITHOUT INTERFERING WITH OWNER'S NORMAL OPERATIONS.
- 15 PROJECT DOCUMENTS ARE INTENDED TO BE COMPLEMENTARY. ITEMS INDICATED IN ONE PLACE OR ANOTHER AMONG THE DOCUMENTS ARE INTENDED AS THOUGH SHOWN IN ALL PLACES.
- 16 COORDINATE ALL NEW WORK WITH ALL EXISTING CONDITIONS. EXISTING ELEMENTS AFFECTING THE WORK REQUIRE SUCH COORDINATION WHETHER OR NOT THEY ARE INDICATED IN THE DOCUMENTS.
- 17 DO NOT SCALE DRAWINGS FOR CONSTRUCTION PURPOSES.
- 18 ALL WORK IS GUARANTEED FOR A PERIOD OF ONE YEAR FROM DATE OF SUBSTANTIAL COMPLETION.

MATERIALS LEGEND

	BRICK
	CONCRETE MASONRY UNITS
	ACOUSTICAL CMU
	CMU
	STRUCTURAL GLAZED FACING TILE/ GLAZED CMU
	CONCRETE
	GYP SUM BOARD / GROUT
	BATT INSULATION
	RIGID INSULATION
	COARSE AGGREGATE / BALLAST
	STEEL
	ALUMINUM
	FINISH LUMBER
	DIMENSIONAL LUMBER
	SHIM
	PLYWOOD
	TILE / ACOUSTIC PANEL
	EARTH / SOIL

SYMBOLS LEGEND

	EXTERIOR ELEVATION REFERENCE ELEVATION REFERENCE DRAWING ON WHICH ELEVATION APPEARS
	BUILDING SECTION REFERENCE SECTION REFERENCE DRAWING ON WHICH SECTION APPEARS
	WALL SECTION REFERENCE SECTION REFERENCE DRAWING ON WHICH SECTION APPEARS
	DETAIL REFERENCE DETAIL REFERENCE DRAWING ON WHICH DETAIL APPEARS
	INTERIOR ELEVATION REFERENCE ELEVATION REFERENCE DRAWING ON WHICH DETAIL APPEARS
	ROOM IDENTIFICATION REFERENCE ROOM NAME ROOM NUMBER
	DOOR NUMBER REFERENCE
	L-2 LINTEL TYPE REFERENCE
	STRUCTURAL COLUMN REFERENCE
	TOILET ACCESSORY REFERENCE
	WALL PARTITION REFERENCE
	WINDOW TYPE REFERENCE
	LOUVER TYPE REFERENCE
	ROOM SIGN REFERENCE
	REVISION REFERENCE
	SHEET NOTE REFERENCE
	NORTH ARROW REFERENCE MAGNETIC NORTH BUILDING NORTH
	CEILING SYSTEM REFERENCE CEILING TYPE HEIGHT OF CEILING ABOVE FLOOR



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READING TERMINAL MARKET CAPITAL IMPROVEMENTS

NO. DATE DESCRIPTION

REVISIONS

GENERAL PACKAGE

PROJECT NUMBER:
071274

DESIGNED:
TY

MODELED:
EVH

CHECKED:
JS


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02/03/23

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GENERAL NOTES,
SYMBOLS, LEGENDS &
ABBREVIATIONS


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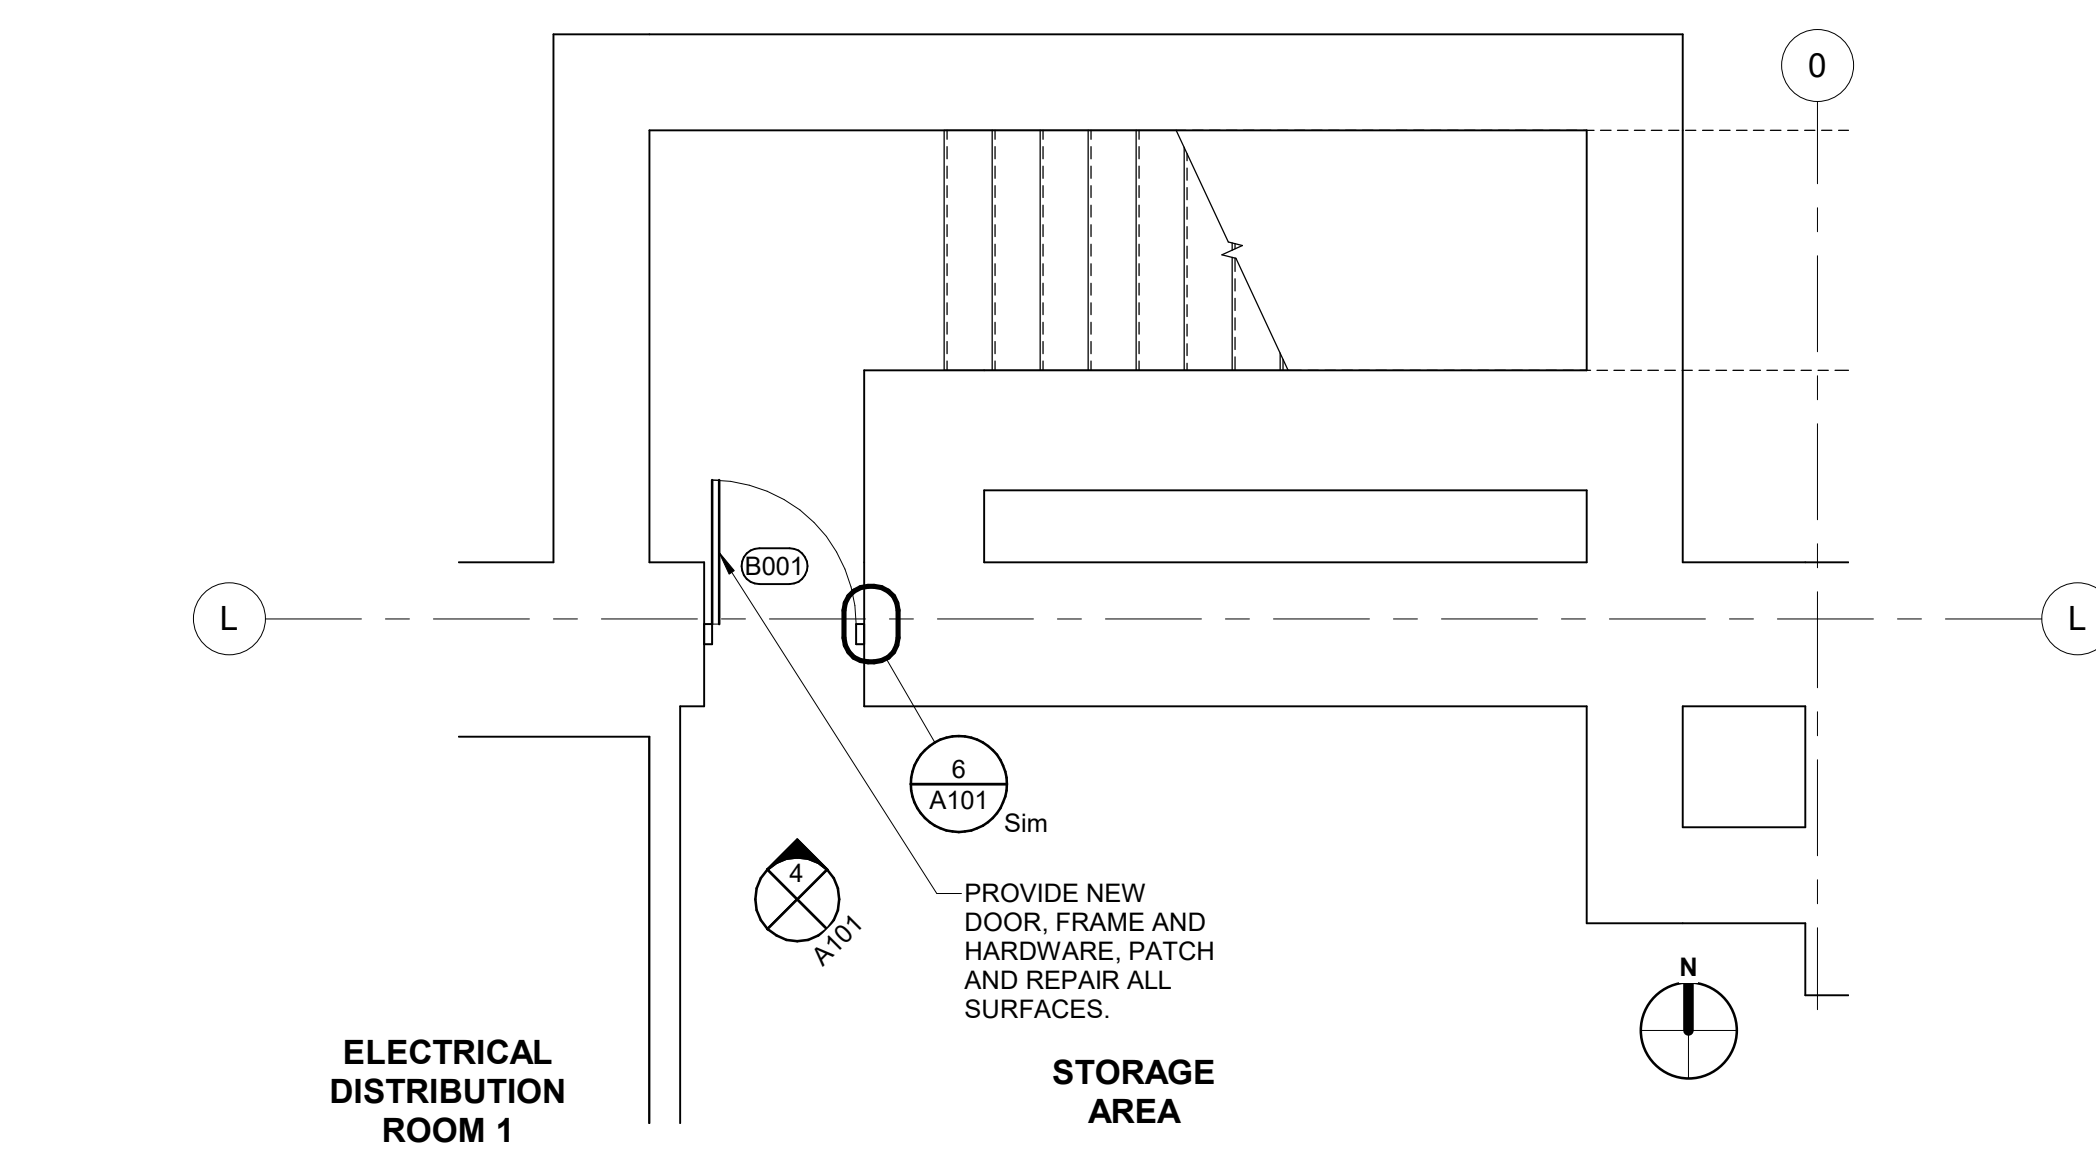
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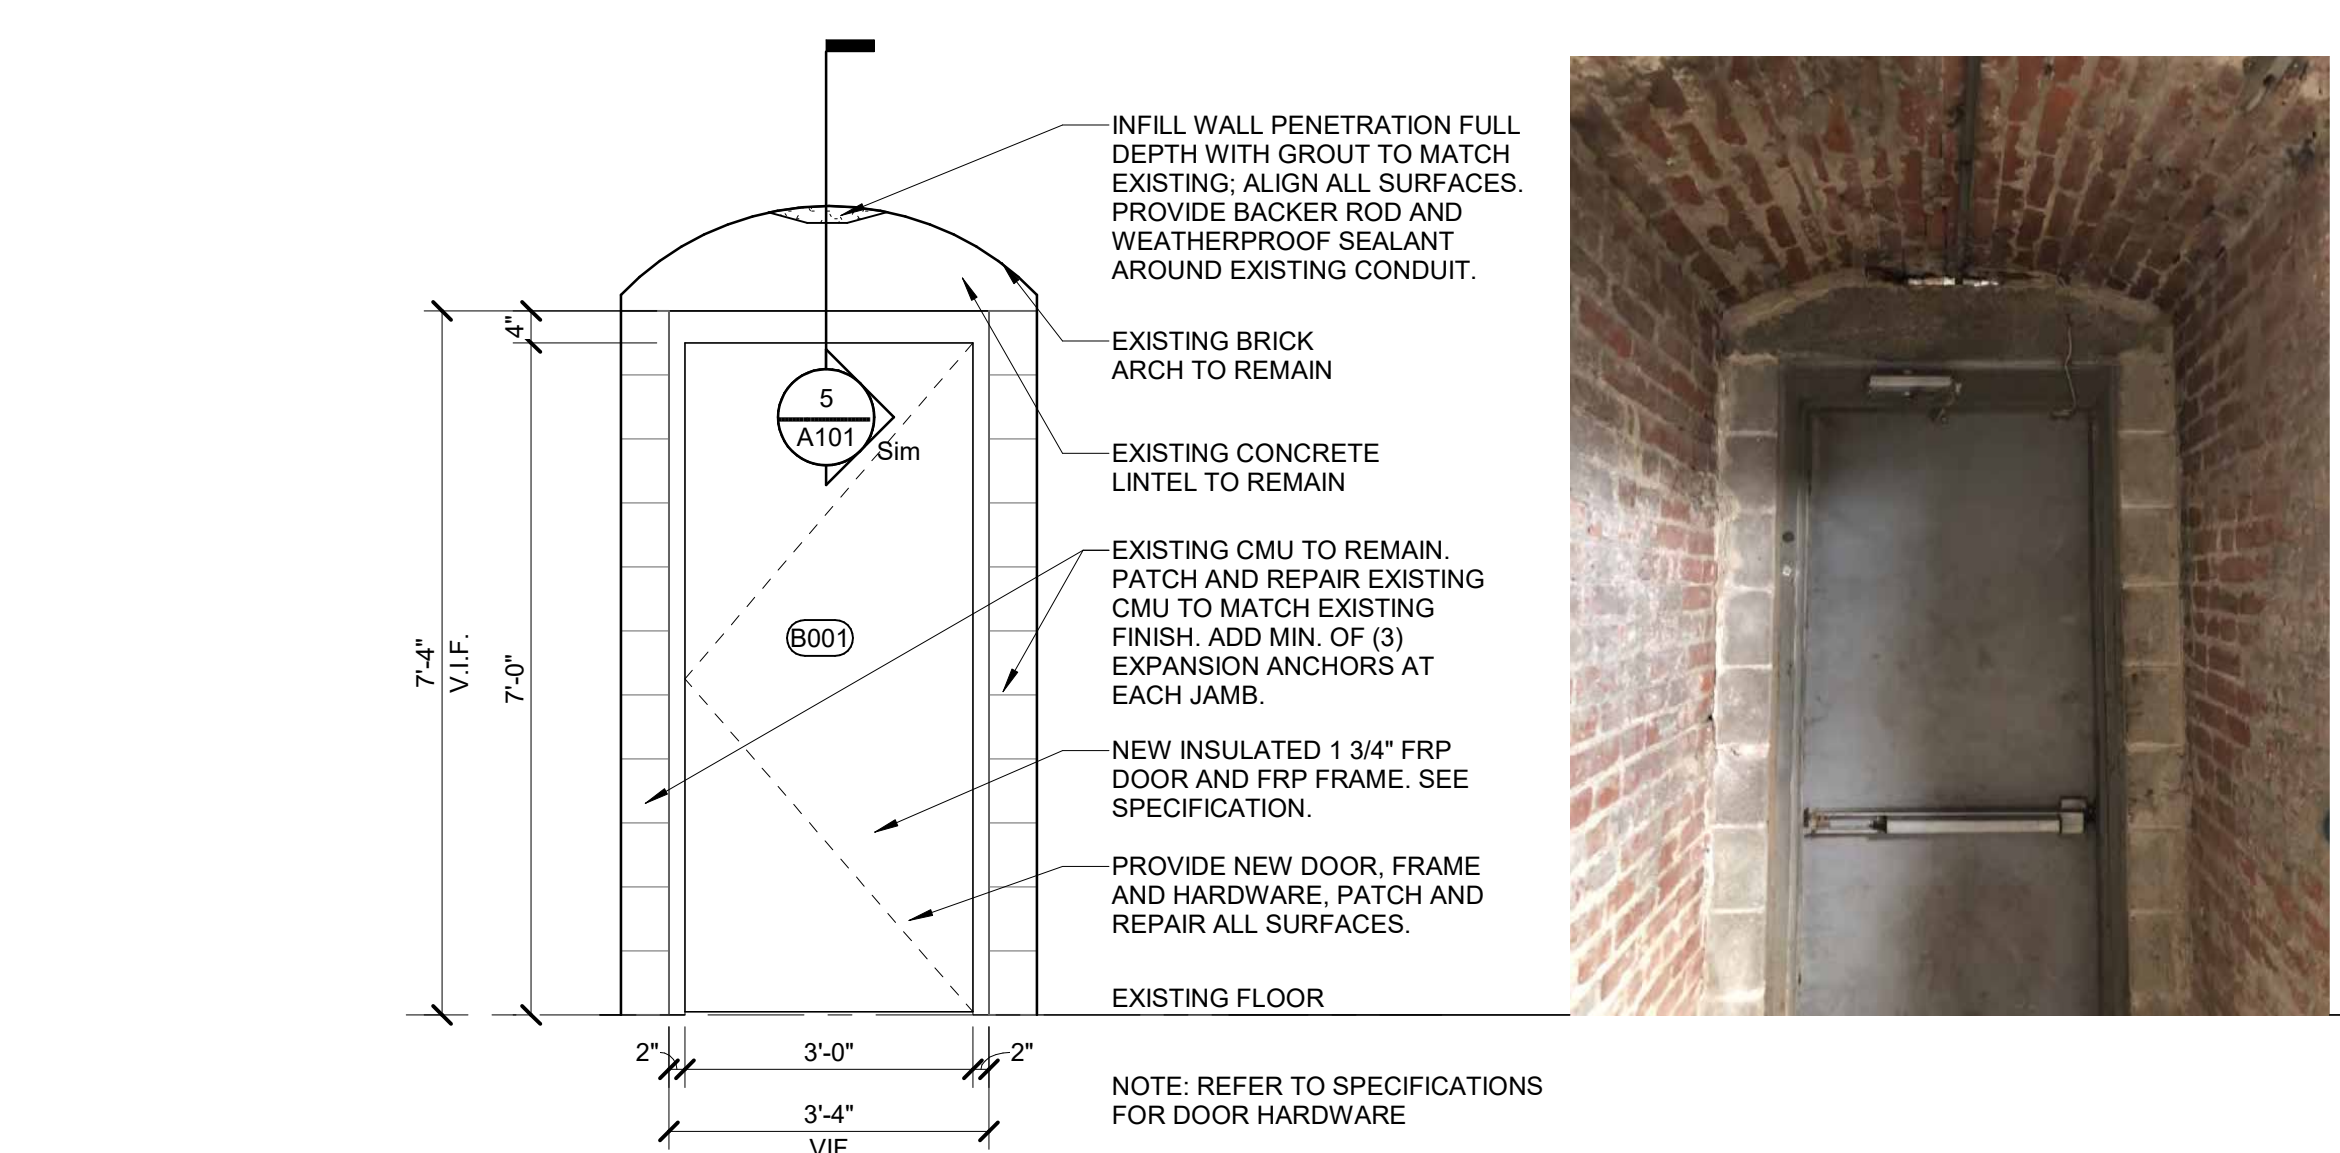
1 BASEMENT FLOOR PLAN
SCALE: 1/16" = 1'-0"




2 PARTIAL BASEMENT FLOOR PLAN - DOOR DEMOLITION
SCALE: 1/4" = 1'-0"

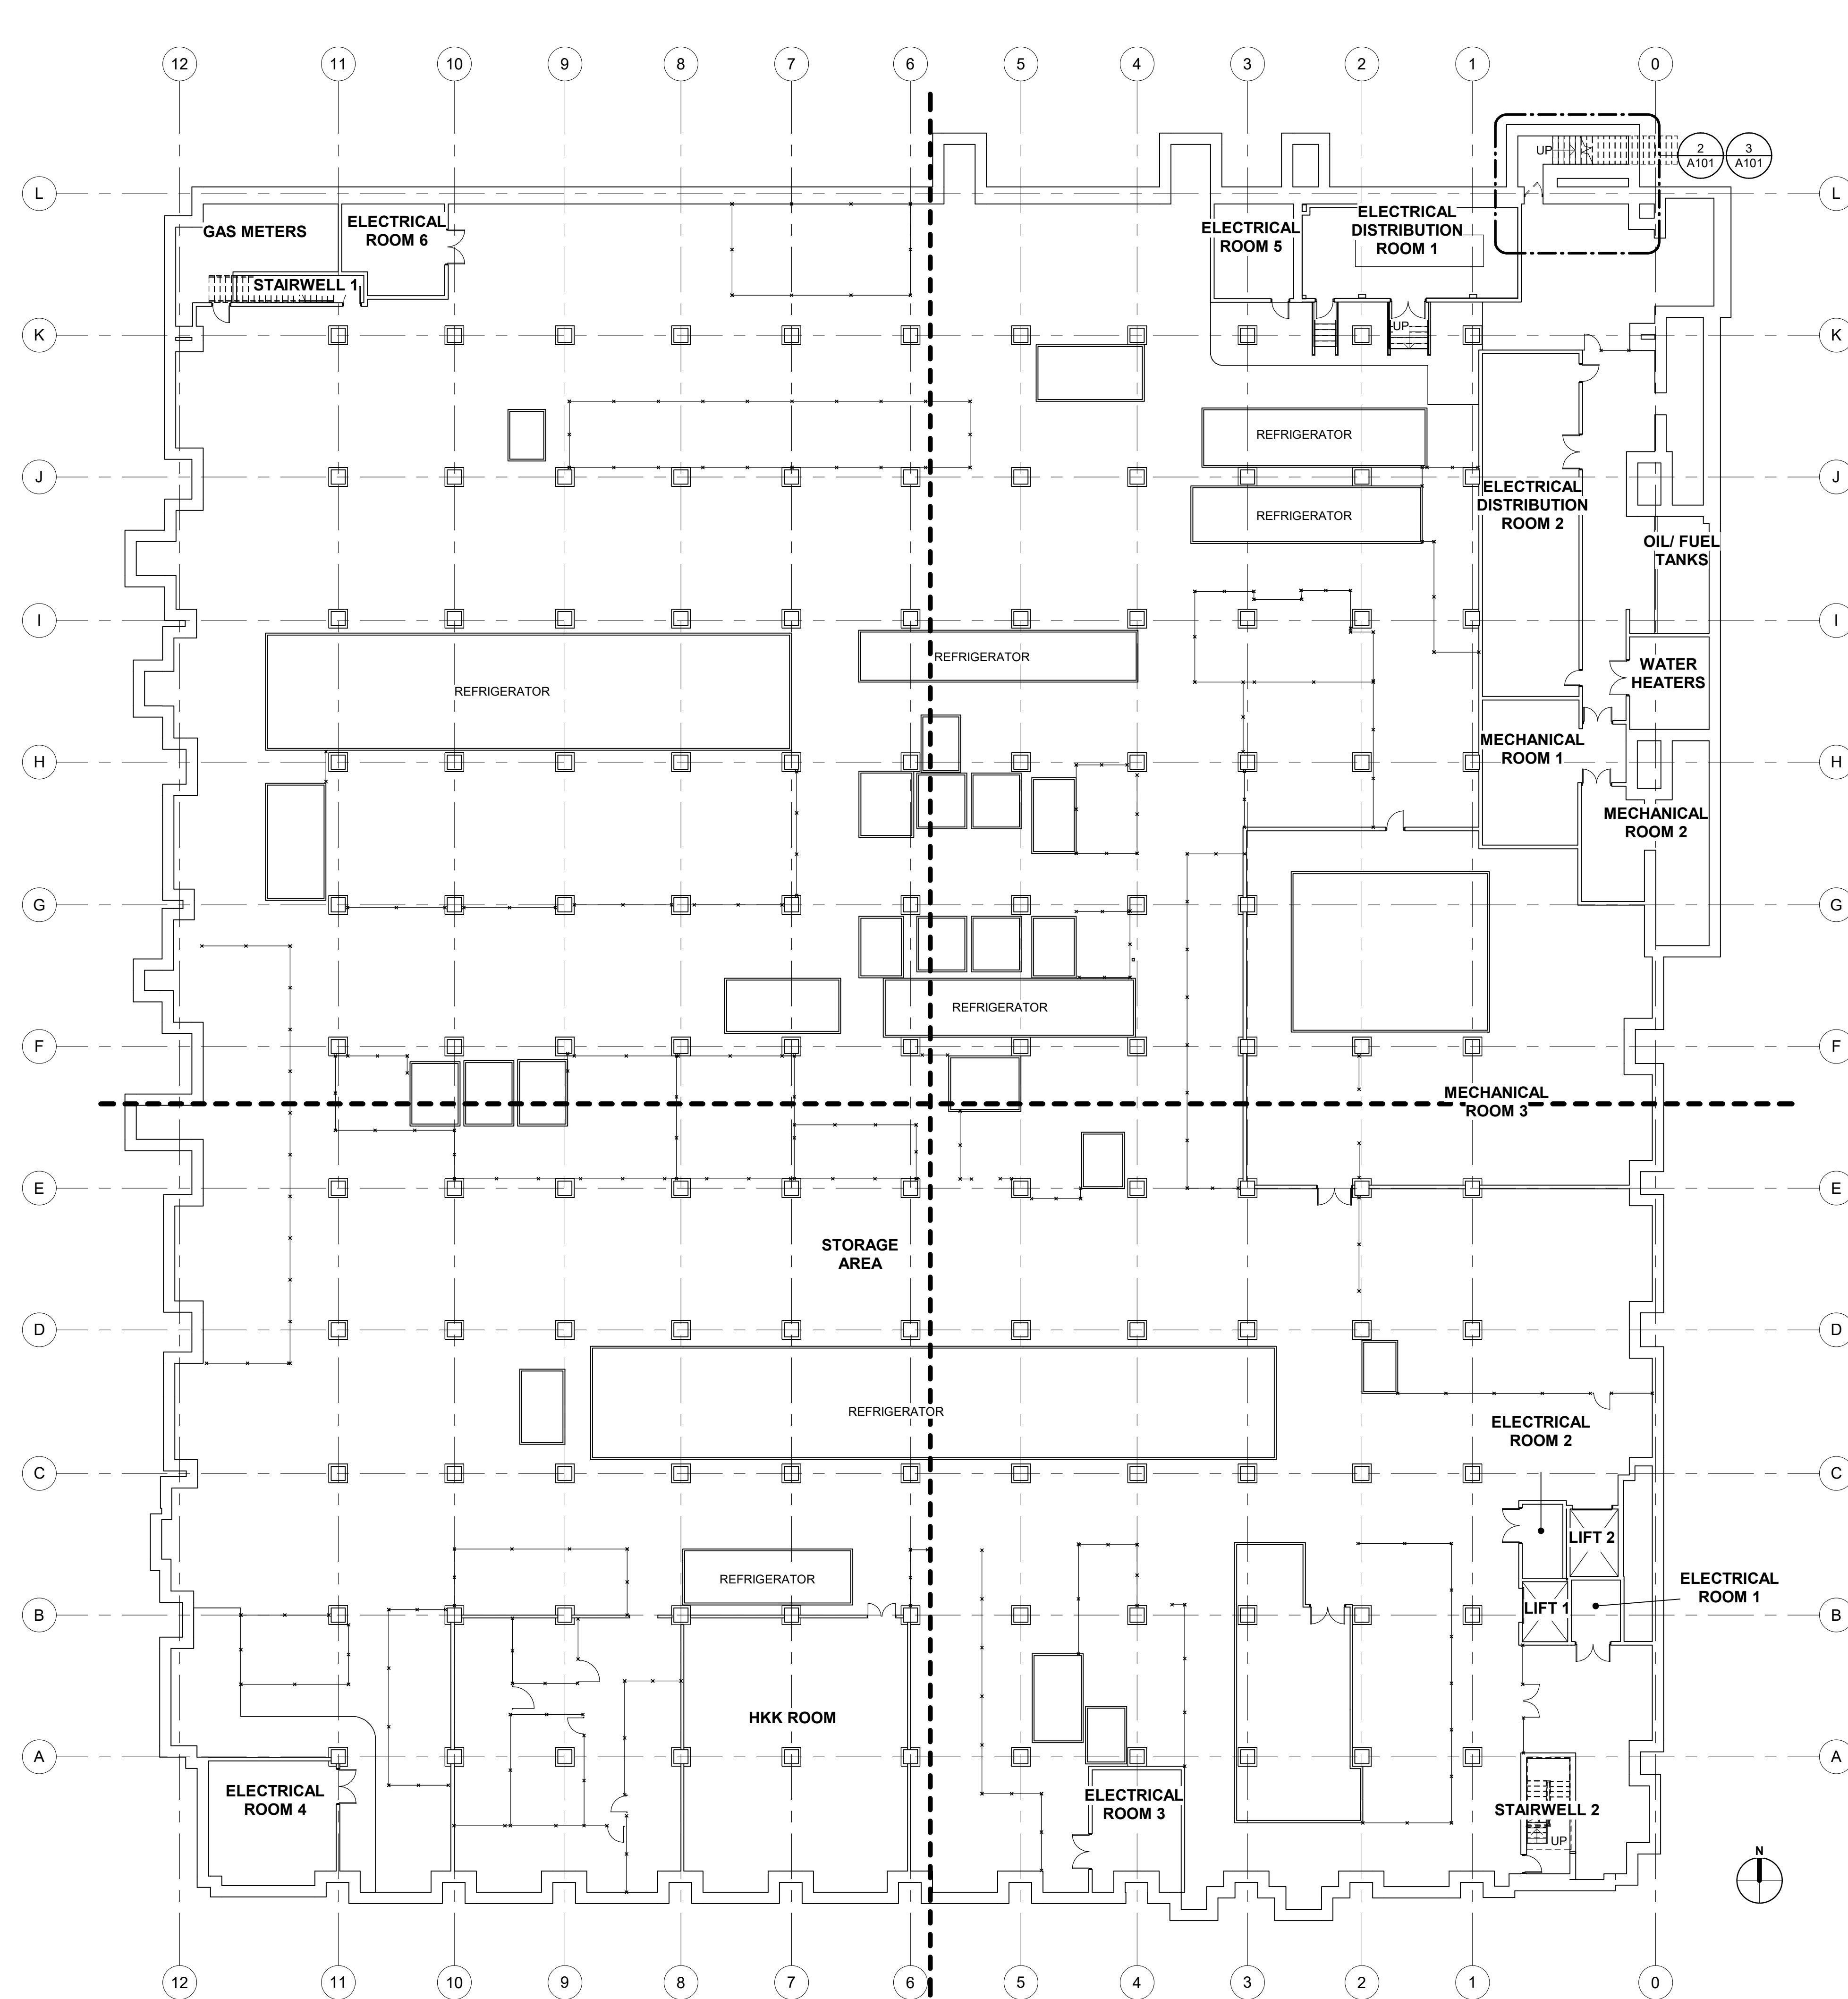

3 PARTIAL BASEMENT FLOOR PLAN - NEW DOOR
SCALE: 1/4" = 1'-0"

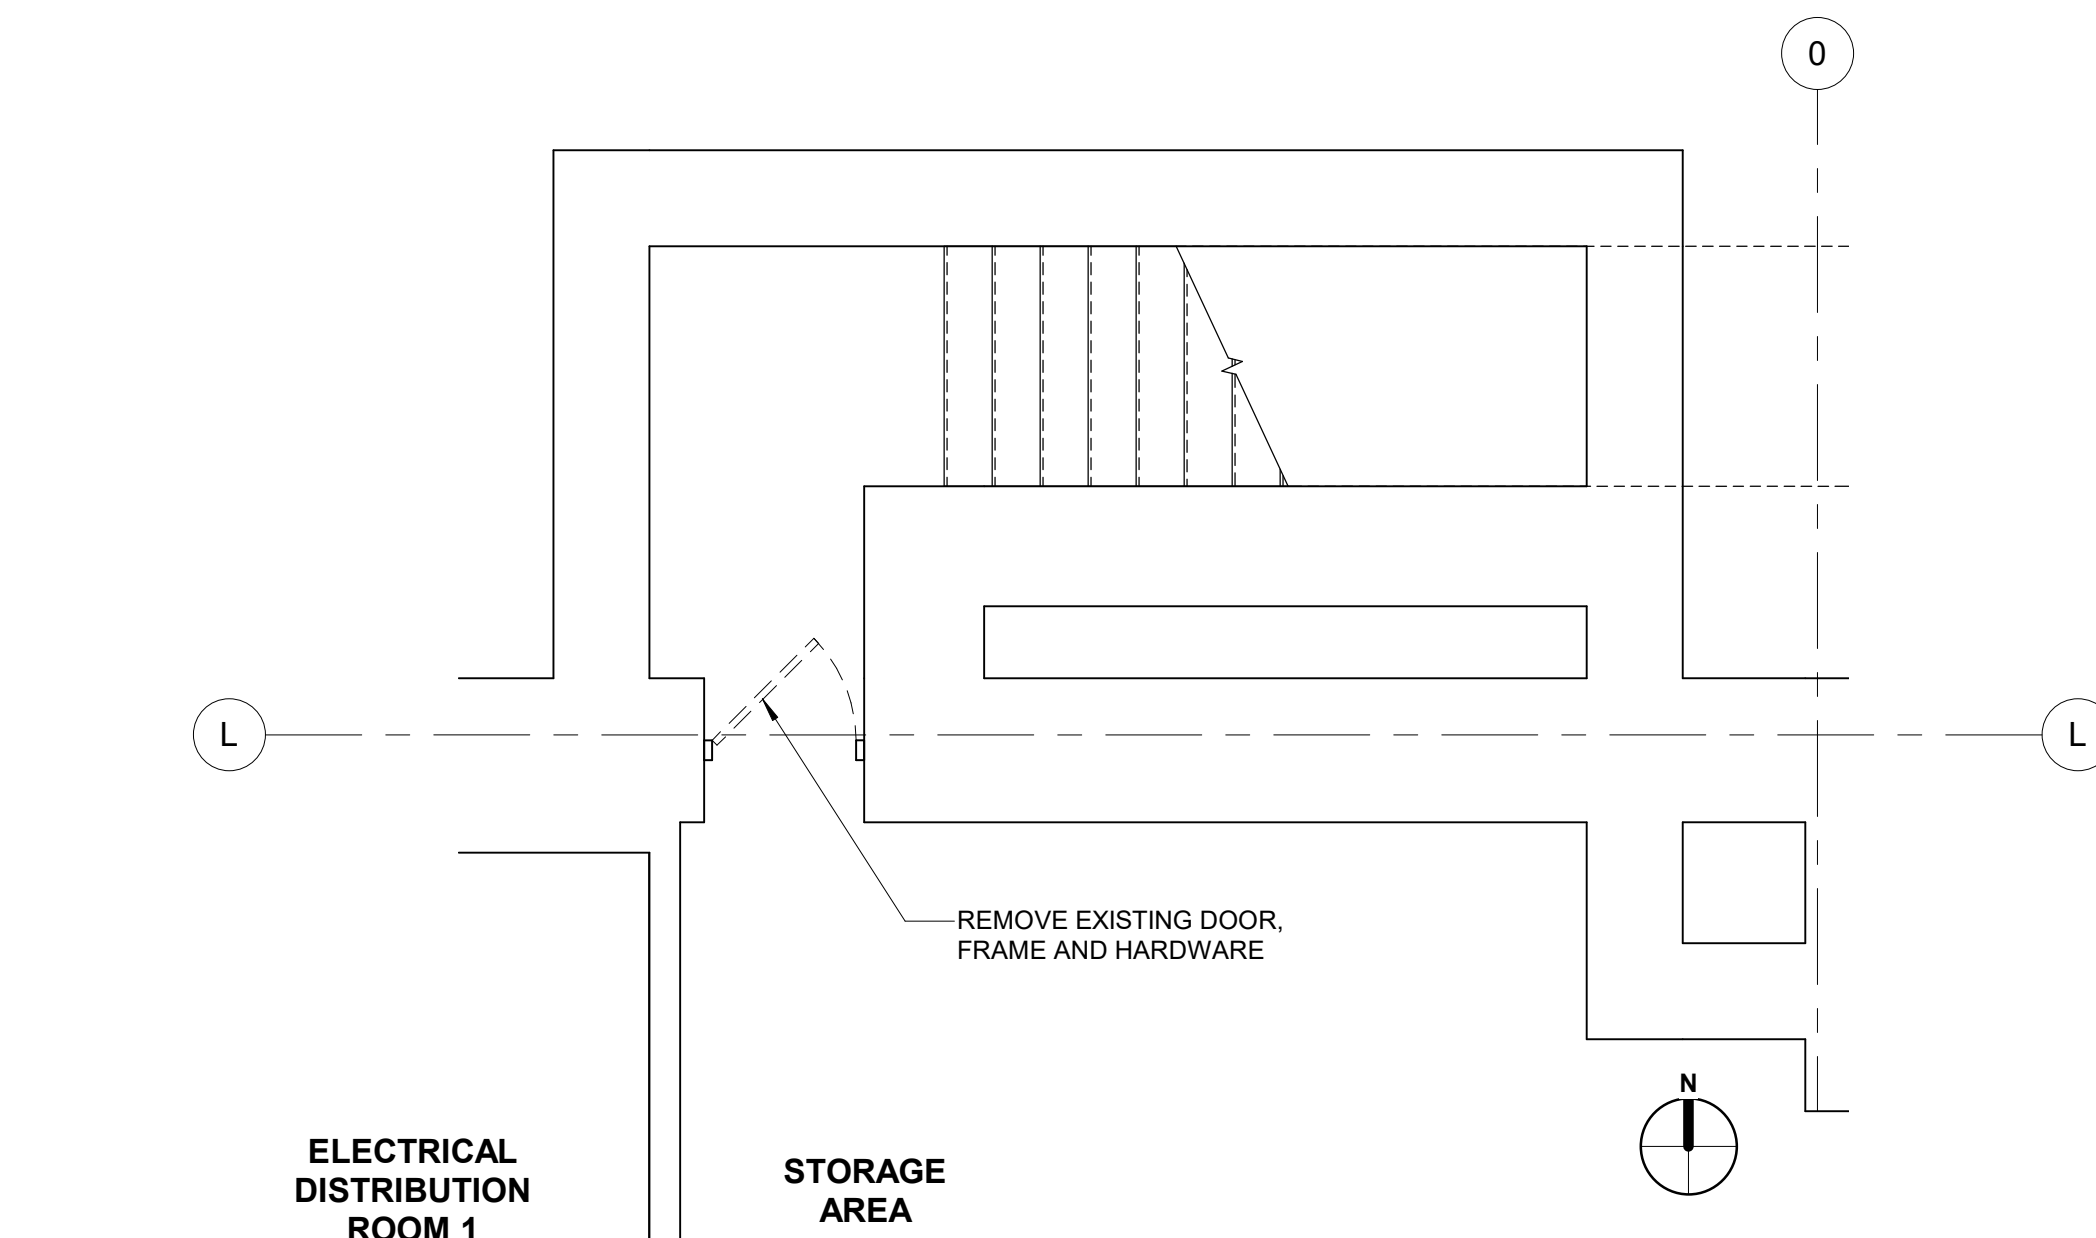

4 BASEMENT DOOR ELEVATION
SCALE: 1/2" = 1'-0"

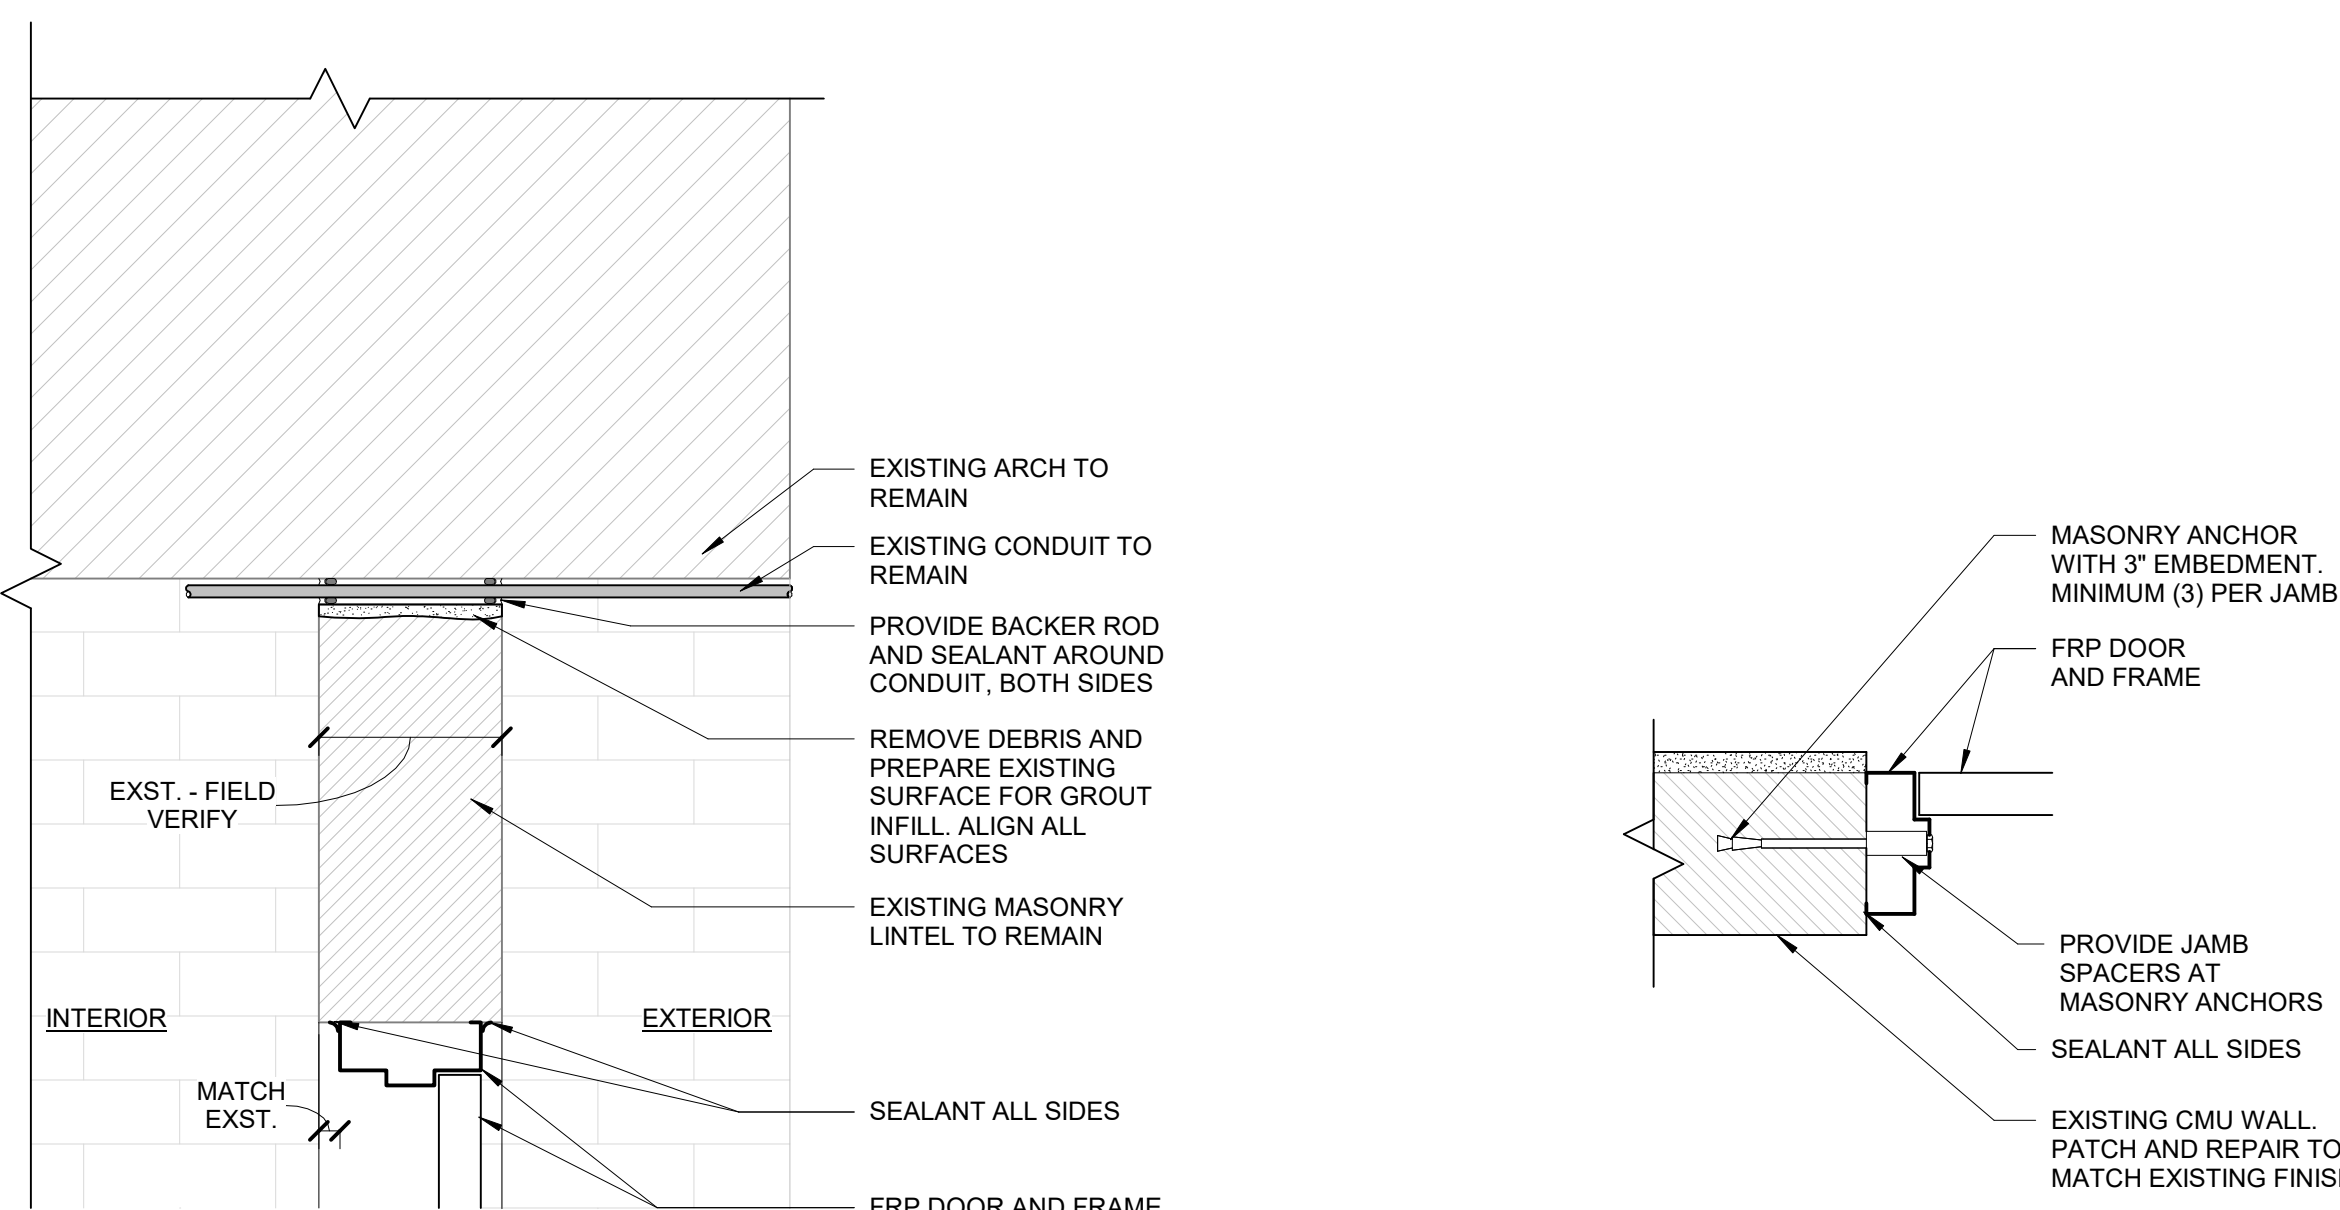

5 DOOR HEAD DETAIL
SCALE: 1 1/2" = 1'-0"


6 DOOR JAMB DETAIL
SCALE: 1 1/2" = 1'-0"








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DESIGNED: TY	MODELED: EVH	CHECKED: JS
DATE: 02/03/23		
DRAWING TITLE: ARCHITECTURAL		
FLOOR PLAN & DETAILS		
DRAWING NO.: A101		

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Project Number: 071274
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2 PARTIAL GROUND FLOOR PLAN - EPOXY FLOOR AREA
SCALE: 1/8" = 1'-0"

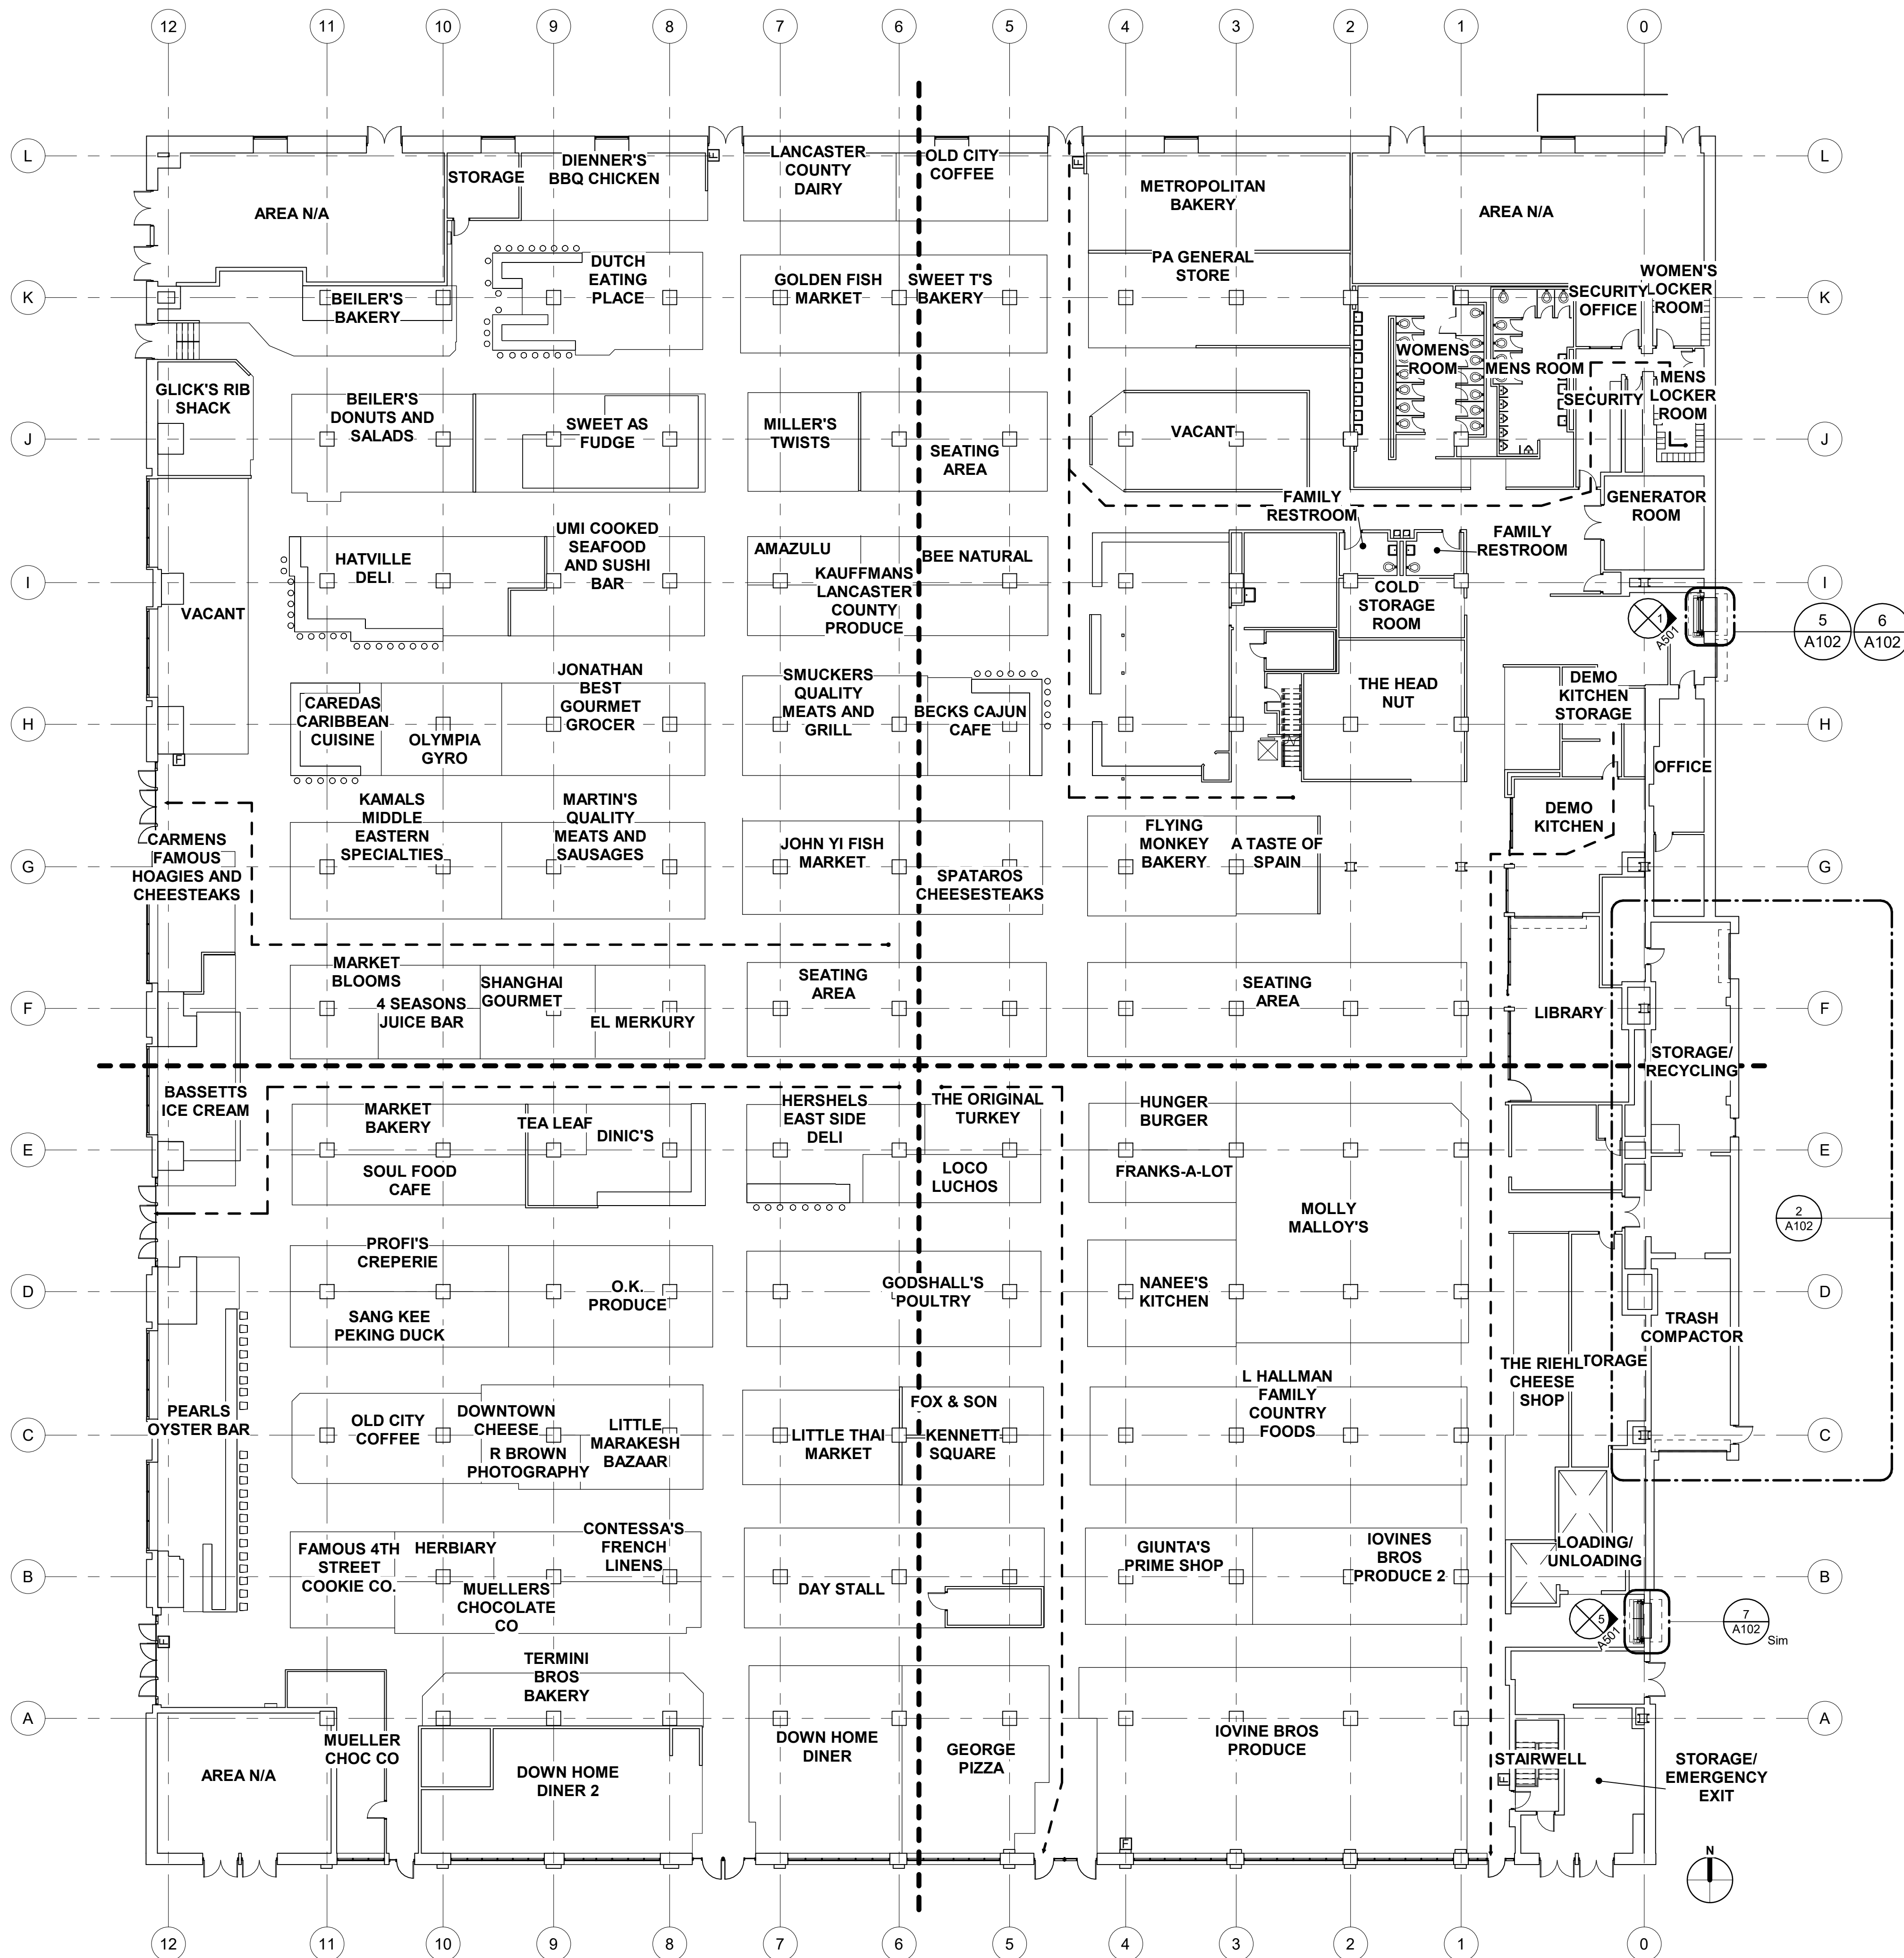

NOTE: REFER TO MECHANICAL AND ELECTRICAL DRAWINGS FOR DEVICES IN THE AREA OF WORK TO BE REMOVED OR RELOCATED.

NOTE: REFER TO MECHANICAL AND ELECTRICAL DRAWINGS FOR DEVICES IN THE AREA OF WORK TO BE REMOVED OR RELOCATED.

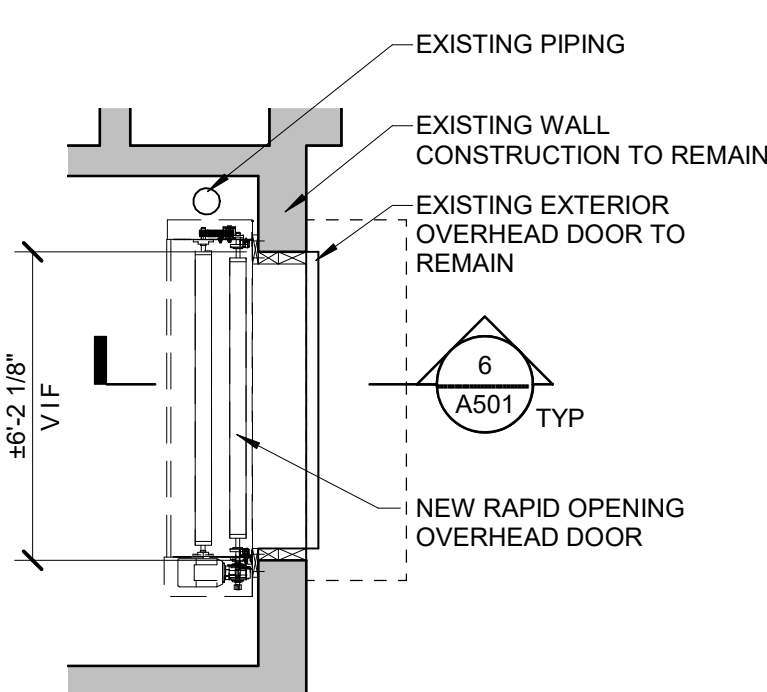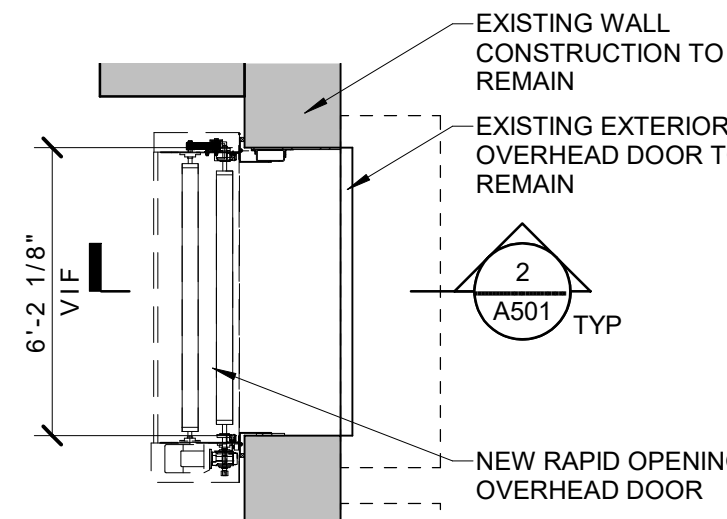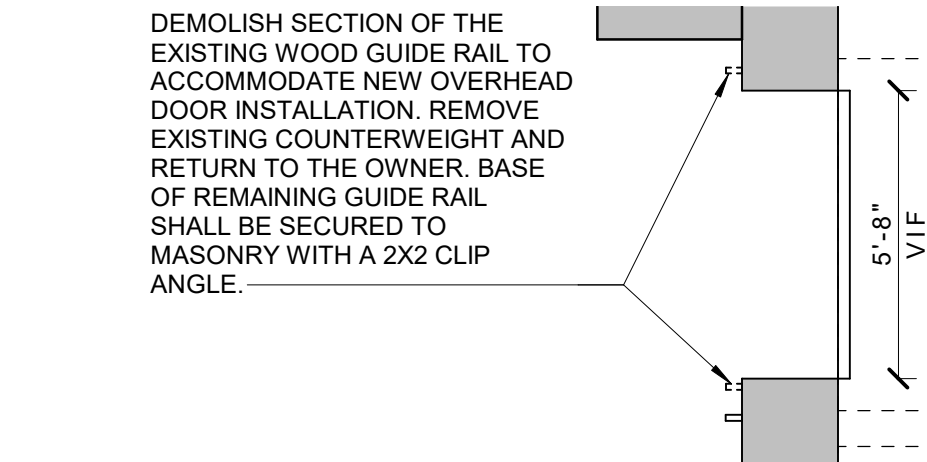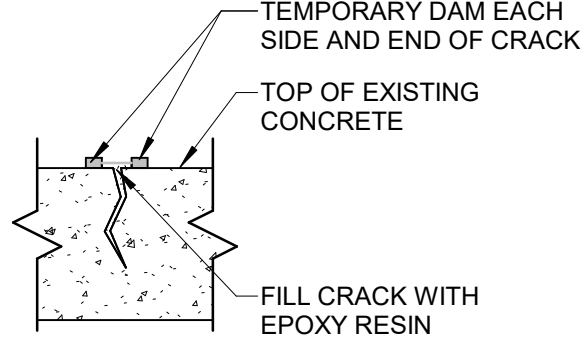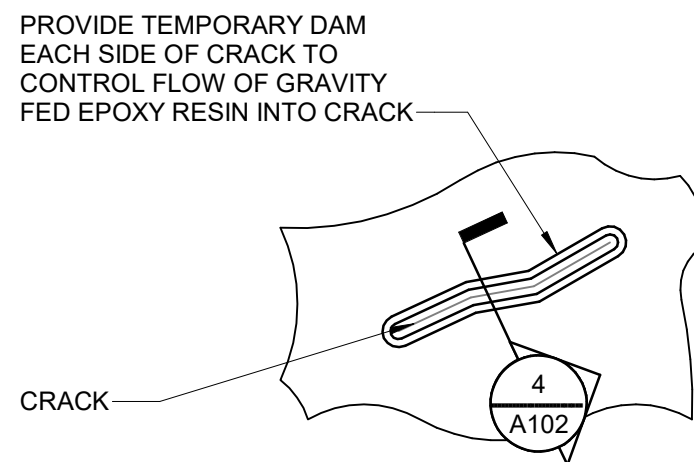NOTE: REFER TO MECHANICAL AND ELECTRICAL DRAWINGS FOR DEVICES IN THE AREA OF WORK TO BE REMOVED OR RELOCATED.



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DATE: 02/03/23		
DRAWING TITLE: ARCHITECTURAL FLOOR PLAN & DETAILS		
DRAWING NO.: A102		



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ABBREVIATIONS

@	AT	GWR	GLYCOL WATER SUPPLY	TW	TEPID WATER
A	AIR	GWS	GLYCOL WATER RETURN	TYP	TYPICAL
AAV	AUTOMATIC AIR VENT				
ABV	ABOVE				
AD	AREA DRAIN, ACCESS DOOR, AIR DRYER	H	HEIGHT	UL	UNDERWRITERS LABORATORIES UNLESS OTHERWISE NOTED
ADA	AMERICANS WITH DISABILITIES ACT	H2O	WATER	UON	
ADJ	ADJUST, ADJUSTABLE	HB	HOSE BIB		
AF	ANTI-FREEZE	HHR	HEATING HOT WATER RETURN	V	VOLTS, VENT
AFF	ABOVE FINISHED FLOOR	HHWS	HEATING HOT WATER SUPPLY	VCO	VERTICAL CLEAN OUT
ALUM	ALUMINUM	HORIZ	HORIZONTAL	VEL	VELOCITY
AP	ACCESS PANEL	HP	HORSEPOWER	VERT	VERTICAL
APPROX	APPROXIMATELY	HPS	HIGH PRESSURE STEAM	VFD	VARIABLE FREQUENCY DRIVE
ARCH	ARCHITECTURAL	HTG	HEATING	VIB	VIBRATION
AS	AIR SEPARATOR	HJH	HYDRONIC UNIT HEATER	VSD	VARIABLE SPEED DRIVE
AST	ABOVEGROUND STORAGE TANK	HUM	HUMIDIFIER	VTR	VENT THROUGH ROOF
ATV	ATMOSPHERIC VENT	HWR	HOT WATER RETURN		
AVG	AVERAGE	HWS	HOT WATER SUPPLY		
		HX	HEAT EXCHANGER	W	WIDTH, WIDE
		HZ	HERTZ (CYCLES PER SECOND)	WI	WITH
				W/O	WITHOUT
BA	BREATHABLE AIR	ID	INSIDE DIAMETER	WAGD	WASTE ANESTHETIC GAS DISPOSAL
BAS	BUILDING AUTOMATION SYSTEM	IN	INCHES OF WATER GAUGE	WC	WATER CLOSET
BFF	BELOW FINISHED FLOOR	IN, "	INCH, INCHES	WCO	WALL CLEANOUT
BFP	BACKFLOW PREVENTER	INFO	INFORMATION	WFU	WATER SUPPLY FIXTURE UNITS
BLDG	BUILDING	INFO	INFORMATION	WG	WATER GAUGE
BLW	BELOW	INT	INTERIOR	WH	WATER HEATER, WALL HYDRANT
BMS	BUILDING MANAGEMENT SYSTEM	INT	INTERIOR	WHA	WATER HAMMER ARRESTOR
BOD	BASIS OF DESIGN	INT	INTERIOR	WMS	WIRE MESH SCREEN
BOT	BOTTOM	INV EL	INVERT ELEVATION	WPD	WATER PRESSURE DROP
BTU	BRITISH THERMAL UNIT	ISOL	ISOLATION	WSP	WATER SOURCE HEAT PUMP
BTUH	BRITISH THERMAL UNITS PER HOUR	IV	INDUSTRIAL WASTE, INDIRECT WASTE	WT	WEIGHT
		KW	KILOWATTS	ZN	ZONE
CA	COMMON	L	LENGTH, LONG		
CD	CONDENSATE DRAIN	LAV	LAVATORY		
CFH	CUBIC FEET PER HOUR	LBS	POUNDS		
CFM	CUBIC FEET PER MINUTE	LDB	LEAVING DRY BULB TEMPERATURE		
CHWR	CHILLED WATER RETURN	LDR	LEADER		
CHWS	CHILLED WATER SUPPLY	LP	LIQUID PROPANE		
CI	CAST IRON	LPCR	LOW PRESSURE CONDENSATE RETURN		
CL	CENTER LINE	LPS	LOW PRESSURE STEAM		
CLDP	CEMENT-LINED DUCTILE IRON S PIPE	LRA	LOAD RATED AMPS		
CLNG	CEILING	LWT	LEAVING WATER TEMPERATURE		
CNG	COMPRESSED NATURAL GAS				
CO	CLEANOUT, CARBON MONOXIDE	M	METER		
CO2	CARBON DIOXIDE	MA	MEDICAL AIR		
COL	COLUMN	MAV	MANUAL AIR VENT		
CONC	CONCRETE	MAX	MAXIMUM		
CONN	CONNECTION	MBH	THOUSAND BRITISH THERMAL UNITS PER HOUR		
CONT	CONTINUATION	MCA	MINIMUM CIRCUIT AMPACITY		
CONTD	CONTINUED	MECH	MECHANICAL		
COP	COEFFICIENT OF PERFORMANCE	MFR	MANUFACTURER		
CPVC	CHLORINATED POLYVINYL CHLORIDE	MIN	MINIMUM		
CY	CLEANING VACUUM, CHECK VALVE	MO	MOTOR OIL		
CW	COLD WATER	MOCIP	MAXIMUM OVER-CURRENT PROTECTION		
CWR	CONDENSER WATER RETURN	MPS	MEDIUM PRESSURE STEAM		
CWS	CONDENSER WATER SUPPLY	MTD	MOUNTED		
Cx	COMMISSIONING	MTG	MOUNTING		
CxA	COMMISSIONING AUTHORITY	MUW	MAKE UP WATER		
		MV	MEDICAL VACUUM		
(D)	DEMOLISH, REMOVE				
D	DRAIN, DEPTH	N	NITROGEN		
DB	DECIBELS	N/A	NOT APPLICABLE		
DCW	DOMESTIC COLD WATER	NC	NORMALLY CLOSED, NOISE CRITERIA		
DDC	DIRECT DIGITAL CONTROL	NFPA	NATIONAL FIRE PROTECTION ASSOCIATION		
DEG, °	DEGREES	NFPA	NATIONAL FIRE PROTECTION ASSOCIATION		
DEH	DEHUMIDIFIER	NFHW	NON-FREEZE WALL HYDRANT		
DEPT	DEPARTMENT	NG	NATURAL GAS		
DESQ	DESIGNATION	NIC	NOT IN CONTRACT		
DFU	DRAINAGE FIXTURE UNITS	NO	NORMALLY OPENED		
DHW	DOMESTIC HOT WATER	No	NUMBER		
DHWR	DOMESTIC HOT WATER RETURN	NOM	NOMINAL		
DI	DIONIZED WATER	NPW	NON-POTABLE WATER		
DIA, ø	DIAMETER	NTS	NOT TO SCALE		
DIFF	DIFFERENTIAL, DIFFERENCE				
DISC	DISCONNECT	OZ, OZ	OXYGEN		
DN	DOWN	OC	ON CENTER		
DSB	DOWNSPOUT BOOT	OFD	OVERFLOW DRAIN		
DSN	DOWNSPOUT NOZZLE	OI	OIL INTERCEPTOR		
DTWR	HOT/CHILLED WATER RETURN (DUAL TEMP.)	OSAY	OUTSIDE STEM AND YOE VALVE		
DTWS	HOT/CHILLED WATER SUPPLY (DUAL TEMP.)	OSD	OPEN SITE DRAIN		
DWG	DRAWING	OVI	OVERHEAD		
		OVS	OIL WATER SEPARATOR		
(ER)	EXISTING, RELOCATED	%	PERCENT		
(EX)	EXISTING TO REMAIN	P	PUMP		
EA	EACH	PC	PUMPED CONDENSATE		
EDB	ENTERING DRY BULB TEMPERATURE	PD	PRESSURE DROP		
EER	ENERGY EFFICIENCY RATIO	PH	PHASE		
EFF	EFFICIENCY	PW	PUMPED INDUSTRIAL WASTE		
EJ	EXPANSION JOINT	PLBG	PLUMBING		
EL	ELEVATION	PNEU	PNEUMATIC		
ELEC	ELECTRIC, ELECTRICAL	POS	POSITION		
ELEV	ELEVATOR	PRESS	PRESSURE		
EQ	EQUAL	PROP	PROPELLER		
ET	EXPANSION TANK	PRV	PRESSURE REDUCING VALVE		
EW	ELECTRIC WATER COOLER	PS	PRESSURE SWITCH		
EWT	ENTERING WATER TEMPERATURE	PSC	PUMPED STEAM CONDENSATE RETURN		
EXT	EXTERIOR	PSI	POUNDS PER SQUARE INCH		
		PSIG	POUNDS PER SQUARE INCH GAUGE		
		PVC	POLYVINYL CHLORIDE		
(F)	FUTURE				
FCO	FLOOR CLEANOUT	(RL)	RELOCATED POSITION		
FD	FLOOR DRAIN, FIRE DAMPER	R	RISE		
FDC	FIRE DEPARTMENT CONNECTION	RD	ROOF DRAIN, REFRIGERANT DISCHARGE		
FDR	FLOOR DRAIN	REF	REFRIGERANT		
FF	FINISHED FLOOR	REQD	REQUIRED		
FG	FUEL GAS	RL	REFRIGERANT LIQUID		
FLA	FULL LOAD AMPS	RLA	RATED LOAD AMPS		
FLEX	FLEXIBLE	RM	ROOM		
FLR	FLOOR	RPM	REVOLUTIONS PER MINUTE		
FM	FLOW METER	RPZ	REDUCED PRESSURE BFP		
FO	FUEL OIL	RS	REFRIGERANT SUCTION		
FOF	FUEL OIL FILL	RWC	RAIN WATER CONDUCTOR		
FOR	FUEL OIL RETURN				
FOS	FUEL OIL SUPPLY				
FOV	FUEL OIL VENT				
FPM	FEET PER MINUTE	S	SWITCH		
FPS	FEET PER SECOND	S/S	START/STOP		
FRP	FIBERGLASS REINFORCED PLASTIC	SAN	SANITARY		
FS	FLOW SWITCH	SC	STEAM CONDENSATE RETURN		
FT HD	FEET OF HEAD	SF	SUPPLY FAN, SQUARE FEET		
FT, '	FOOT, FEET	SK	SINK		
FZ	FREEZE, FREEZSTAT	SP	STATIC PRESSURE		
°F	DEGREES FAHRENHEIT	SPEC	SPECIFICATION		
		SPR	SPRINKLER		
G	GAS	SQ	SQUARE		
GA	GAUGE	SQ FT	SQUARE FOOT, SQUARE FEET		
GAL	GALLON, GALLONS	SS	STAINLESS STEEL		
GALV	GALVANIZED	ST	STORM WATER PIPING		
GCO	GRADE CLEANOUT	STD	STANDARD		
GEN	GENERATOR	STL	STEEL		
GI	GREASE INTERCEPTOR	STM	STEAM		
GPH	GALLONS PER HOUR				
GPM	GALLONS PER MINUTE	TEMP	TEMPERATURE, TEMPORARY		
GW	GREASE WASTE	TP	TRAP PRIMER		

GENERAL NOTES

- NOT ALL ABBREVIATIONS, LINE TYPES, OR SYMBOLS MAY APPEAR ON THESE CONTRACT DOCUMENTS.
- DRAWINGS SHALL BE CONSIDERED DIAGRAMMATIC AND ARE INTENDED TO INDICATE CAPACITY, SIZE, APPROXIMATE LOCATION AND GENERAL ARRANGEMENT. WHILE THE DRAWINGS ARE GENERALLY TO SCALE AND ARE AS ACCURATE AS THE SCALE WILL PERMIT, DIMENSIONS SHALL BE CONFIRMED IN THE FIELD.
- THE CONTRACTOR SHALL COMPLY WITH THE LAWS, ORDINANCES, RULES AND REGULATIONS OF LOCAL AND STATE GOVERNMENTAL AUTHORITIES, OF THE NATIONAL FIRE PROTECTION ASSOCIATION AS INTERPRETED BY THE ENFORCING AUTHORITY HAVING JURISDICTION; AND OF PUBLIC UTILITIES HAVING CONNECTION WITH ANY OF THE SYSTEMS HEREIN SPECIFIED.
- INSTALL EQUIPMENT IN A SERVICEABLE MANNER, WITHOUT DISRUPTION TO ADJACENT SERVICES OR DAMAGING INSULATION.
- PROVIDE ALL NEW AND REUSED WALL PENETRATIONS WITH A SLEEVE/CONDUIT FOR SERVICES PENETRATING IT. THIS INCLUDES, BUT IS NOT LIMITED TO, DUCTWORK, PIPING, POWER, AND CONTROL WIRING.
- THE CONTRACTOR SHALL SECURE AND PAY FOR ALL PERMITS AND INSPECTIONS REQUIRED BY ANY OF THE FOREGOING AUTHORITIES, AND PAY FOR ALL OTHER COSTS IN CONNECTION WITH THE WORK. CERTIFICATES SHALL BE IN DUPLICATE AND SHALL BE DELIVERED TO THE OWNER.
- THE SITE, LOCATION, AND ROUTING OF SYSTEMS INDICATED TO HAVE NEW CONNECTIONS MADE TO THEM ARE SHOWN AS ACCURATELY AS FIELD CONDITIONS PERMIT. CONTRACTOR SHALL VISIT THE SITE AND THOROUGHLY EXAMINE THE CONTRACT DRAWINGS. ALL EXISTING CONDITIONS SHALL BE EXAMINED AND THEIR EXACT LOCATIONS VERIFIED. THE CONTRACTOR SHALL REPORT TO THE ENGINEER ANY CONDITIONS WHICH MIGHT MAKE INSTALLATION OF REQUIRED EQUIPMENT A PROBLEM. NO CONSIDERATION OR ALLOWANCE WILL BE GRANTED FOR FAILURE TO INVESTIGATE CONDITIONS OR MISUNDERSTANDINGS OF THE CONTRACTUAL REQUIREMENTS.
- THE CONTRACTOR SHALL INSTALL AND CONNECT EQUIPMENT AND MATERIALS IN ACCORDANCE WITH THE BEST ENGINEERING PRACTICE AND, UNLESS OTHERWISE SHOWN OR SPECIFIED, FOLLOW THE MANUFACTURER'S PRINTED INSTALLATION REQUIREMENTS AND RECOMMENDATIONS, AND FURNISH AND INSTALL REQUIRED AUXILIARY ITEMS TO PROVIDE A COMPLETE INSTALLATION.
- THE CONTRACTOR SHALL REPAIR WALLS, CEILING, FLOORS, ETC., THAT ARE REQUIRED TO BE PENETRATED, OR OTHERWISE DISTURBED. THE REPAIRS SHALL BE WITH MATERIALS AND FINISHES TO MATCH EXISTING. FIRE WALL PENETRATIONS SHALL BE SEALED WITH SUITABLE MATERIALS TO PRESERVE FIRE WALL INTEGRITY.
- THE CONTRACTOR SHALL REMOVE EQUIPMENT NOT INDICATED TO BE REUSED TO A DESIGNATED LOCATION AT THE PROJECT SITE. AFTER THE EQUIPMENT HAS BEEN ASSEMBLED FOR THE OWNER'S INSPECTION AND POSSIBLE RETENTION, ALL EQUIPMENT NOT TO BE RETAINED BY THE OWNER SHALL BE REMOVED FROM THE SITE BY THE CONTRACTOR.
- COORDINATE WITH OTHER TRADES TO AVOID INTERFERENCE AMONG MECHANICAL, ELECTRICAL, ARCHITECTURAL, AND STRUCTURAL, PLUMBING, ETC. PROVIDE NECESSARY OFFSETS IN PIPING, DUCTWORK AND FITTINGS ETC., REQUIRED TO PROPERLY INSTALL WORK WITHOUT INTERFERENCES.
- BUILDING SYSTEMS SHALL REMAIN IN SERVICE UNLESS INDICATED OTHERWISE. OUTAGES OR INTERRUPTIONS SHALL BE KEPT TO A MINIMUM DURATION. NOTIFY THE OWNER 48 HOURS IN ADVANCE OF ANY OUTAGE OR INTERRUPTION. IF TEMPORARY CONNECTIONS ARE NECESSARY TO ASSURE THIS CONTINUITY OF SERVICES, THEY SHALL BE FURNISHED BY THE CONTRACTOR WITHOUT ADDITIONAL CHARGE TO THE OWNER AND SHALL BE REMOVED WHEN NO LONGER NEEDED.
- THE CONTRACTOR SHALL ARRANGE AND EXECUTE HIS WORK SUCH THAT ANY CONNECTIONS, BOTH TEMPORARY OR PERMANENT, TO, OR REARRANGEMENT OF, PRESENT EQUIPMENT, PIPING, ETC., SHALL BE MADE IN SUCH A MANNER AS TO ASSURE FULL RESUMPTION OF SERVICE AT THE TIME DESIGNATED BY THE OWNER.
- THE CONTRACTOR SHALL LOCATE EQUIPMENT WHICH MUST BE SERVICED, OPERATED OR MAINTAINED IN FULLY ACCESSIBLE POSITIONS. FURNISH ACCESS DOORS AS REQUIRED FOR BETTER ACCESSIBILITY. MINOR DEVIATIONS FROM DRAWINGS MAY BE MADE TO ALLOW FOR ACCESSIBILITY, BUT CHANGES OF MAGNITUDE WHICH INVOLVE EXTRA COSTS SHALL NOT BE MADE WITHOUT WRITTEN APPROVAL.
- ALL DIMENSIONS FOR EXISTING PIPING AND DUCTWORK SHALL BE VERIFIED IN THE FIELD BY THE CONTRACTOR PRIOR TO CONSTRUCTION. WHERE NEW WORK CONNECTIONS ARE INDICATED, NEW DUCT DIMENSIONS SHOWN ARE INSIDE CLEAR DIMENSIONS.
- OPENINGS REMAINING IN EXISTING PIPING/DUCTWORK AS A RESULT OF DEMOLITION SHALL BE SEALED WITH AN AIRTIGHT/WATERTIGHT SHEET METAL CAP. WHERE EXISTING SYSTEMS ARE INSULATED, WORK SHALL INCLUDE REPAIR AND REPLACEMENT OF INSULATION EITHER DAMAGED OR REMOVED AS A RESULT OF DEMOLITION.
- PIPING SCOPE REQUIREMENTS: HORIZONTAL CONDENSATE DRAINAGE PIPING SHALL BE INSTALLED IN UNIFORM ALIGNMENT AT UNIFORM SLOPES. THE MINIMUM SLOPE OF HORIZONTAL DRAINAGE PIPE SHALL BE IN ACCORDANCE WITH THE FOLLOWING:

SIZE (INCHES)	MINIMUM SLOPE (INCHES PER FOOT)
2-1/2" OR LESS	1/4"



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DESIGNED:	MODELED:	CHECKED:
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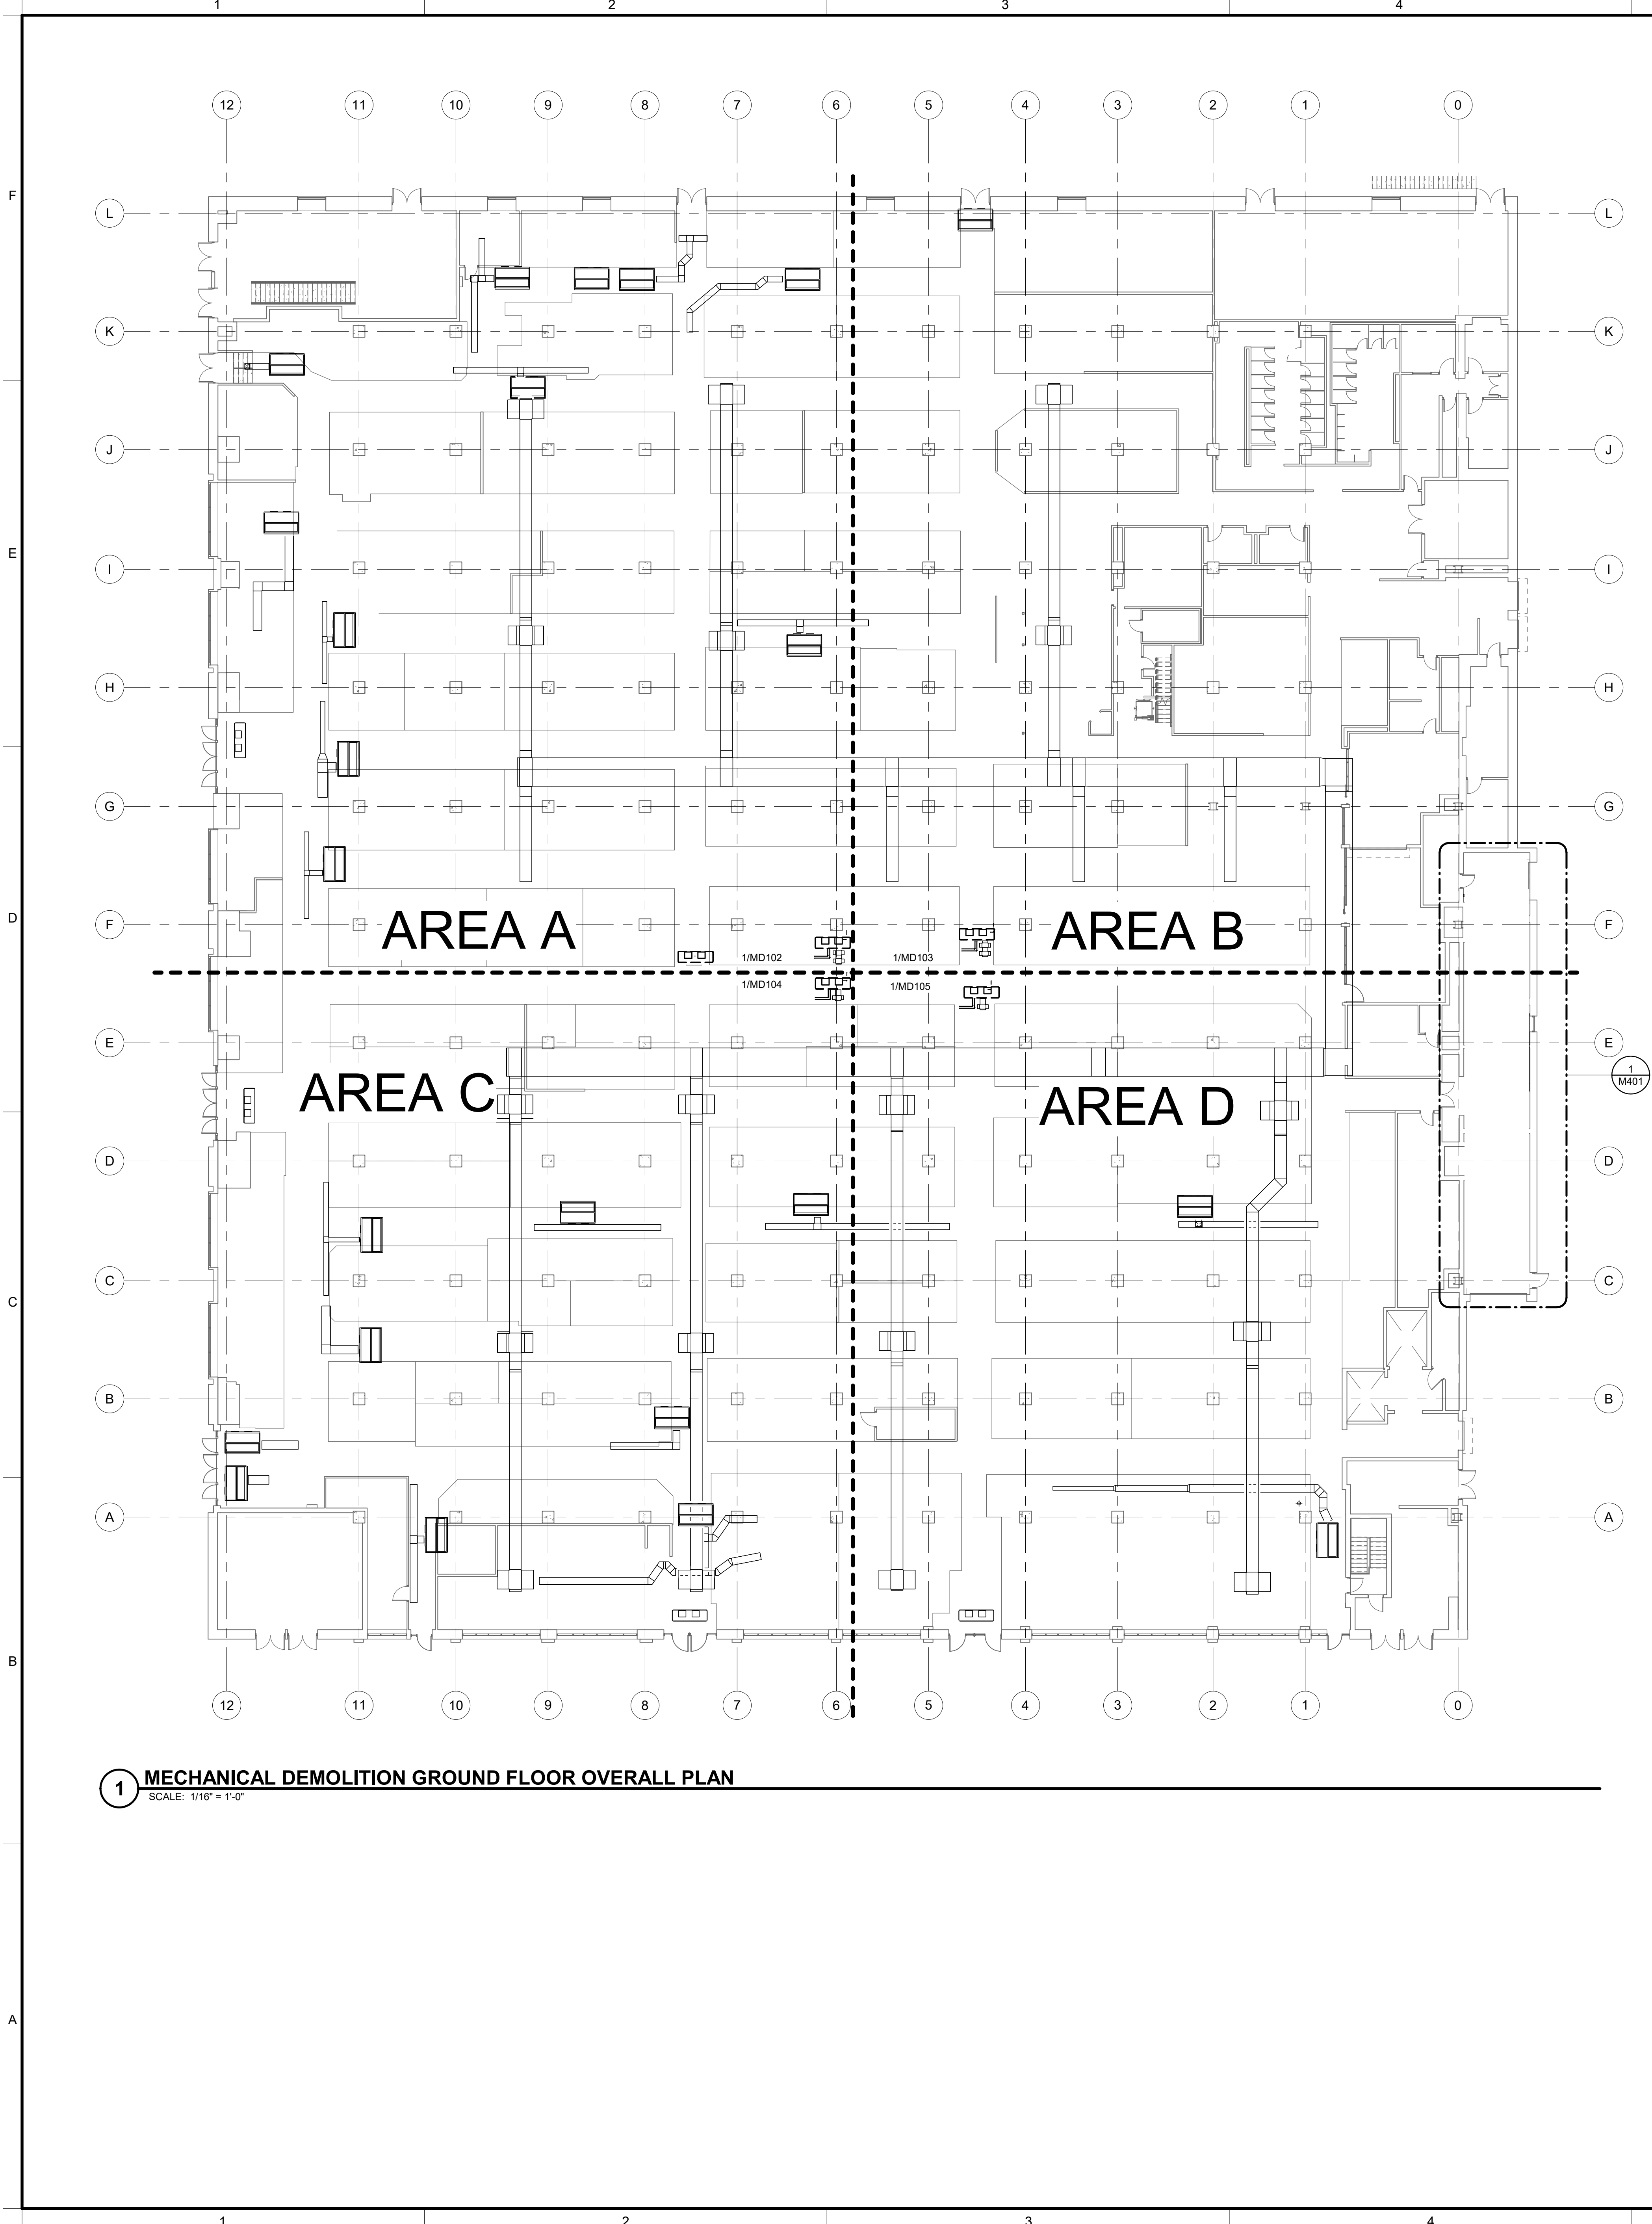
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MECHANICAL
GENERAL NOTES AND
ABBREVIATIONS

DRAWING NO.:

M002

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1 MECHANICAL DEMOLITION GROUND FLOOR OVERALL PLAN
SCALE: 1/16" = 1'-0"

SHEET NOTES

1. CLEAN ALL EXISTING DUCTWORK TO REMAIN. INSULATE ALL EXISTING DUCTWORK TO REMAIN, EXCEPT FOR SECTIONS WHERE EXISTING CONDUIT AND EXISTING SPRINKLERS PROHIBIT INSULATION INSTALLATION. INSULATION SHALL BE MINIMUM OF 1" CLEAR FROM EXISTING SPRINKLERS. REFER TO SPECIFICATIONS.



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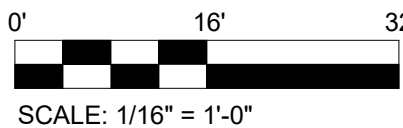
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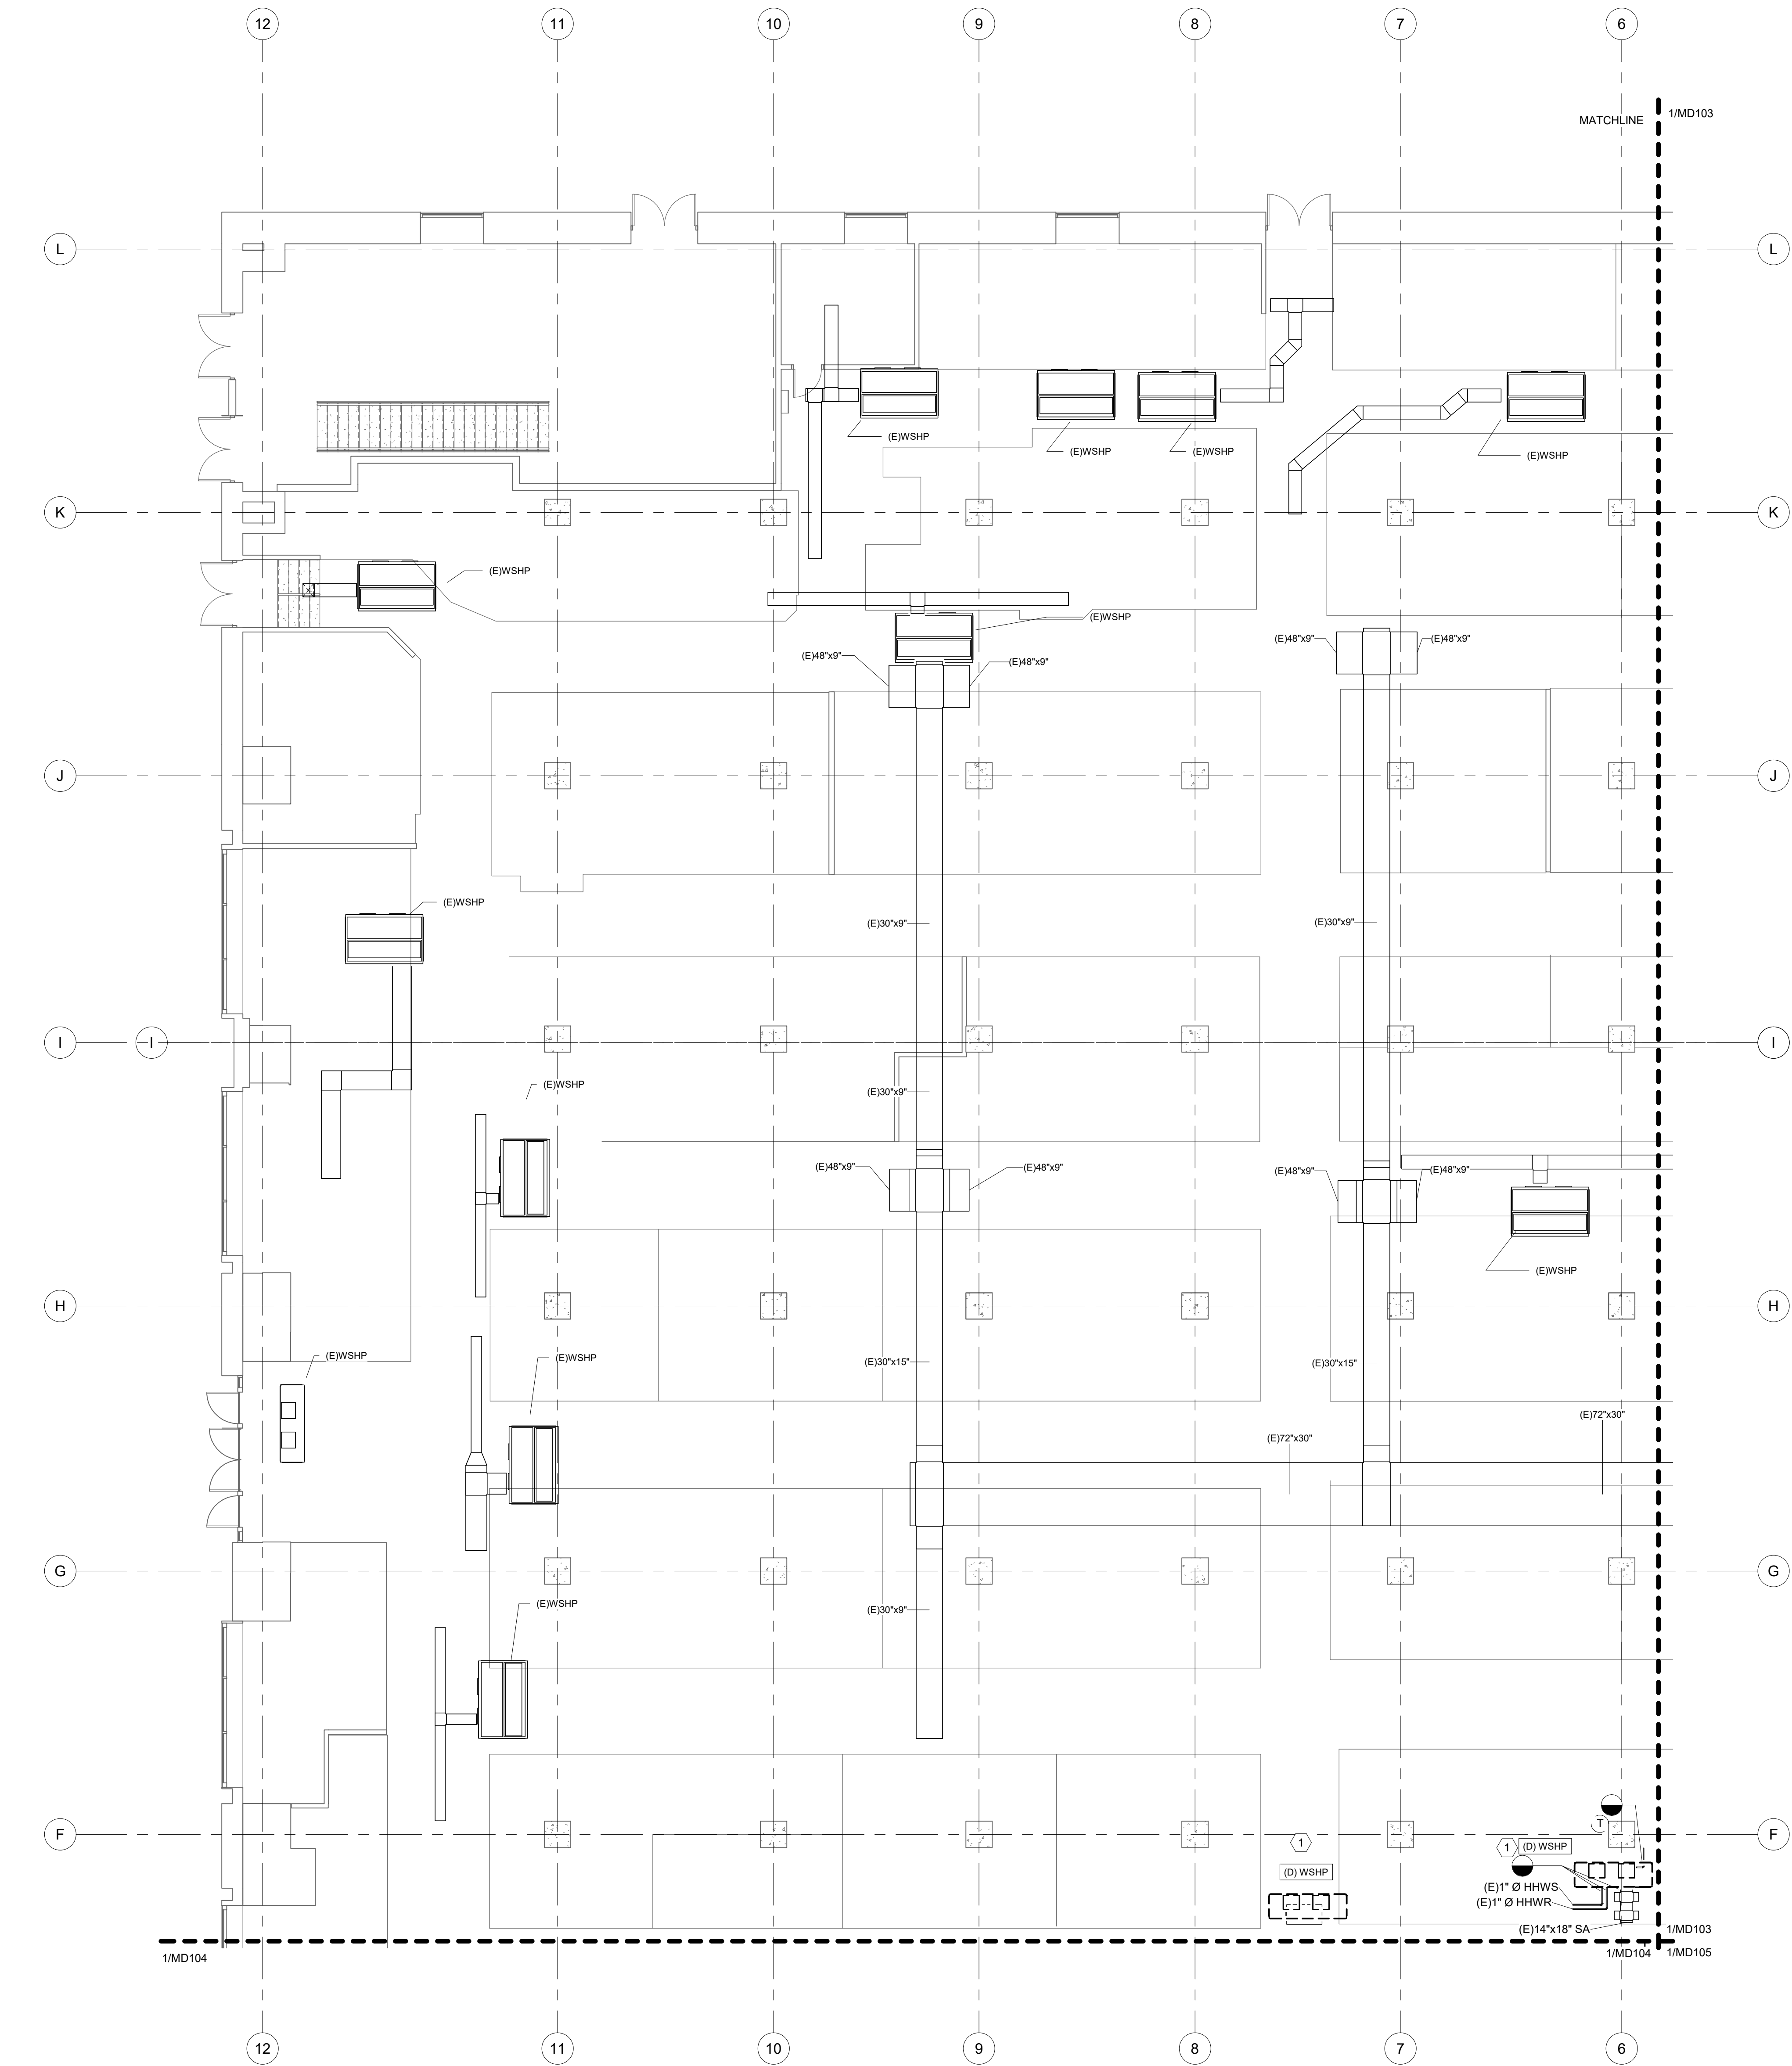
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DRAWING NO.:

MD101

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1 MECHANICAL DEMOLITION GROUND FLOOR PLAN - AREA A
SCALE: 1/8" = 1'-0"

SHEET NOTES

- CLEAN ALL EXISTING DUCTWORK TO REMAIN. INSULATE ALL EXISTING DUCTWORK TO REMAIN, EXCEPT FOR SECTIONS WHERE EXISTING CONDUIT AND EXISTING SPRINKLERS PROHIBIT INSULATION INSTALLATION. INSULATION SHALL BE MINIMUM OF 1" CLEAR FROM EXISTING SPRINKLERS. REFER TO SPECIFICATIONS.

SHEET KEYNOTES

- REMOVE EXISTING WATER SOURCE HEAT PUMP AND ASSOCIATED SUPPORTS AND ELECTRICAL CONNECTIONS. DISCONNECT SUPPLY AIR DUCTWORK, HEATING HOT WATER SUPPLY AND RETURN PIPING, AND CONDENSATE DRAIN PIPING. CAP CONDENSATE WATER PIPING FOR REUSE. CLEAN AIR INTAKE AND SUPPLY FOR REUSE. DISCONNECT AND REMOVE ASSOCIATED THERMOSTAT.



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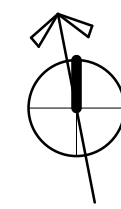
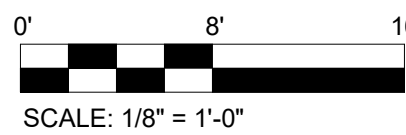
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DATE:					
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DRAWING TITLE:					
MECHANICAL					
DEMOLITION GROUND					
FLOOR PLAN - AREA A					
DRAWING NO.:					
MD102					

1. CLEAN ALL EXISTING DUCTWORK TO REMAIN. INSULATE ALL EXISTING DUCTWORK TO REMAIN, EXCEPT FOR SECTIONS WHERE EXISTING CONDUIT AND EXISTING SPRINKLERS PROHIBIT INSULATION INSTALLATION. INSULATION SHALL BE MINIMUM OF 1" CLEAR FROM EXISTING SPRINKLERS. REFER TO SPECIFICATIONS.

1. REMOVE EXISTING WATER SOURCE HEAT PUMP AND ASSOCIATED SUPPORTS AND ELECTRICAL CONNECTIONS. DISCONNECT SUPPLY AIR DUCTWORK, HEATING HOT WATER SUPPLY AND RETURN PIPING, AND CONDENSATE DRAIN PIPING. CAP CONDENSER WATER PIPING FOR REUSE. CLEAN AIR INTAKE AND SUPPLY FOR REUSE. DISCONNECT AND REMOVE ASSOCIATED THERMOSTAT.
2. DISCONNECT POWER TO EXISTING AIR CURTAIN. REMOVE AIR CURTAIN AND RETURN TO OWNER.



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DESIGNED:	MODELED:	CHECKED:
SAJ	SAJ	BMW

DRAWING TITLE:
MECHANICAL

DRAWING NO. :


MD103

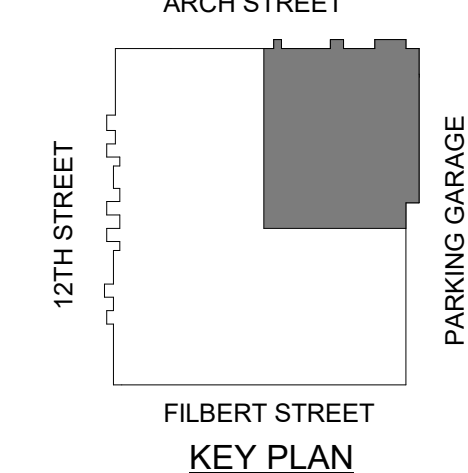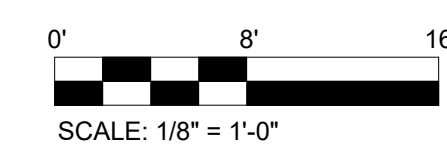

1 MECHANICAL DEMOLITION GROUND FLOOR PLAN - AREA B
SCALE: 1/8" = 1'-0"

Local File:Autodesk Docs\\071274-RTM_Renovation_Project\\071274_ReadTerminalMarket_ME_P022.rvt

Project Number: 071274
2/3/2023 7:59:34 AM

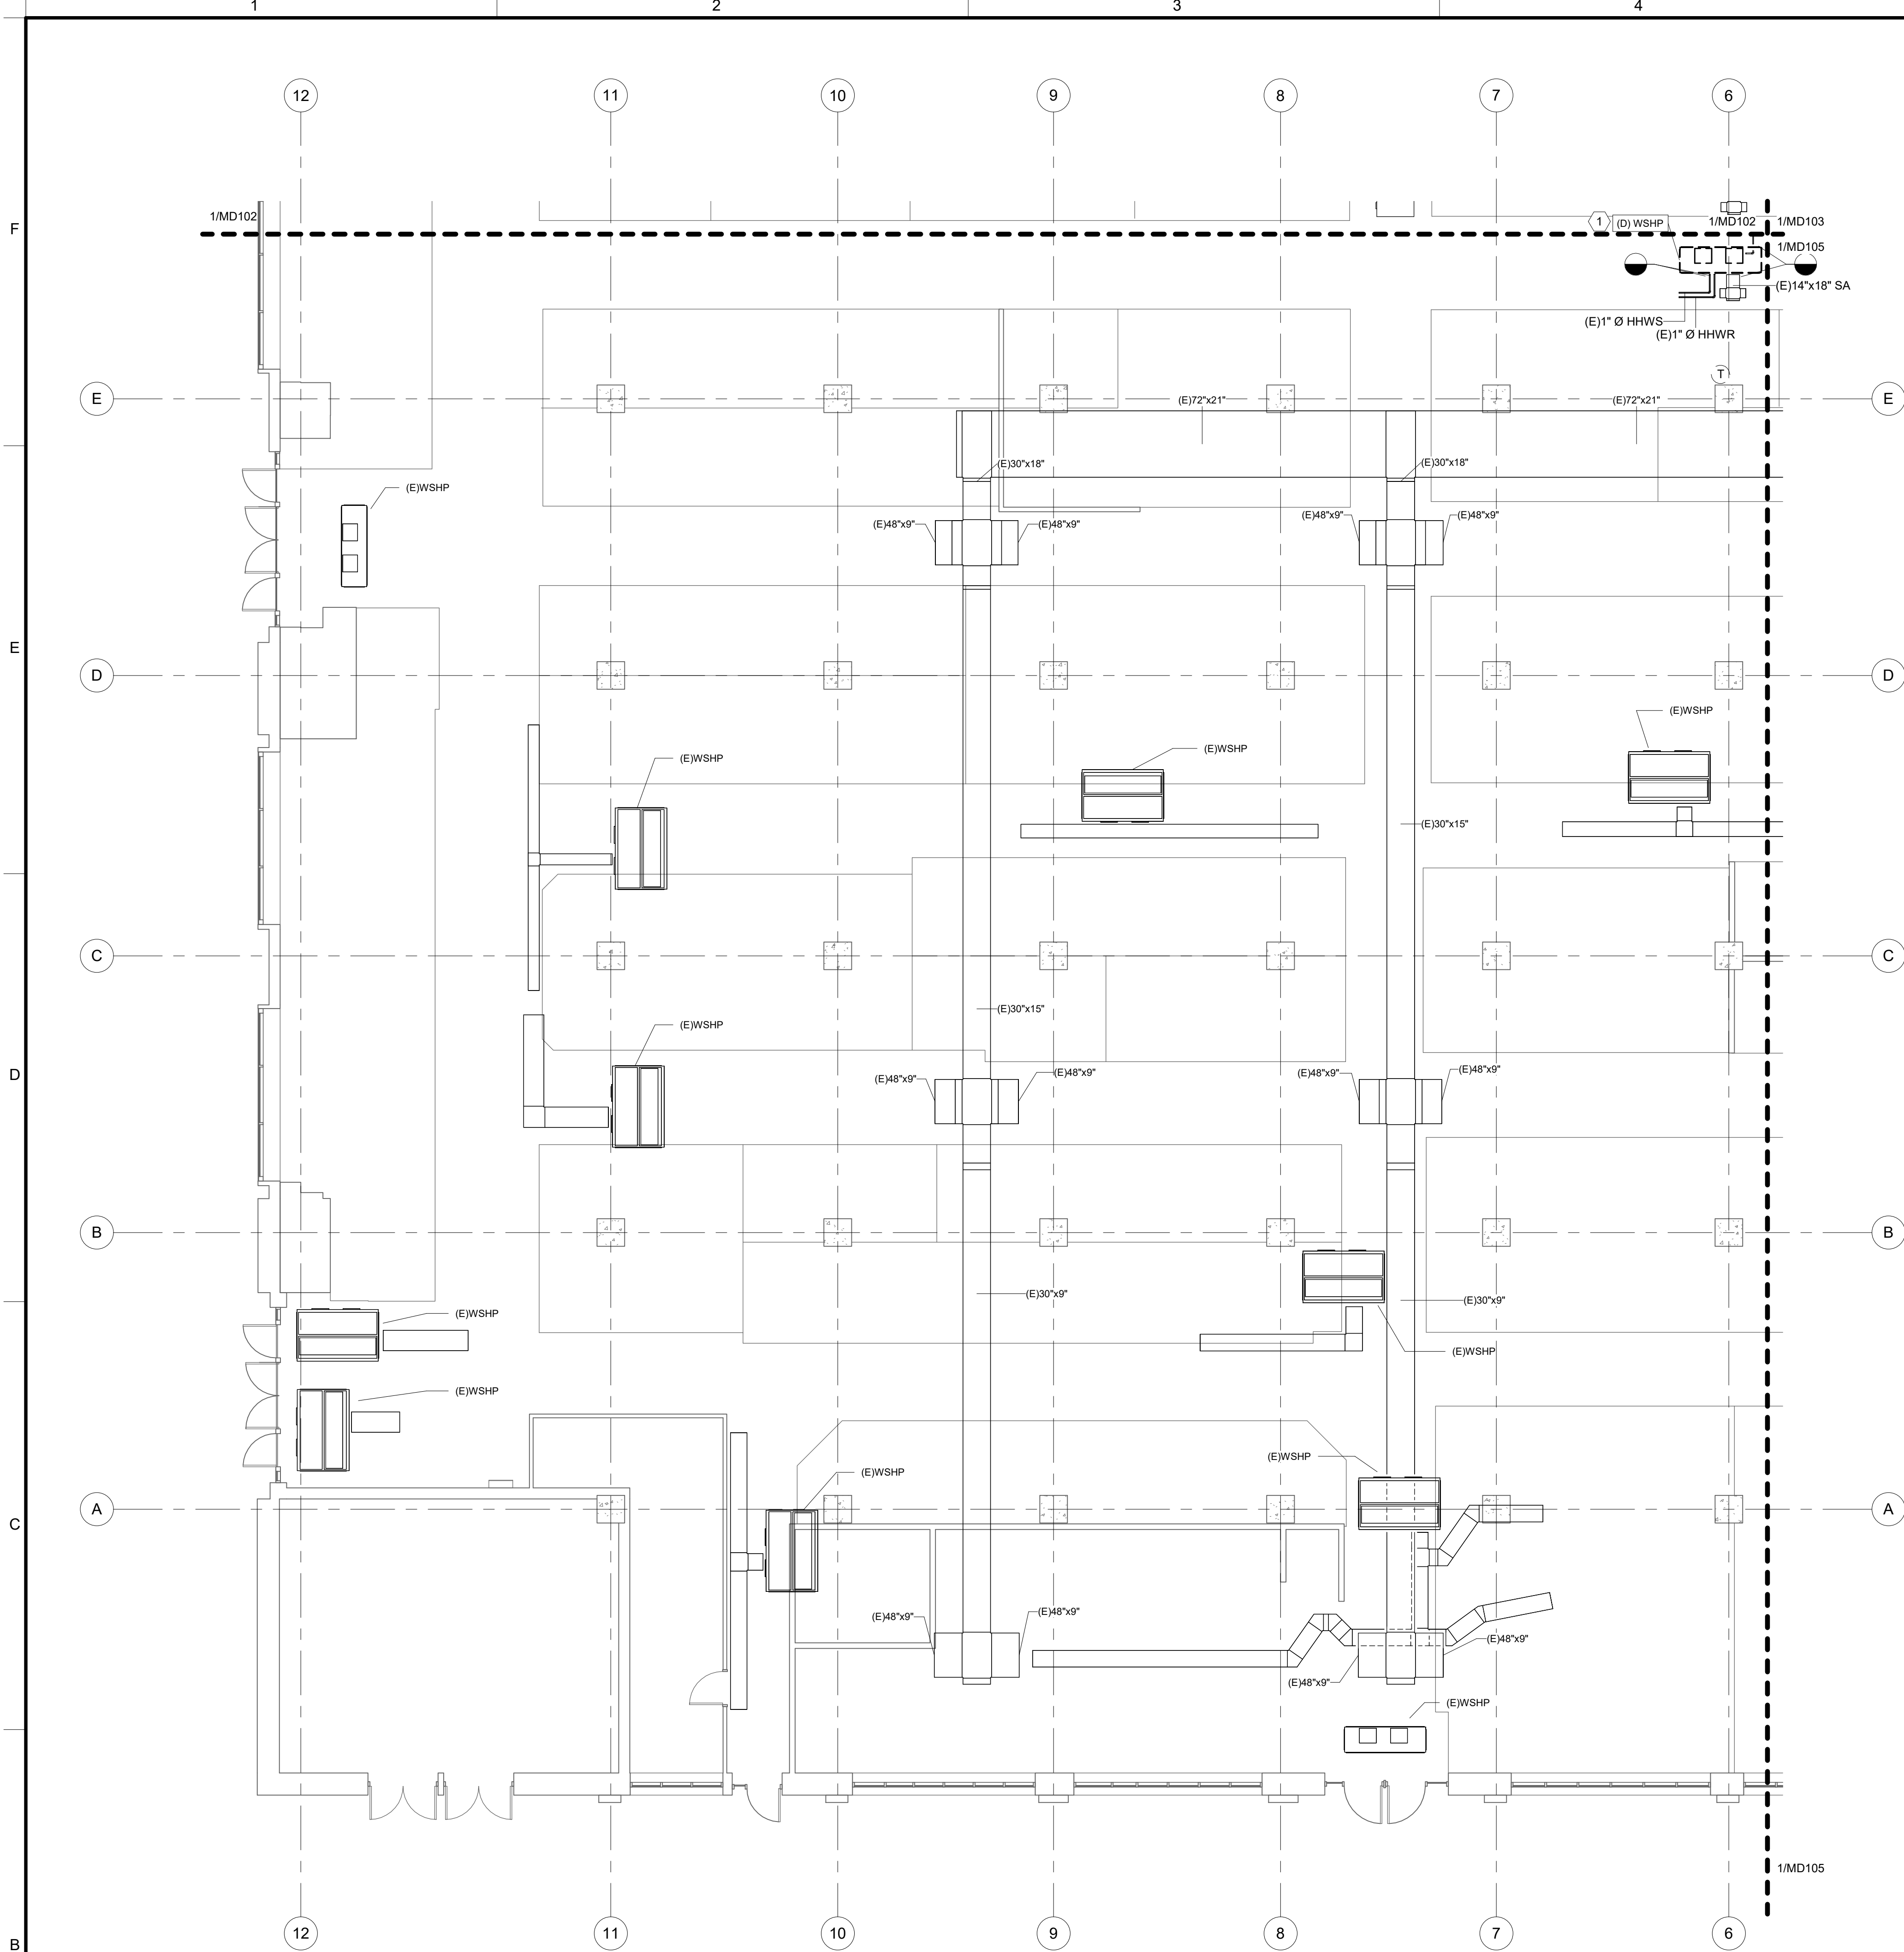

1 MECHANICAL DEMOLITION FLOOR PLAN - AREA C
SCALE: 1/8" = 1'-0"

SHEET NOTES

- CLEAN ALL EXISTING DUCTWORK TO REMAIN. INSULATE ALL EXISTING DUCTWORK TO REMAIN, EXCEPT FOR SECTIONS WHERE EXISTING CONDUIT AND EXISTING SPRINKLERS PROHIBIT INSULATION INSTALLATION. INSULATION SHALL BE MINIMUM OF 1" CLEAR FROM EXISTING SPRINKLERS. REFER TO SPECIFICATIONS.

DEMOLITION KEYNOTES

- REMOVE EXISTING WATER SOURCE HEAT PUMP AND ASSOCIATED SUPPORTS AND ELECTRICAL CONNECTIONS. DISCONNECT SUPPLY AIR DUCTWORK, HEATING HOT WATER SUPPLY AND RETURN PIPING, AND CONDENSATE DRAIN PIPING. CAP CONDENSER WATER PIPING FOR REUSE. CLEAN AIR INTAKE AND SUPPLY FOR REUSE. DISCONNECT AND REMOVE ASSOCIATED THERMOSTAT.



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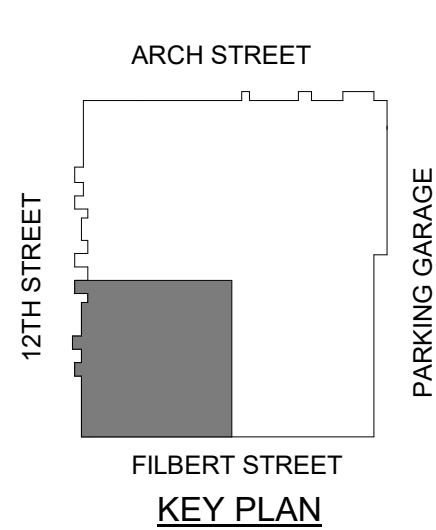
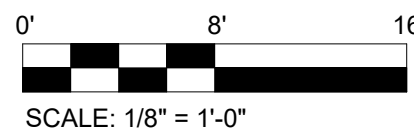
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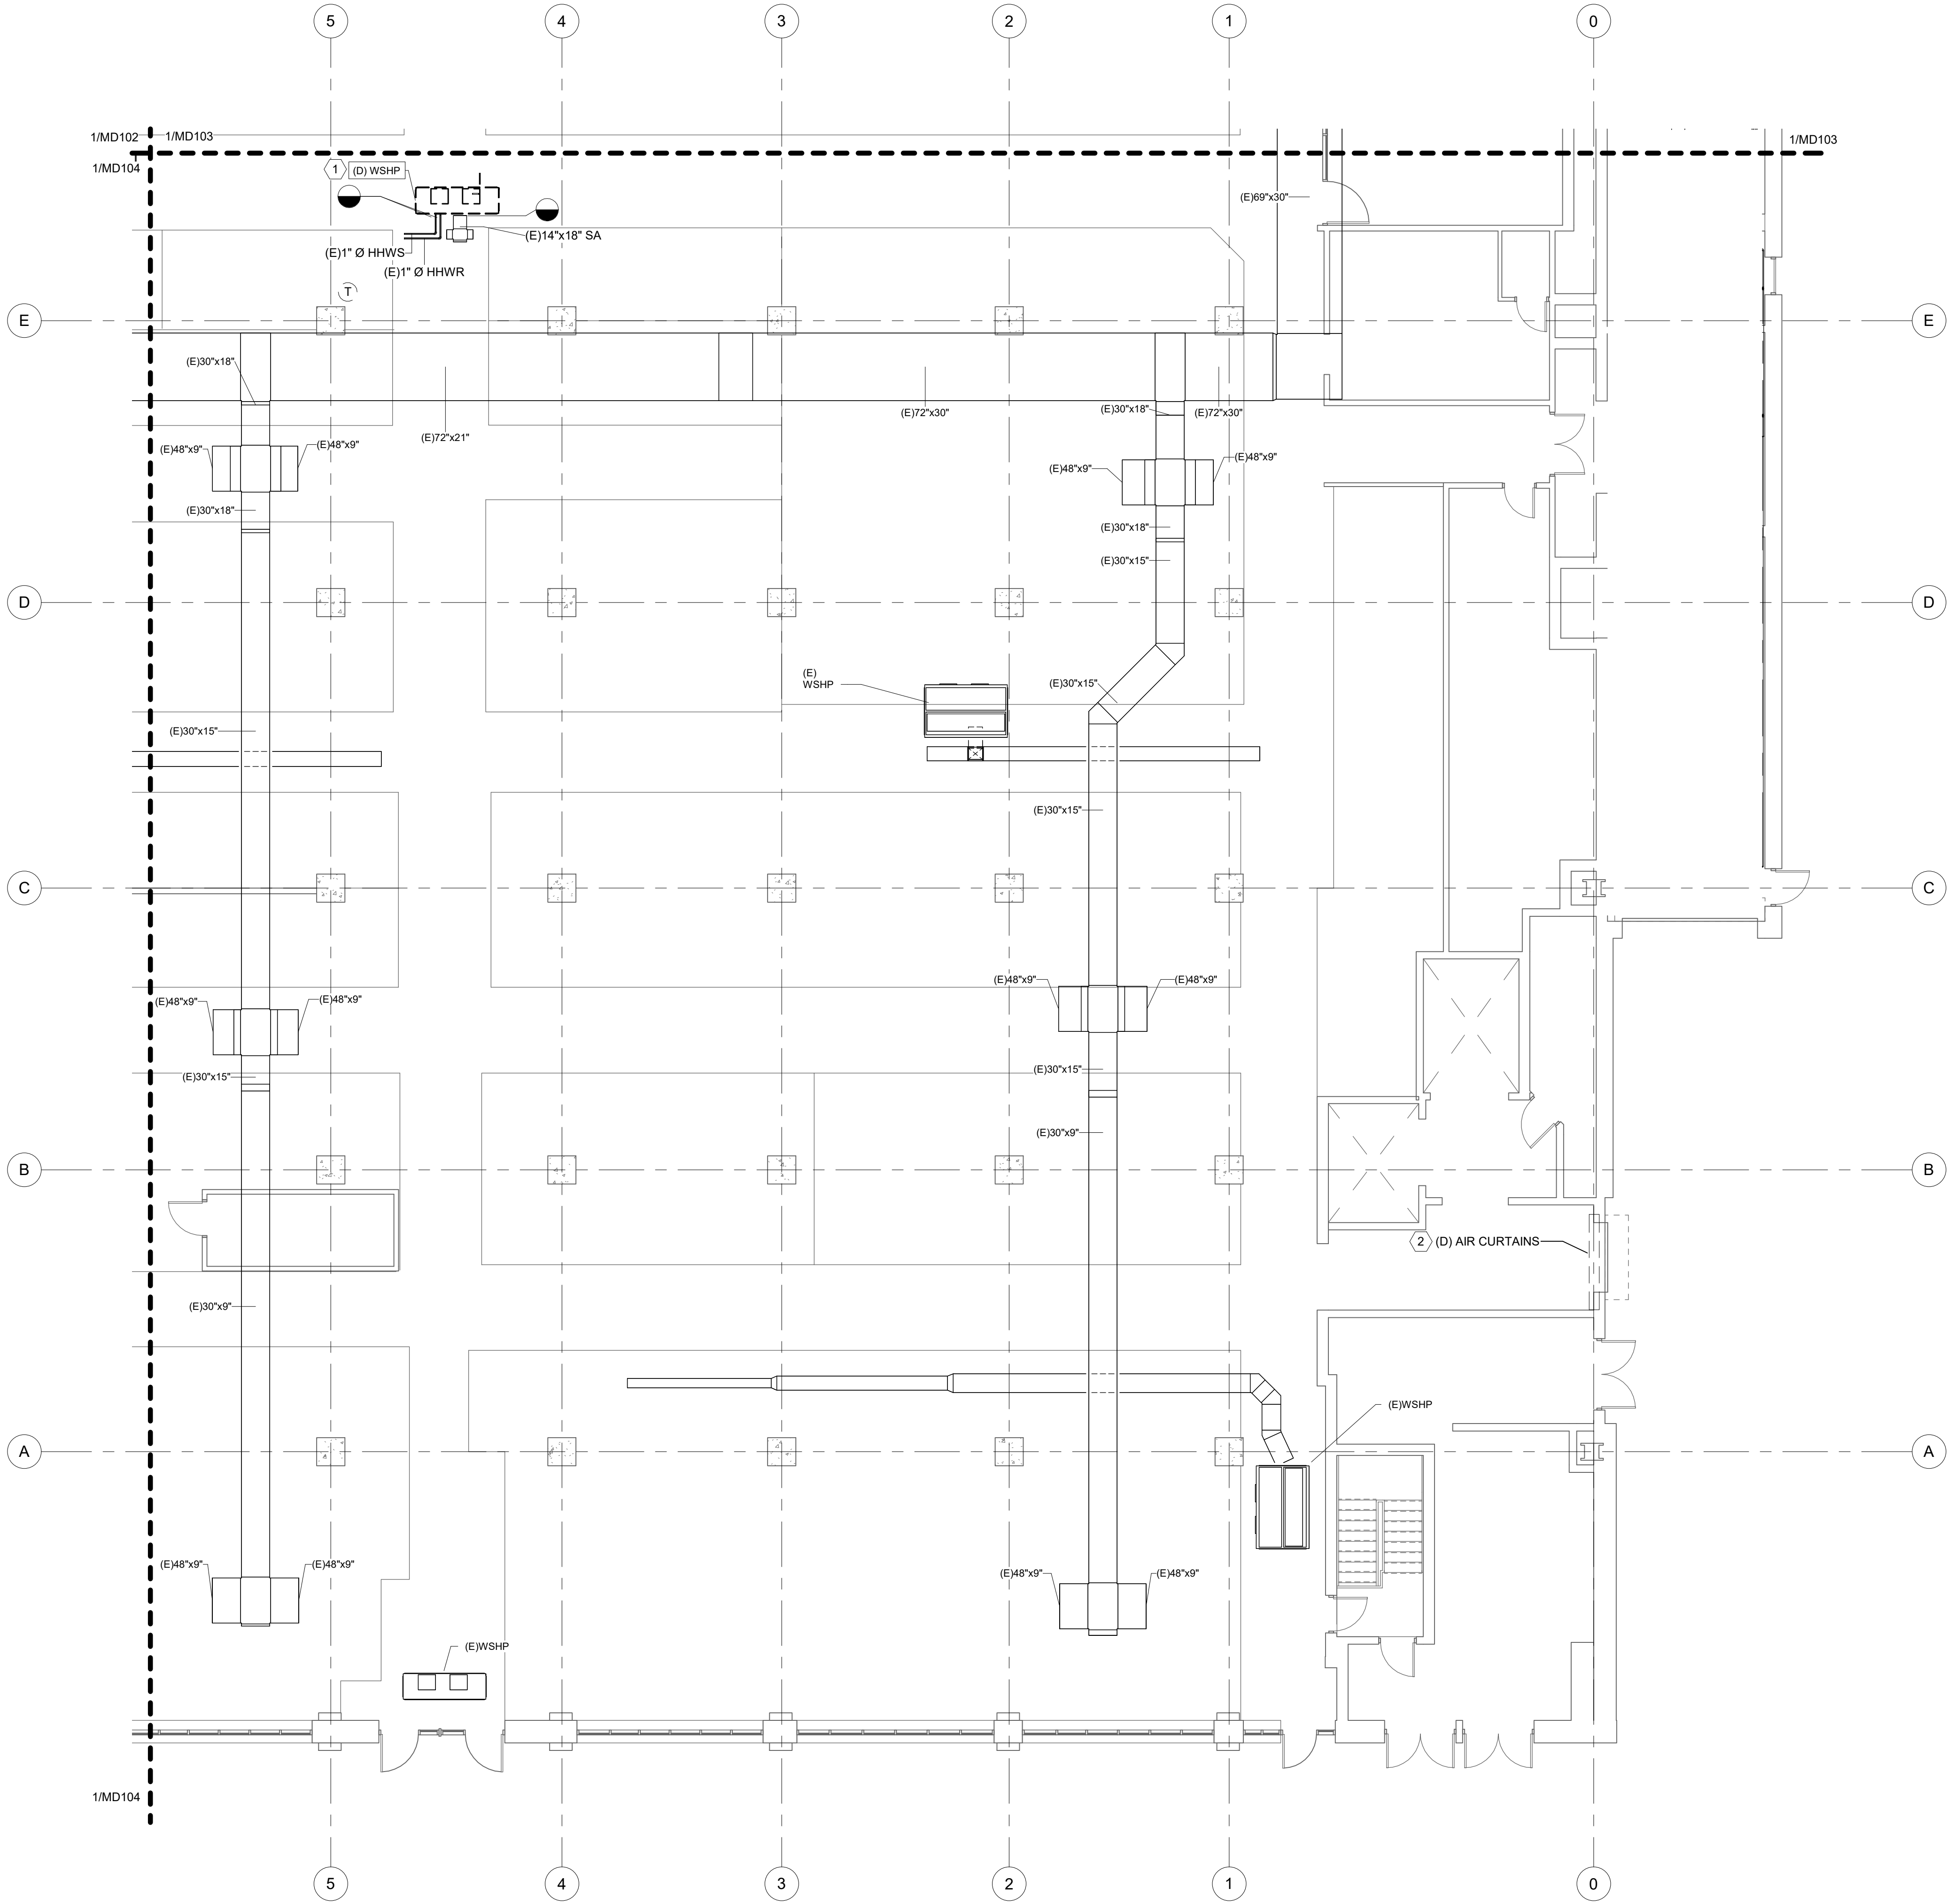
51 N TWELFTH STREET, PHILADELPHIA PA, 19107

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NO.		DATE	DESCRIPTION
REVISIONS			
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PROJECT NUMBER: 071274			
DESIGNED: SAJ	MODELED: SAJ	CHECKED: BMW	
DATE: 02/03/23			
DRAWING TITLE: MECHANICAL DEMOLITION GROUND FLOOR PLAN - AREA C			
DRAWING NO.: MD104			

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Project Number: 071274
2/3/2023 7:59:36 AM



1 MECHANICAL DEMOLITION GROUND FLOOR PLAN - AREA D
SCALE: 1/8" = 1'-0"

SHEET NOTES

- CLEAN ALL EXISTING DUCTWORK TO REMAIN. INSULATE ALL EXISTING DUCTWORK TO REMAIN, EXCEPT FOR SECTIONS WHERE EXISTING CONDUIT AND EXISTING SPRINKLERS PROHIBIT INSULATION INSTALLATION. INSULATION SHALL BE MINIMUM OF 1" CLEAR FROM EXISTING SPRINKLERS. REFER TO SPECIFICATIONS.

DEMOLITION KEYNOTES

- REMOVE EXISTING WATER SOURCE HEAT PUMP AND ASSOCIATED SUPPORTS AND ELECTRICAL CONNECTIONS. DISCONNECT SUPPLY AIR DUCTWORK, HEATING HOT WATER SUPPLY AND RETURN PIPING, AND CONDENSATE DRAIN PIPING. CAP CONDENSER WATER PIPING FOR REUSE. CLEAN AIR INTAKE AND SUPPLY FOR REUSE. DISCONNECT AND REMOVE ASSOCIATED THERMOSTAT.
- DISCONNECT POWER TO EXISTING AIR CURTAIN. REMOVE AIR CURTAIN AND RETURN TO OWNER.



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NO.	DATE	DESCRIPTION
REVISIONS		

GENERAL PACKAGE

PROJECT NUMBER:
071274

DESIGNED: SAJ	MODELED: SAJ	CHECKED: BMW
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DATE:

02/03/23

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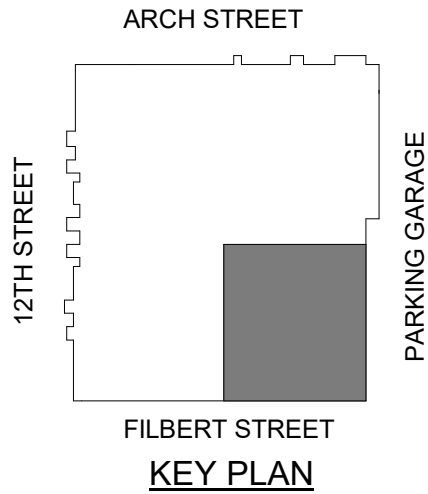
MECHANICAL

DEMOLITION GROUND
FLOOR PLAN - AREA D

DRAWING NO.:

MD105


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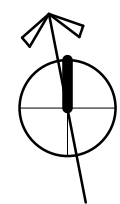
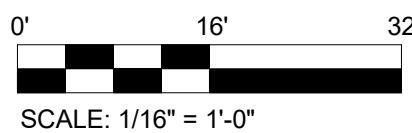
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Project Number: 071274
2/20/2023 7:59:17 AM

F
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D
C
B
A



1 MECHANICAL NEW WORK GROUND FLOOR OVERALL PLAN
SCALE: 1/16" = 1'-0"

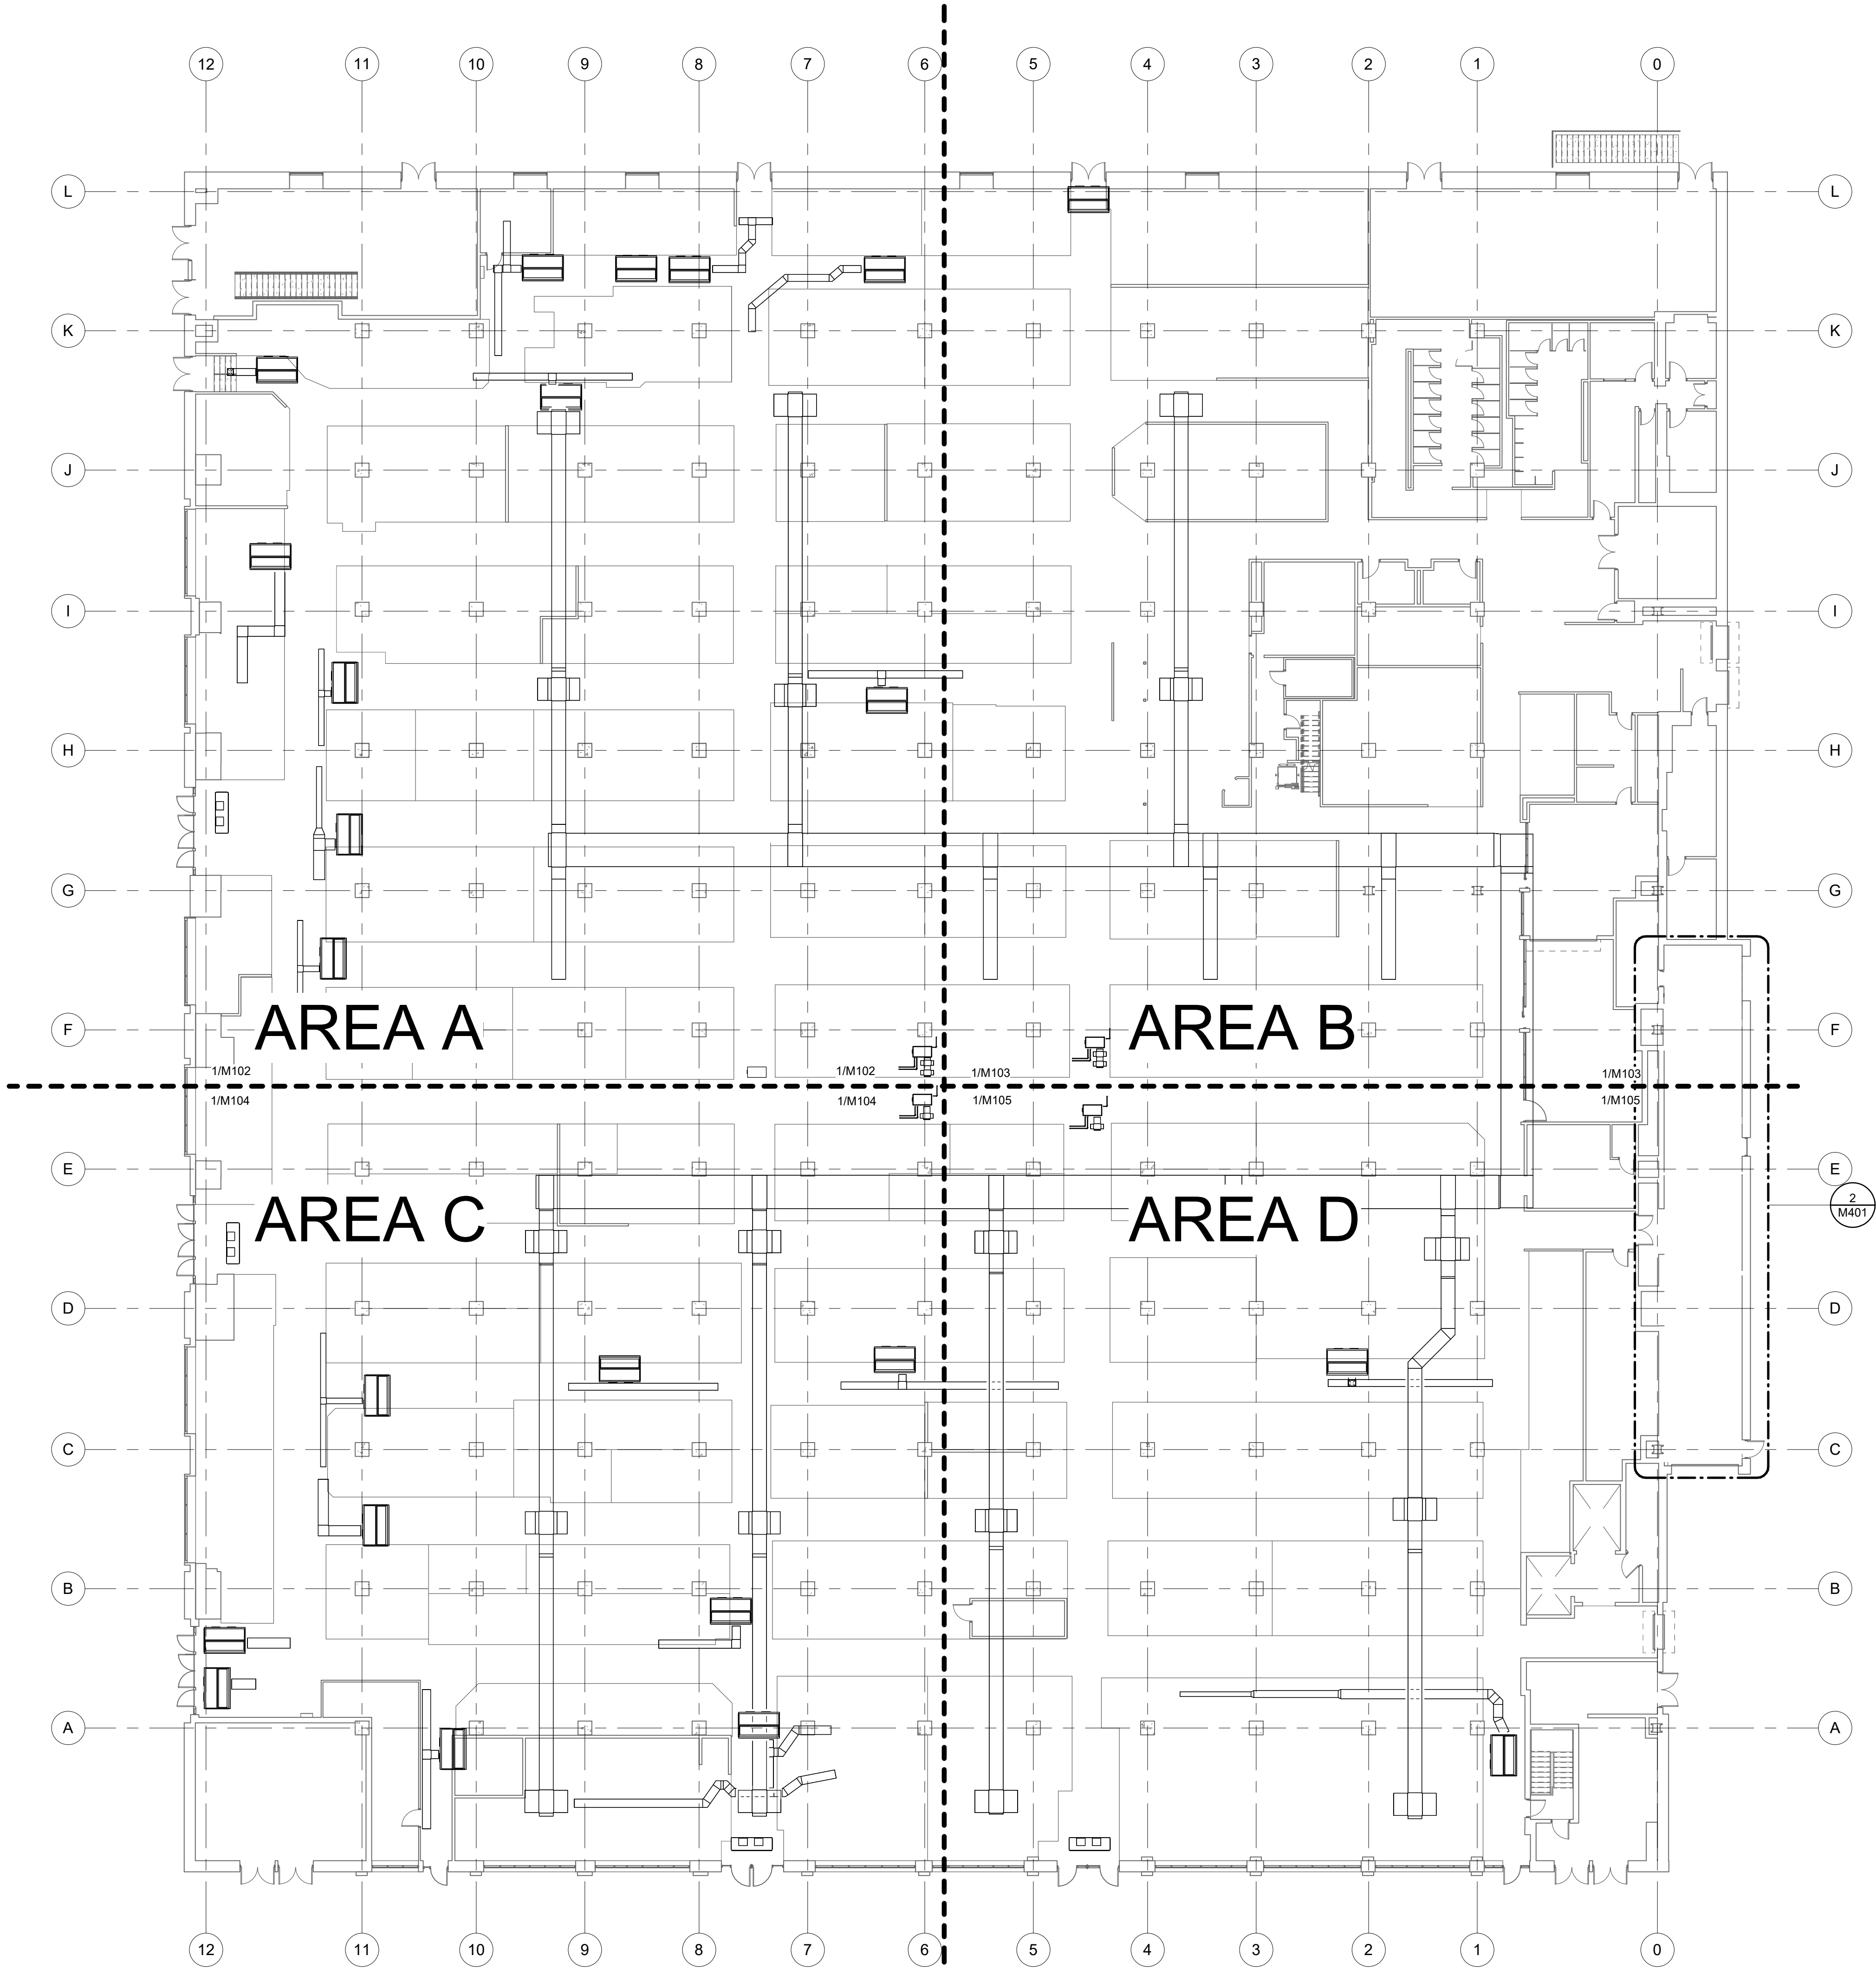

SHEET NOTES

- CLEAN ALL EXISTING DUCTWORK TO REMAIN. INSULATE ALL EXISTING DUCTWORK TO REMAIN, EXCEPT FOR SECTIONS WHERE EXISTING CONDUIT AND EXISTING SPRINKLERS PROHIBIT INSULATION INSTALLATION. INSULATION SHALL BE MINIMUM OF 1" CLEAR FROM EXISTING SPRINKLERS. REFER TO SPECIFICATIONS.



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NO.	DATE	DESCRIPTION

REVISIONS

GENERAL PACKAGE

PROJECT NUMBER:
071274

DESIGNED: SAJ	MODELED: SAJ	CHECKED: BMW
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DATE:
02/03/23

DRAWING TITLE:
**MECHANICAL
NEW WORK GROUND
FLOOR OVERALL PLAN**

DRAWING NO.:


M101

Local File:Autodesk Docs\\071274-RTM_Renovation_Project\\071274_ReadTerminalMarket MEP_R22.rvt

Project Number: 071274
2/3/2023 7:59:19 AM

1 MECHANICAL NEW WORK GROUND FLOOR PLAN - AREA A

SCALE: 1/8" = 1'-0"

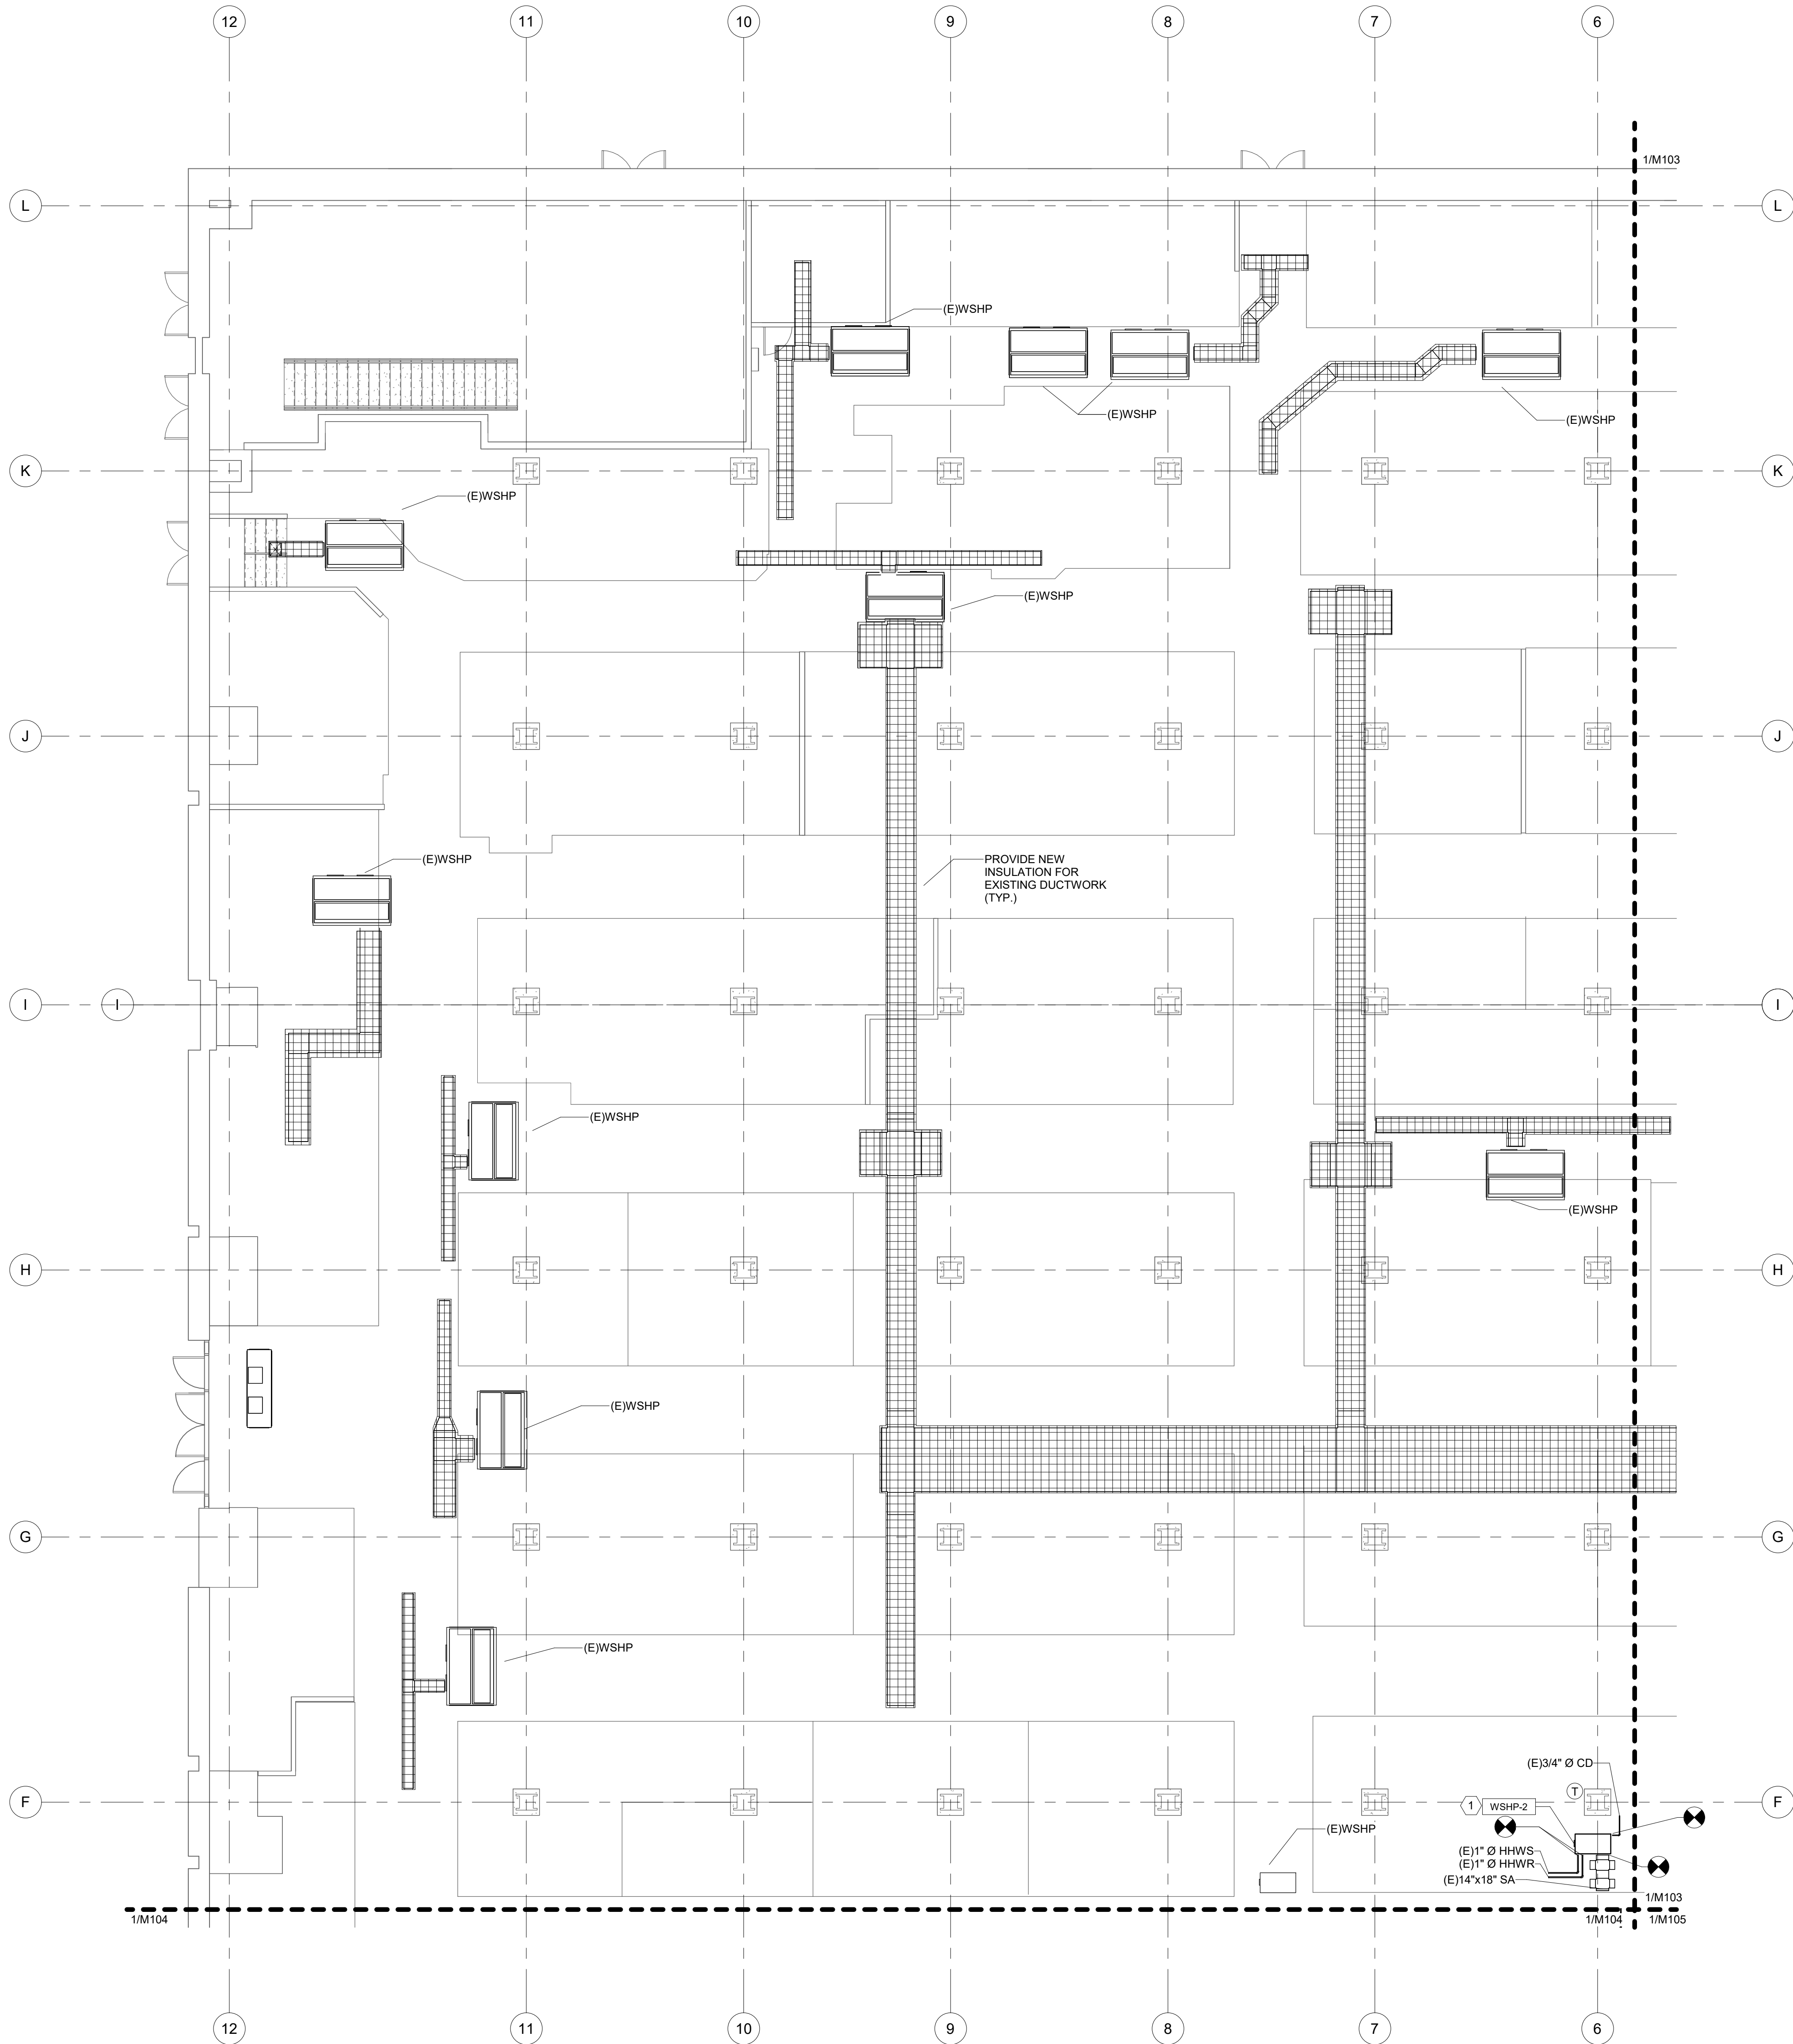

SHEET NOTES

- CLEAN ALL EXISTING DUCTWORK TO REMAIN. INSULATE ALL EXISTING DUCTWORK TO REMAIN, EXCEPT FOR SECTIONS WHERE EXISTING CONDUIT AND EXISTING SPRINKLERS PROHIBIT INSULATION INSTALLATION. INSULATION SHALL BE MINIMUM OF 1" CLEAR FROM EXISTING SPRINKLERS. REFER TO SPECIFICATIONS.

SHEET KEYNOTES

- PROVIDE NEW CEILING-MOUNTED WATER SOURCE HEAT PUMP. CONNECT TO EXISTING HEATING HOT WATER SUPPLY AND RETURN PIPING. CONNECT TO EXISTING CONDENSATE DRAIN PIPING. CONNECT TO EXISTING SUPPLY AIR DUCTWORK. PROVIDE FLEXIBLE DUCTWORK CONNECTION. PROVIDE NEW THERMOSTAT WITH CLEAR LEXAN LOCKABLE COVER, 10 FEET ABOVE FINISHED FLOOR. COORDINATE ELECTRICAL CONNECTIONS WITH THE ELECTRICAL CONTRACTOR.



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NO. DATE DESCRIPTION

REVISIONS

GENERAL PACKAGE

PROJECT NUMBER:

071274

DESIGNED:

SAJ

MODELED:

SAJ

CHECKED:

BMW

DATE:

02/03/23

DRAWING TITLE:

MECHANICAL

NEW WORK GROUND
FLOOR PLAN - AREA A


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M102

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SCALE: 1/8" = 1'-0"



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Project Number: 071274
2/3/2023 7:59:20 AM

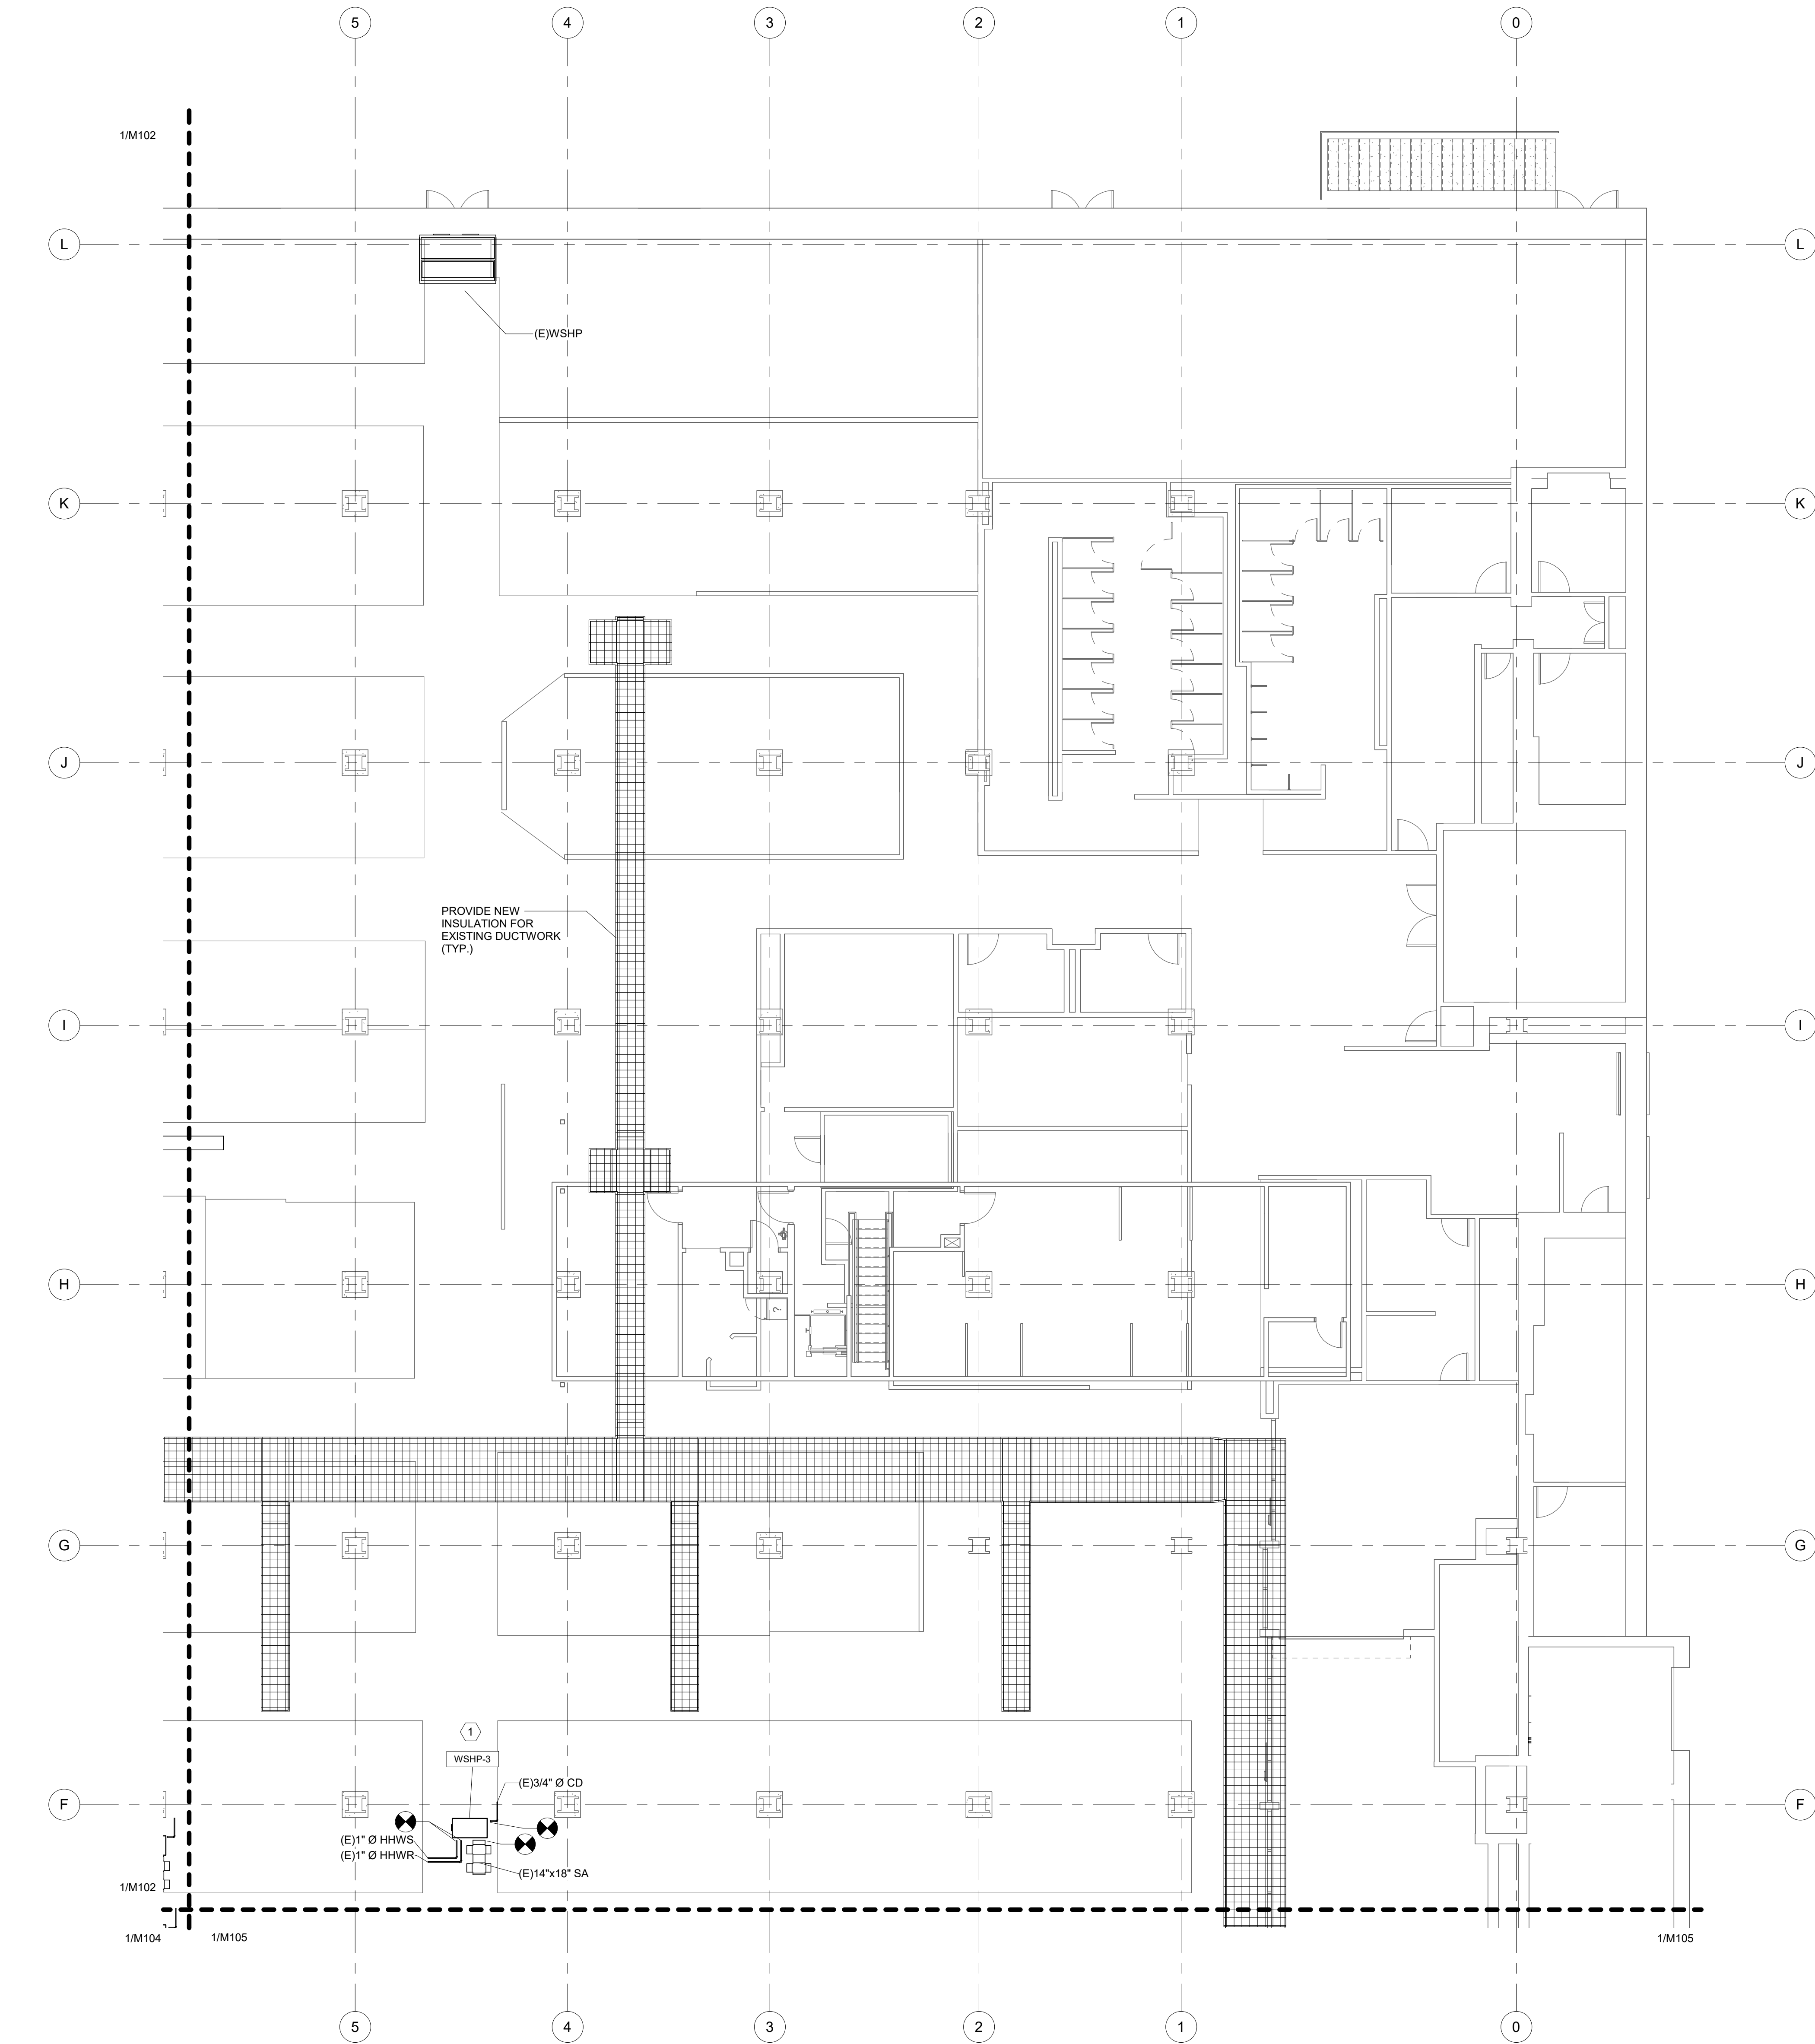

1 MECHANICAL NEW WORK GROUND FLOOR PLAN - AREA B
SCALE: 1/8" = 1'-0"


SHEET NOTES

1. CLEAN ALL EXISTING DUCTWORK TO REMAIN. INSULATE ALL EXISTING DUCTWORK TO REMAIN, EXCEPT FOR SECTIONS WHERE EXISTING CONDUIT AND EXISTING SPRINKLERS PROHIBIT INSULATION INSTALLATION. INSULATION SHALL BE MINIMUM OF 1" CLEAR FROM EXISTING SPRINKLERS. REFER TO SPECIFICATIONS.

SHEET KEYNOTES

1. PROVIDE NEW CEILING-MOUNTED WATER SOURCE HEAT PUMP. CONNECT TO EXISTING HEATING HOT WATER SUPPLY AND RETURN PIPING. CONNECT TO EXISTING CONDENSATE DRAIN PIPING. CONNECT TO EXISTING SUPPLY AIR DUCTWORK. PROVIDE FLEXIBLE DUCTWORK CONNECTION. PROVIDE NEW THERMOSTAT WITH CLEAR LEXAN LOOKABLE COVER, 10 FEET ABOVE FINISHED FLOOR. COORDINATE ELECTRICAL CONNECTIONS WITH THE ELECTRICAL CONTRACTOR.

0' 8' 16'
SCALE: 1/8" = 1'-0"

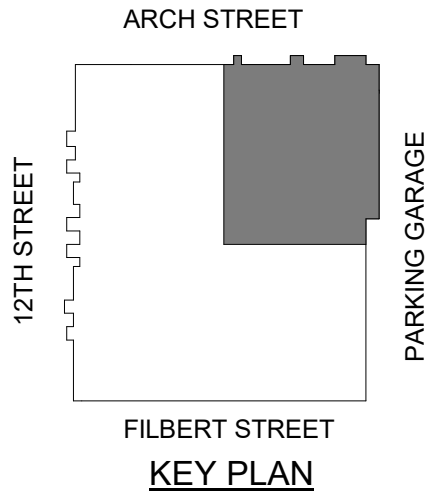

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REVISIONS		


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PROJECT NUMBER: 071274		
DESIGNED: SAJ	MODELED: SAJ	CHECKED: BMW

DATE: 02/03/23
DRAWING TITLE: MECHANICAL NEW WORK GROUND FLOOR PLAN - AREA B
DRAWING NO.:

M103

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Project Number: 071274
2/3/2023 7:59:21 AM

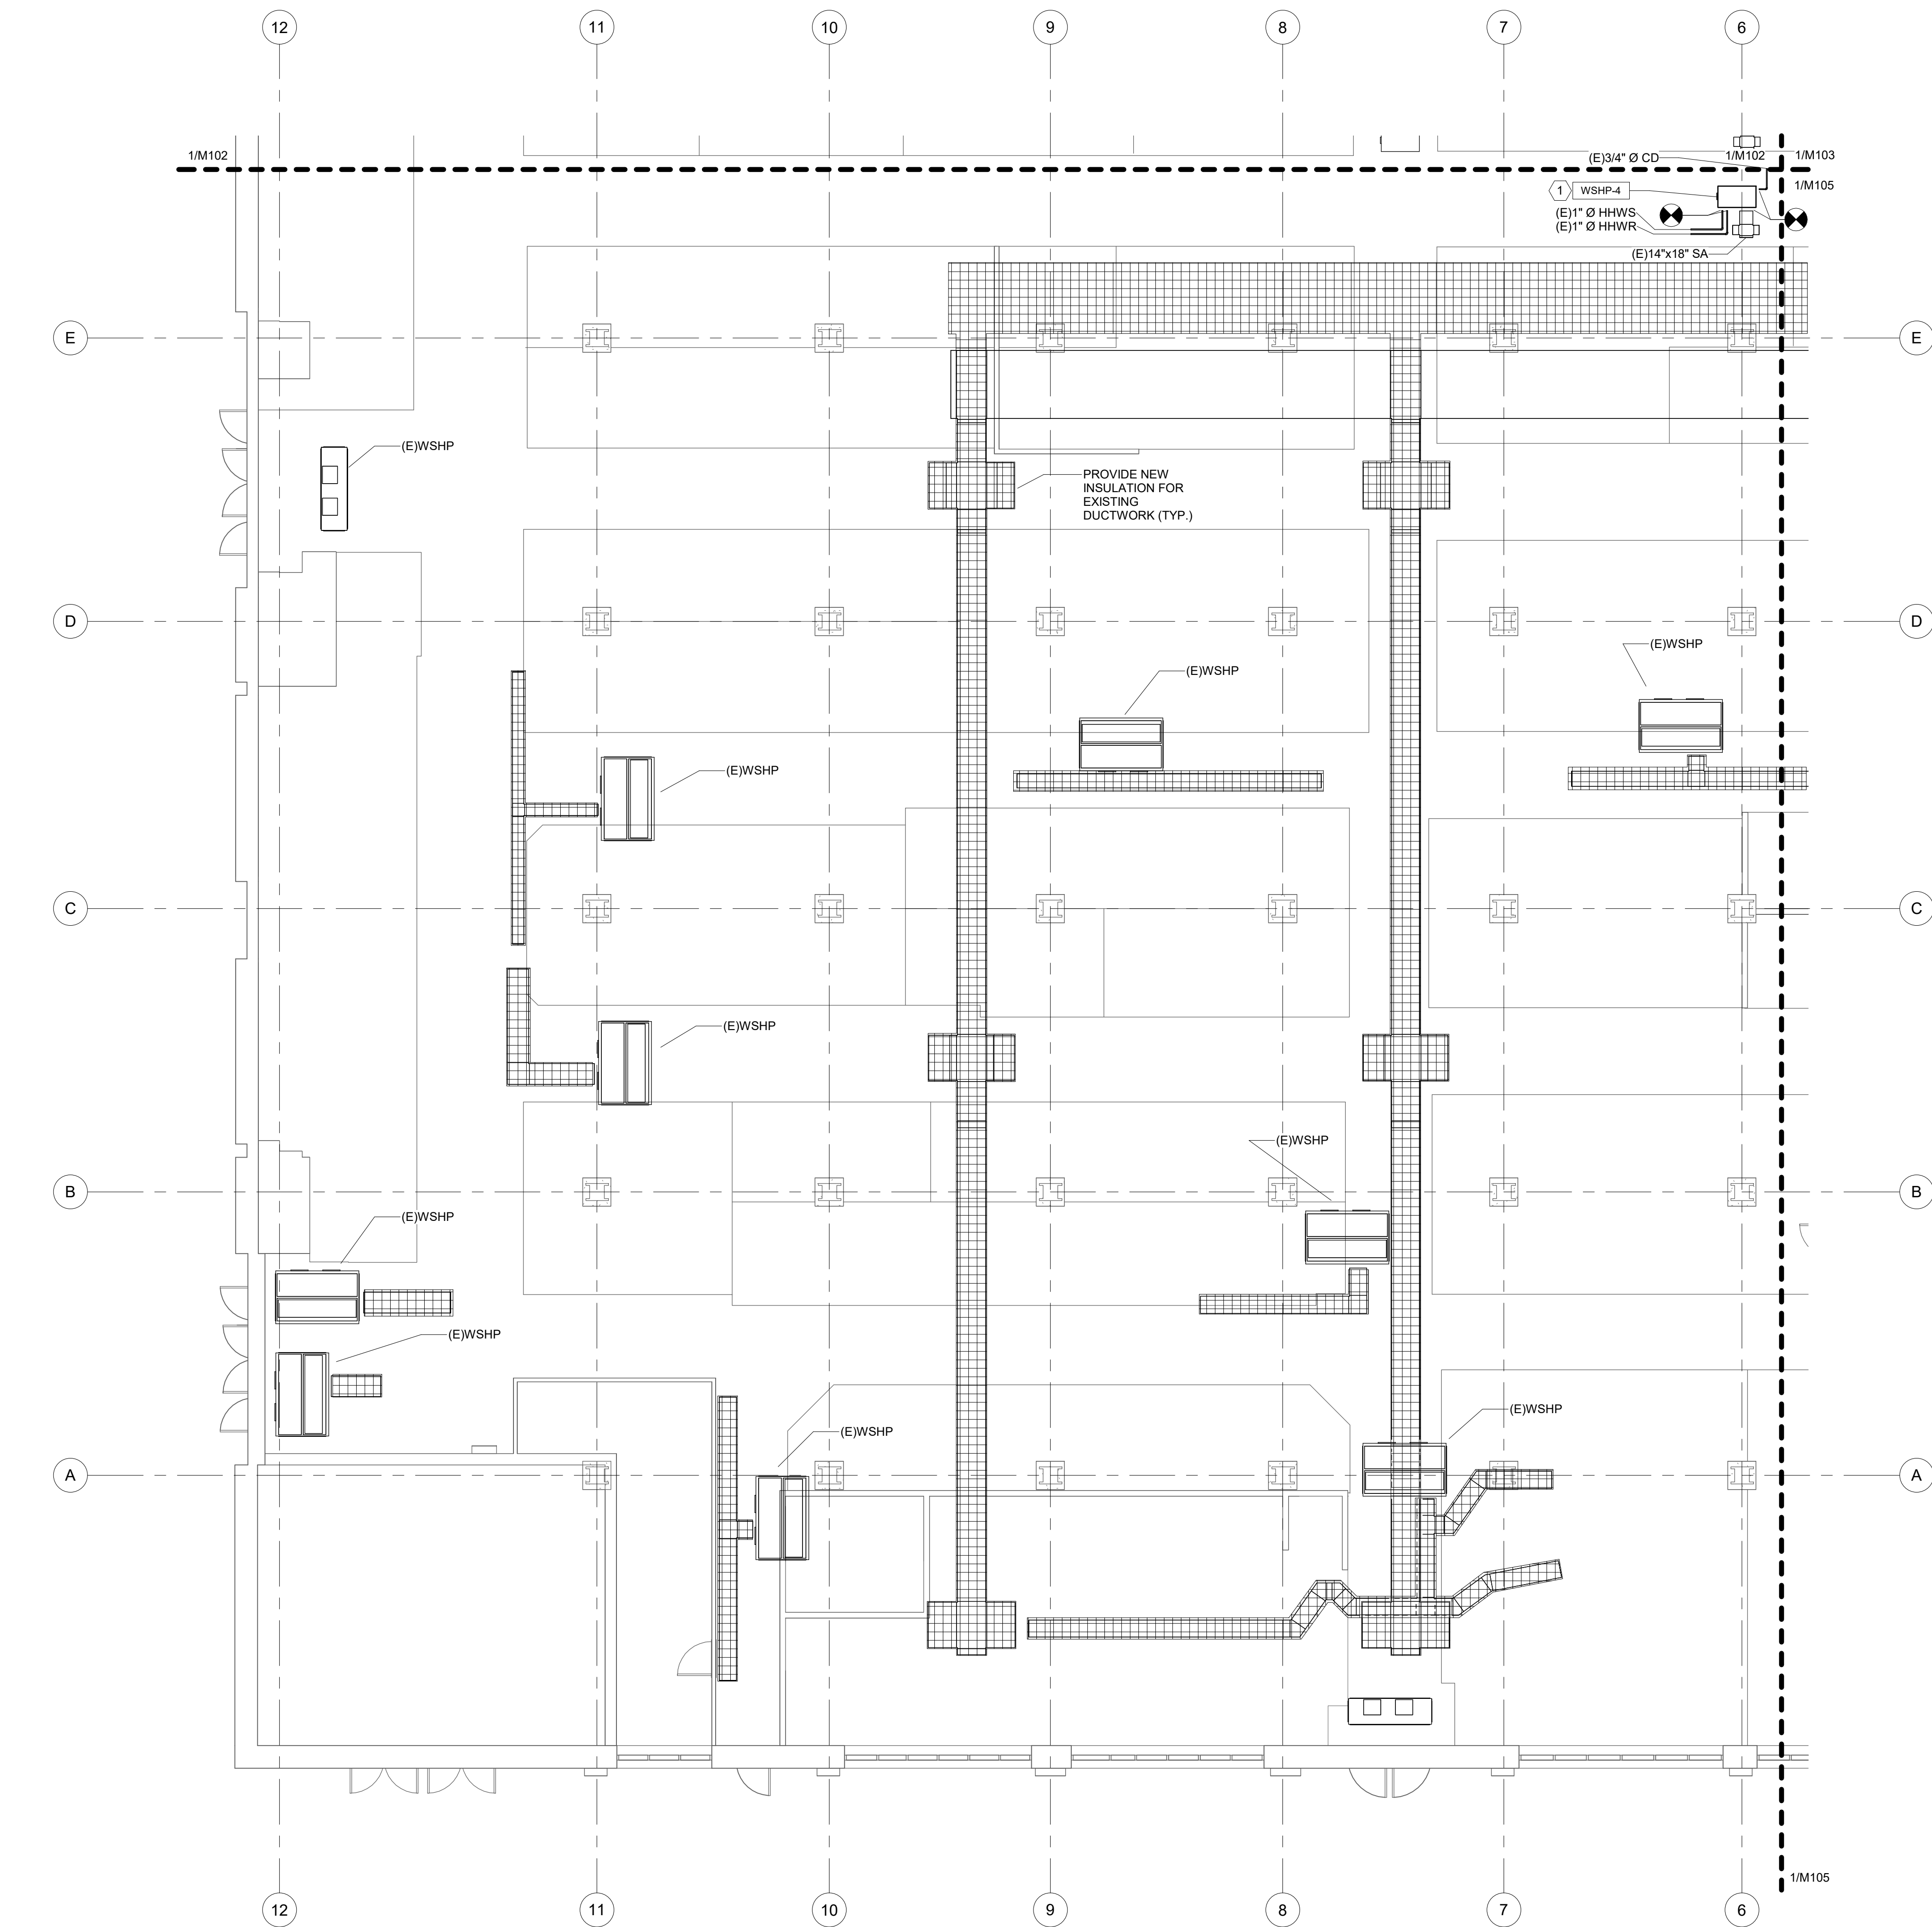


1 MECHANICAL NEW WORK GROUND FLOOR PLAN - AREA C
SCALE: 1/8" = 1'-0"

SHEET NOTES

- CLEAN ALL EXISTING DUCTWORK TO REMAIN. INSULATE ALL EXISTING DUCTWORK TO REMAIN, EXCEPT FOR SECTIONS WHERE EXISTING CONDUIT AND EXISTING SPRINKLERS PROHIBIT INSULATION INSTALLATION. INSULATION SHALL BE MINIMUM OF 1" CLEAR FROM EXISTING SPRINKLERS. REFER TO SPECIFICATIONS.

SHEET KEYNOTES

- PROVIDE NEW CEILING-MOUNTED WATER SOURCE HEAT PUMP. CONNECT TO EXISTING HEATING HOT WATER SUPPLY AND RETURN PIPING. CONNECT TO EXISTING CONDENSATE DRAIN PIPING. CONNECT TO EXISTING SUPPLY AIR DUCTWORK. PROVIDE FLEXIBLE DUCTWORK CONNECTION. PROVIDE NEW THERMOSTAT WITH CLEAR LEXAN LOCKABLE COVER, 10 FEET ABOVE FINISHED FLOOR. COORDINATE ELECTRICAL CONNECTIONS WITH THE ELECTRICAL CONTRACTOR.

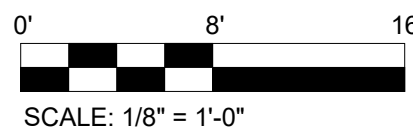

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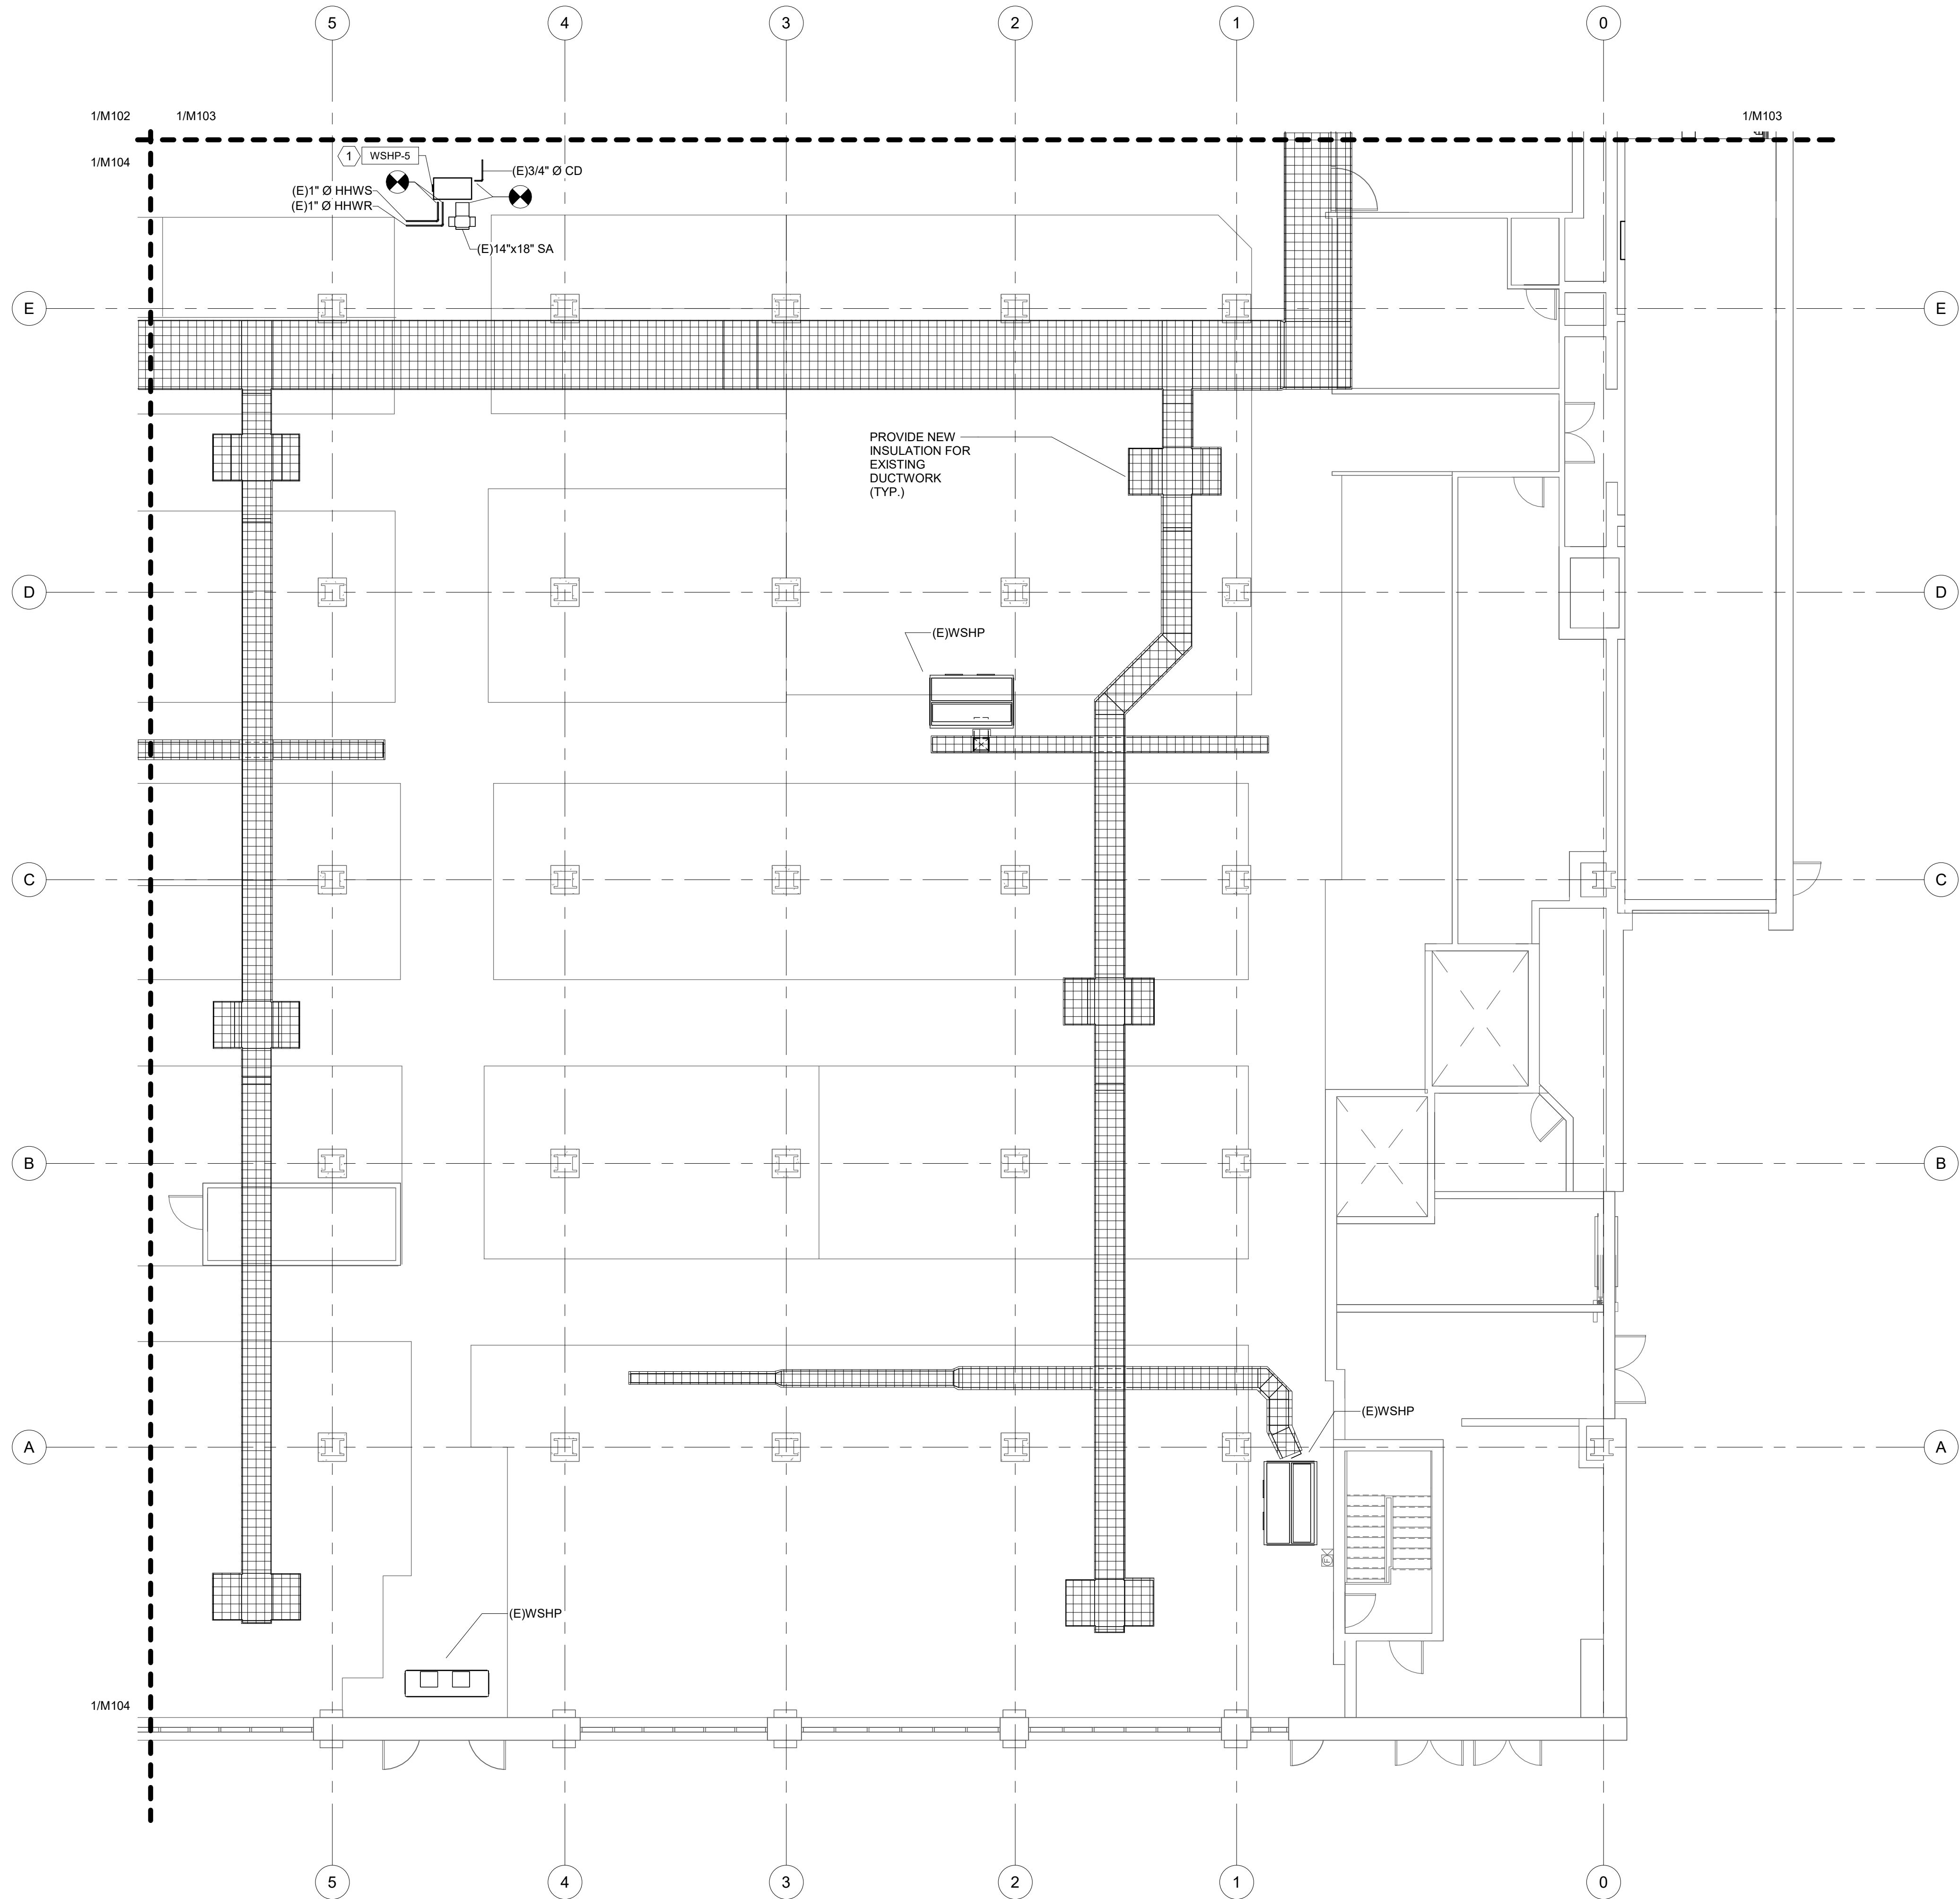
READING TERMINAL MARKET CAPITAL IMPROVEMENTS

NO.		DATE	DESCRIPTION
REVISIONS			
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PROJECT NUMBER: 071274			
DESIGNED: SAJ	MODELED: SAJ	CHECKED: BMW	
DATE: 02/03/23			
DRAWING TITLE: MECHANICAL NEW WORK GROUND FLOOR PLAN - AREA C			
DRAWING NO.: M104			

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Project Number: 071274
2/3/2023 7:59:22 AM

1 MECHANICAL NEW WORK GROUND FLOOR PLAN - AREA D

SCALE: 1/8" = 1'-0"




SHEET NOTES

- CLEAN ALL EXISTING DUCTWORK TO REMAIN. INSULATE ALL EXISTING DUCTWORK TO REMAIN. EXCEPT FOR SECTIONS WHERE EXISTING CONDUIT AND EXISTING SPRINKLERS PROHIBIT INSULATION INSTALLATION. INSULATION SHALL BE MINIMUM OF 1" CLEAR FROM EXISTING SPRINKLERS. REFER TO SPECIFICATIONS.

SHEET KEYNOTES

- PROVIDE NEW CEILING-MOUNTED WATER SOURCE HEAT PUMP. CONNECT TO EXISTING HEATING HOT WATER SUPPLY AND RETURN PIPING. CONNECT TO EXISTING CONDENSATE DRAIN PIPING. CONNECT TO EXISTING SUPPLY AIR DUCTWORK. PROVIDE FLEXIBLE DUCTWORK CONNECTION. PROVIDE NEW THERMOSTAT WITH CLEAR LEXAN LOCKABLE COVER, 10 FEET ABOVE FINISHED FLOOR. COORDINATE ELECTRICAL CONNECTIONS WITH THE ELECTRICAL CONTRACTOR.

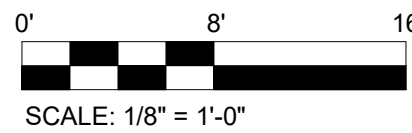

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NO.	DATE	DESCRIPTION

REVISIONS

GENERAL PACKAGE

PROJECT NUMBER:
071274

DESIGNED: SAJ	MODELED: SAJ	CHECKED: BMW
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DATE:


02/03/23

DRAWING TITLE:
MECHANICAL
NEW WORK GROUND
FLOOR PLAN - AREA D


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M105

Project Number: 071274
2/3/2023 7:59:25 AM
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1 MECHANICAL DEMOLITION TRASH ROOM ENLARGED PLAN
SCALE: 1/4" = 1'-0"

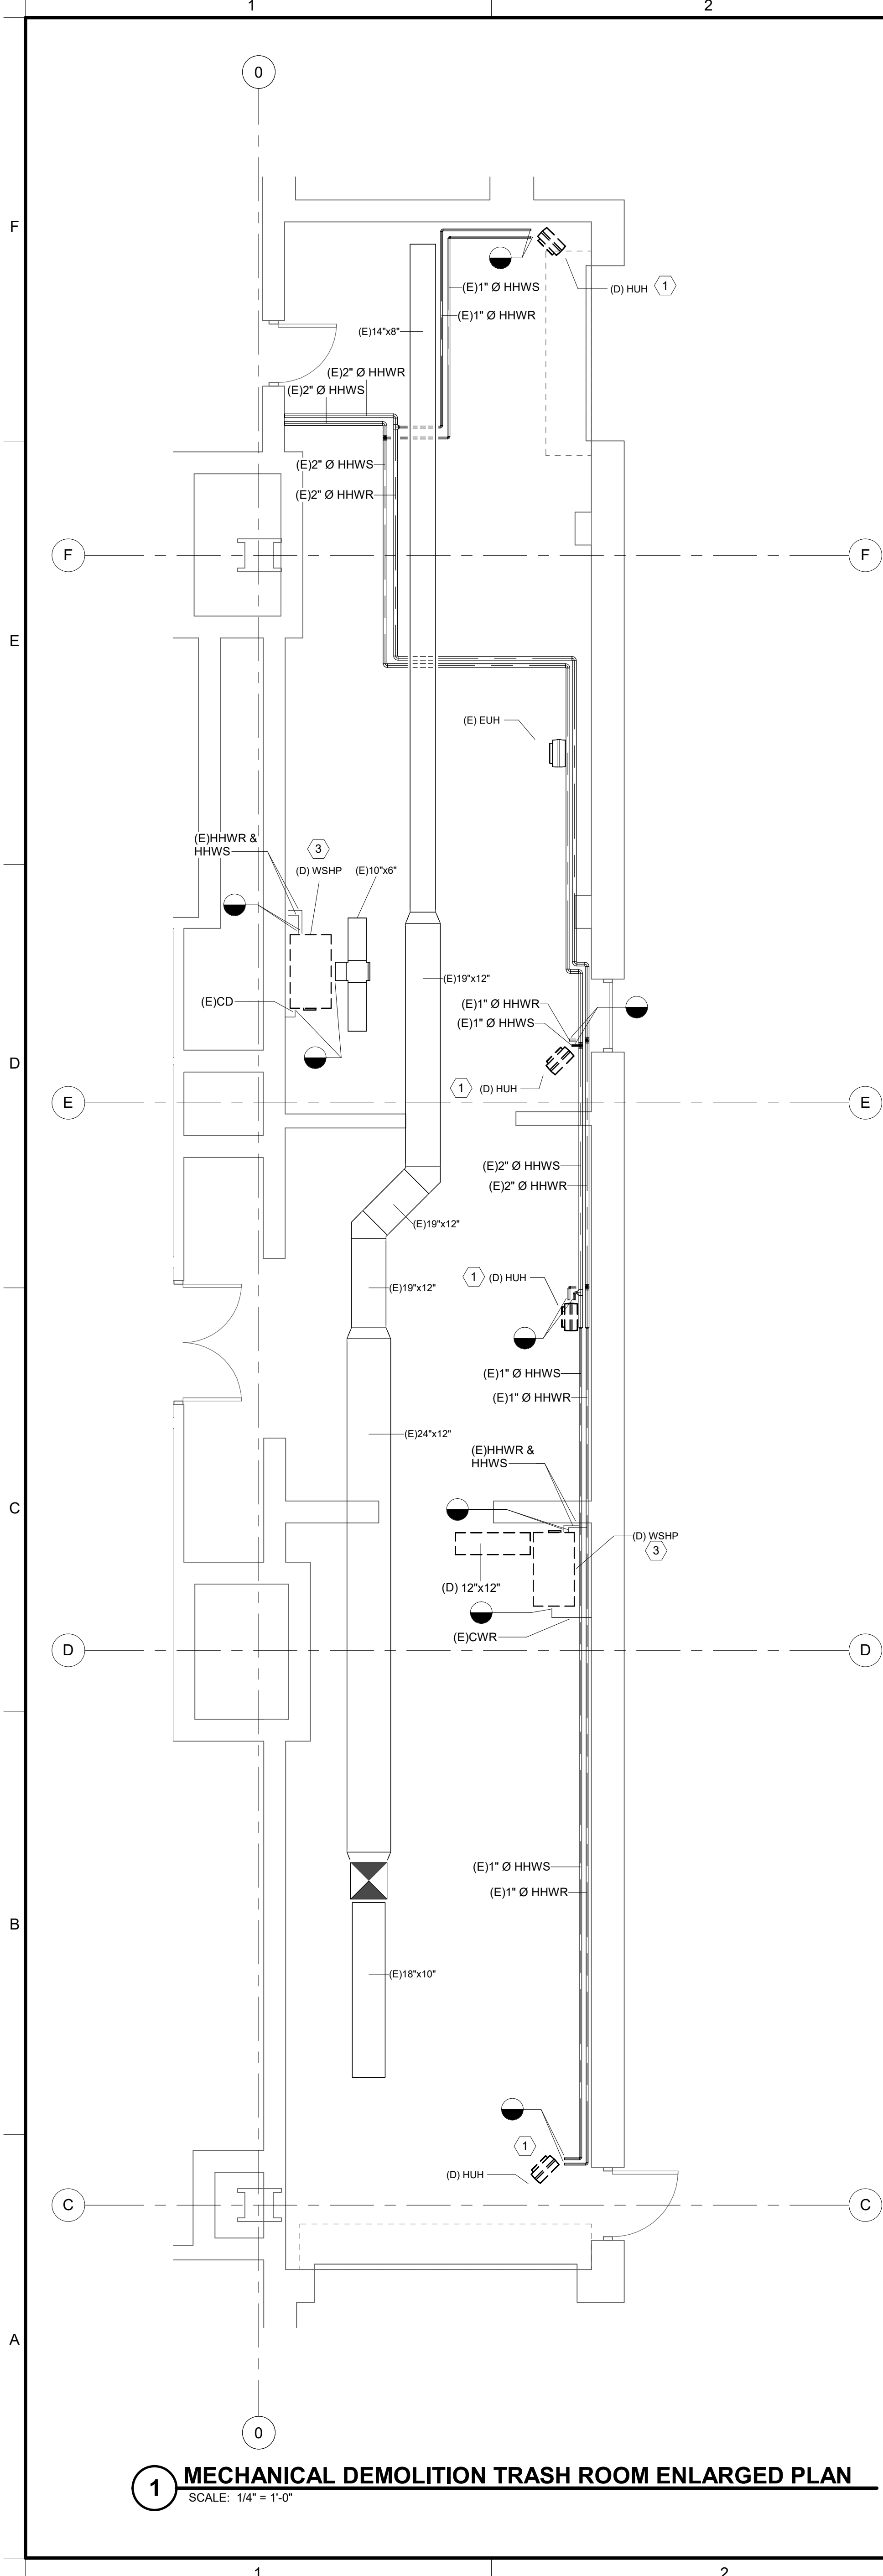

2 MECHANICAL NEW WORK TRASH ROOM ENLARGED PLAN
SCALE: 1/4" = 1'-0"

SHEET NOTES

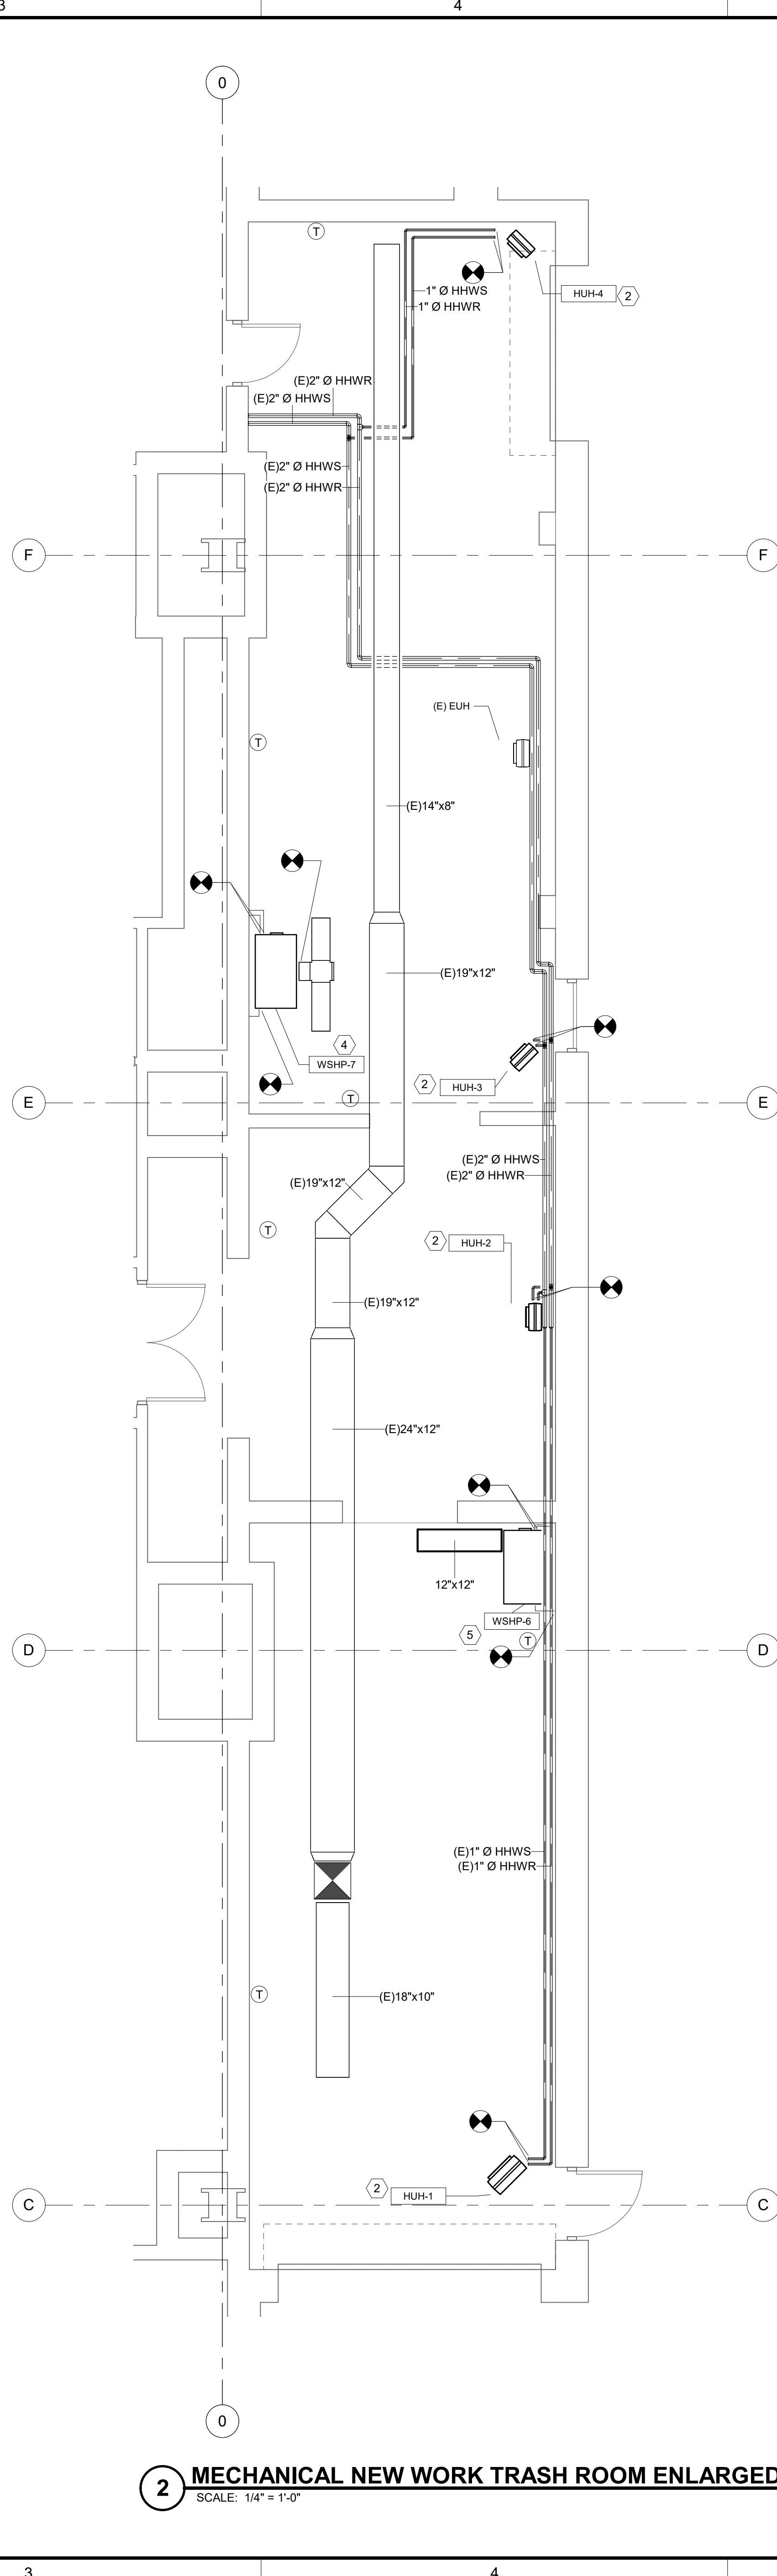- CLEAN ALL EXISTING DUCTWORK TO REMAIN. INSULATE ALL EXISTING DUCTWORK TO REMAIN, EXCEPT FOR SECTIONS WHERE EXISTING CONDUIT AND EXISTING SPRINKLERS PROHIBIT INSULATION INSTALLATION. INSULATION SHALL BE MINIMUM OF 1" CLEAR FROM EXISTING SPRINKLERS. REFER TO SPECIFICATIONS.

SHEET KEYNOTES

- REMOVE WALL MOUNTED HYDRONIC UNIT HEATER. CAP HEATING HOT WATER SUPPLY AND RETURN PIPING FOR LATER USE. REMOVE THERMOSTAT.
- INSTALL NEW WALL MOUNTED HYDRONIC UNIT HEATER. CONNECT TO EXISTING HEATING HOT WATER SUPPLY AND RETURN PIPING. INSTALL THERMOSTAT ON WALL.
- REMOVE EXISTING WATER SOURCE HEAT PUMP AND ASSOCIATED SUPPORTS AND ELECTRICAL CONENCTIONS. DISCONNECT SUPPLY AND RETURN HOT WATER PIPING, AND CONDENSATE DRAIN PIPING. CAP HEATING HOT WATER PIPING FOR REUSE.
- PROVIDE NEW WATER SOURCE HEAT PUMP. CONNECT TO EXISTING HEATING HOT WATER SUPPLY AND RETURN PIPING. CONNECT TO EXISTING CONDENSATE PIPING. CONNECT TO EXISTING SUPPLY AIR DUCTWORK. PROVIDE FLEXIBLE DUCTWORK CONNECTIONS. PROVIDE NEW THERMOSTAT WITH CLEAR LEXAN LOCKABLE COVER.
- PROVIDE NEW WATER SOURCE HEAT PUMP. CONNECT TO EXISTING HEATING HOT WATER SUPPLY AND RETURN PIPING. CONNECT TO EXISTING CONDENSATE PIPING. CONNECT TO NEW SUPPLY AIR DUCTWORK. PROVIDE FLEXIBLE DUCTWORK CONNECTIONS. PROVIDE NEW THERMOSTAT WITH CLEAR LEXAN LOCKABLE COVER.



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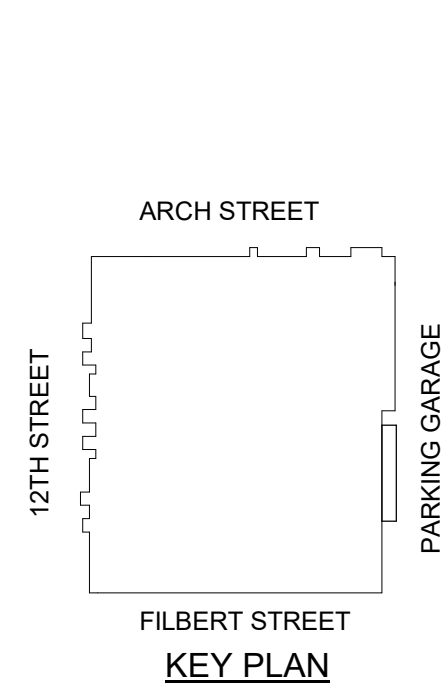
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NO.	DATE	DESCRIPTION
GENERAL PACKAGE		
PROJECT NUMBER: 071274		
DESIGNED:	MODELED:	CHECKED:
SAJ	SAJ	BMW
DATE: 02/03/23		
DRAWING TITLE: MECHANICAL		
ENLARGED SCALE DRAWINGS - PLANS		
DRAWING NO.:		

M401



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Project Number: 071274
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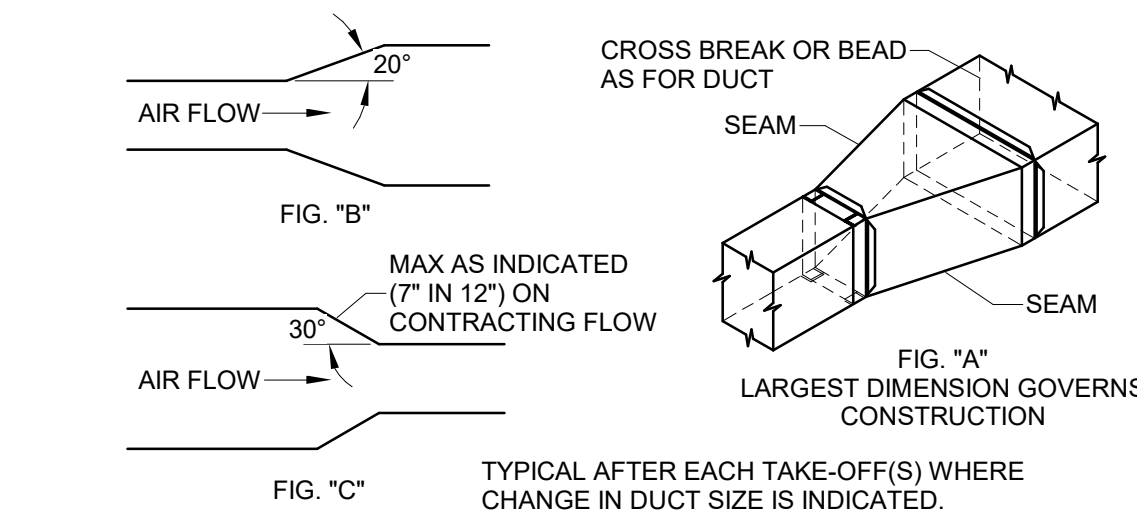
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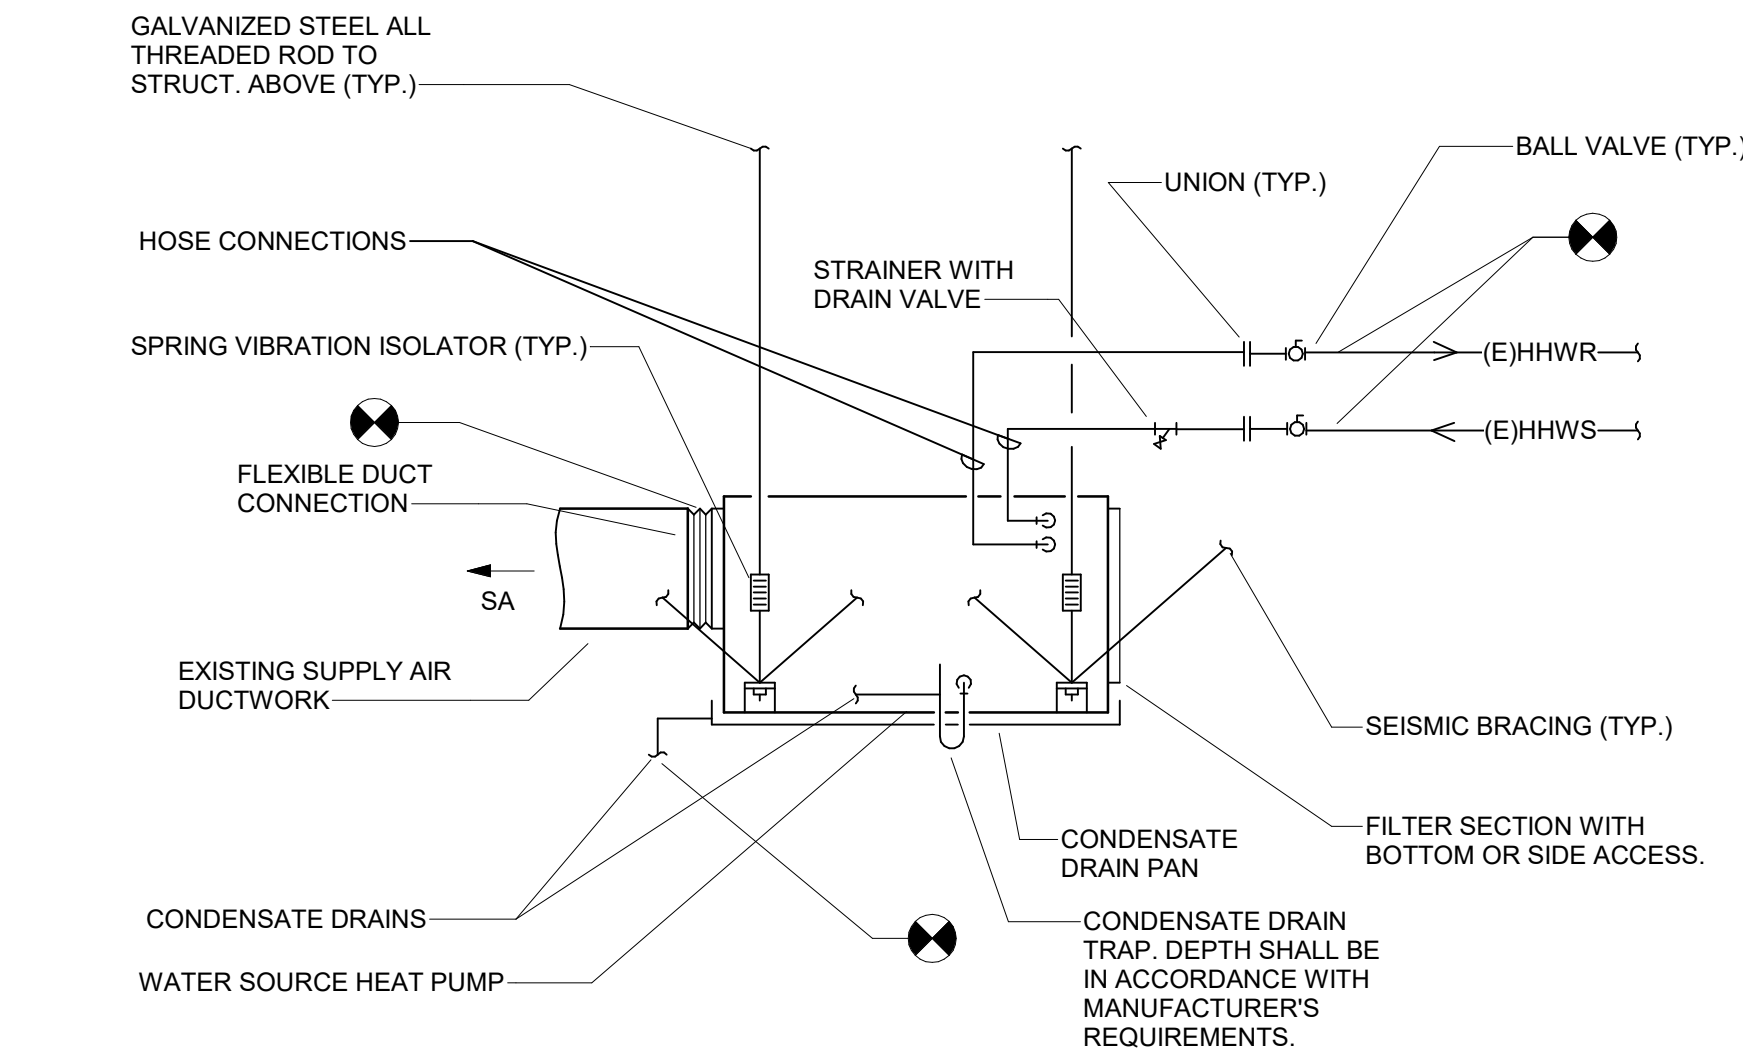
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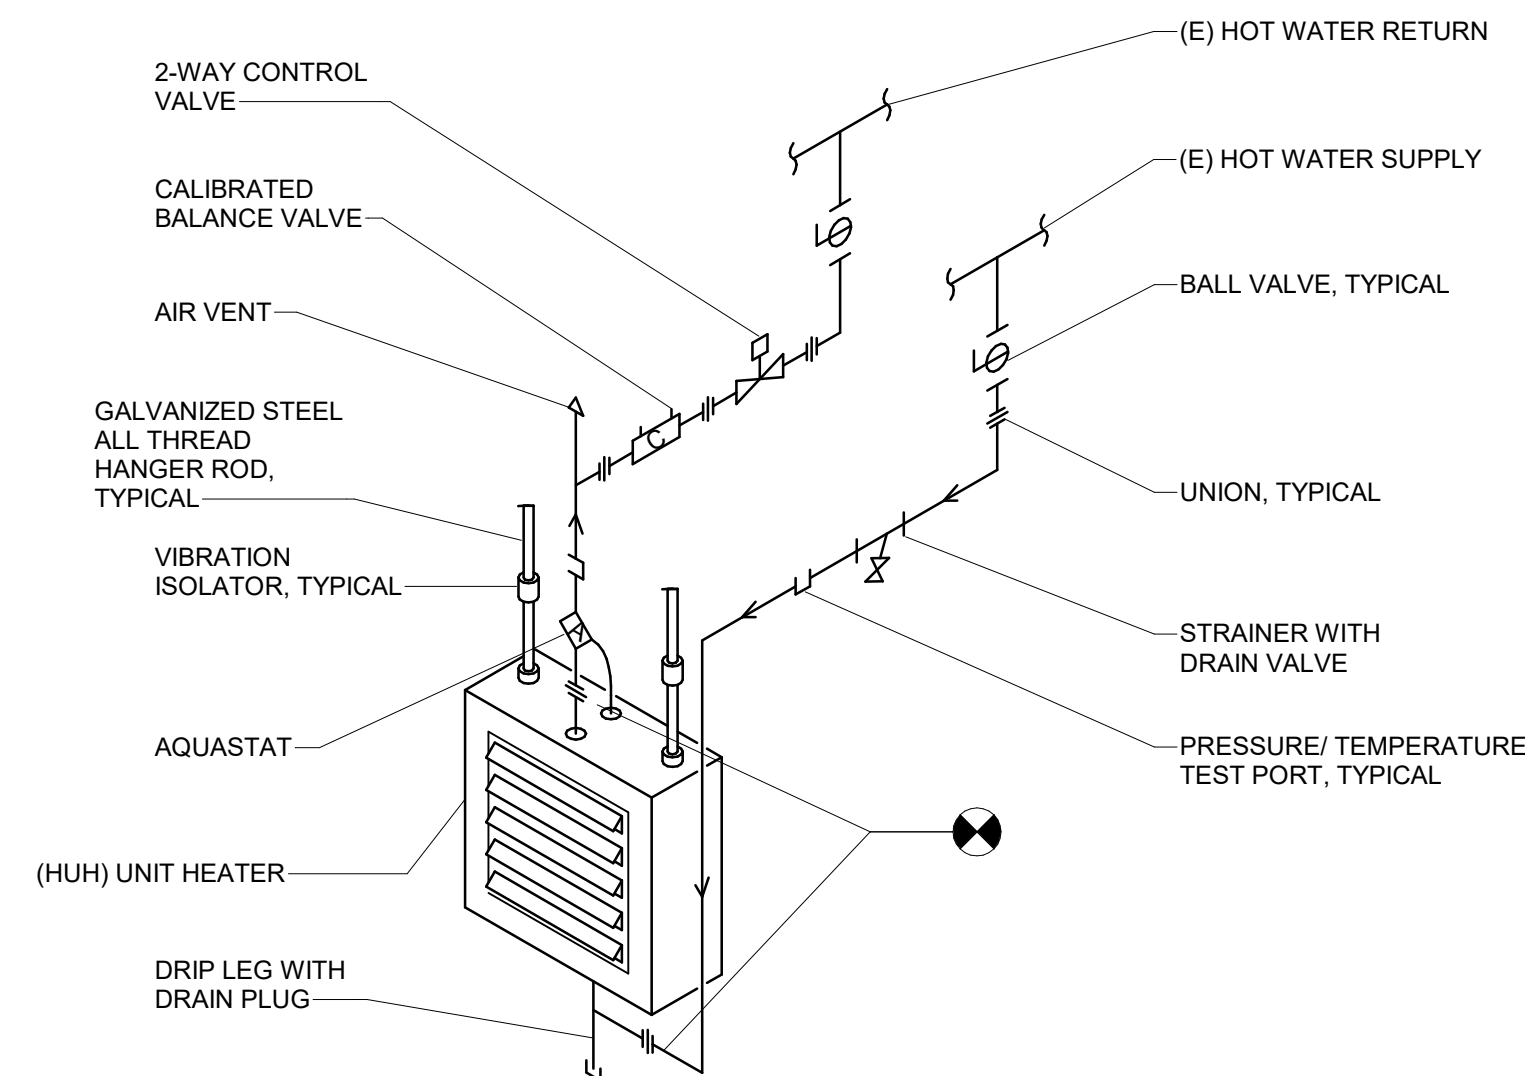
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1 DUCT TRANSITION DETAIL
SCALE: NTS



2 WATER SOURCE HEAT PUMP - CEILING MOUNT
SCALE: NTS



3 HORIZONTAL HYDRONIC UNIT HEATER
SCALE: NTS

Project Number: 071274
2/3/2023 7:59:26 AM

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A

WATER SOURCE HEAT PUMP UNIT SCHEDULE																											
MARK	SUPPLY FAN	COIL FLUID TYPE	AIRFLOW RATE (CFM)	CONDENSER WATER COOLING COIL								HYDRONIC HEATING COIL					ELECTRICAL DATA				ENERGY EFFICIENCY		OPERATING WEIGHT (LBS)	BASIS OF DESIGN		REMARKS	
	ESP (IN WG)			TOTAL CAPACITY (MBH)	SENS. (MBH)	EDB (°F)	EWB (°F)	LDB (°F)	LWB (°F)	EWI (°F)	LWI (°F)	TOTAL CAPACITY (MBH)	EDB (°F)	LDB (°F)	EWI (°F)	LWI (°F)	V	Ø	FLA	MCA	MOCP	EER		COP	MANUFACTURER		MODEL
WSHP-2	0.25	WATER	2055	59.3	43	80	67	61	56	85	97	80.1	68	104	70	60	460	3	9.9	11.9	15.0	13.3	4.6	298	CLIMATEMASTER	TR-	1
WSHP-3	0.25	WATER	2055	59.3	43	80	67	61	56	85	97	80.1	68	104	70	60	460	3	9.9	11.9	15.0	13.3	4.6	298	CLIMATEMASTER	TR-	1
WSHP-4	0.25	WATER	2055	59.3	43	80	67	61	56	85	97	80.1	68	104	70	60	460	3	9.9	11.9	15.0	13.3	4.6	298	CLIMATEMASTER	TR-	1
WSHP-5	0.25	WATER	2055	59.3	43	80	67	61	56	85	97	80.1	68	104	70	60	460	3	9.9	11.9	15.0	13.3	4.6	298	CLIMATEMASTER	TR-	1
WSHP-6	0.50	WATER	1155	32.5	23	80	67	57	52	85	97	0.0	0	0	0	0	460	3	7.3	8.8	15.0	12.3	4.3	213	CLIMATEMASTER	TR-	1.2
WSHP-7	0.50	WATER	1705	54.9	36	80	67	56	51	85	97	0.0	0	0	0	0	460	3	9.9	11.9	15.0	13.3	4.6	298	CLIMATEMASTER	TR-	1.2

1. PROVIDE WITH REMOTE THERMOSTAT AND BACNET CAPABLE CONTROLLER
2. COOLING ONLY

HYDRONIC UNIT HEATER SCHEDULE											
MARK	AIRFLOW (CFM)	HEATING (BTUH)	FLOW (GPM)	WPD (FT/H2O)	V	PH	HP	SHIPPING WEIGHT (LB)	MANUFACTURER	MODEL	REMARKS
HUH-1	1100	54900	3.5	0.24	230	1	0.083	47	TRANE	UHSB0843xAAXxxxxxxx	1,2,3,4,5,6,7,8,9
HUH-2	630	31300	3.5	0.12	230	1	0.05	41	TRANE	UHSB0483xAAXxxxxxxx	1,2,3,4,5,6,7,8,9
HUH-3	630	31300	3.5	0.12	230	1	0.05	41	TRANE	UHSB0483xAAXxxxxxxx	1,2,3,4,5,6,7,8,9
HUH-4	630	31300	3.5	0.12	230	1	0.05	41	TRANE	UHSB0483xAAXxxxxxxx	1,2,3,4,5,6,7,8,9

1. PROVIDE WITH REMOTE THERMOSTAT.
2. PROVIDE WITH OSHA FAN GUARD.
3. PROVIDE WITH SINGLE POINT ELECTRICAL POWER CONNECTION AND MOTOR OVERLOAD PROTECTION.
4. PROVIDE WITH FACTORY-INSTALLED CONTROL POWER TRANSFORMER AND DISCONNECT SWITCH.
5. PROVIDE WITH ADJUSTABLE HORIZONTAL AIR DISCHARGE LOUVERS.
6. PROVIDE WITH MOUNTING BRACKET.
7. MAINTAIN MANUFACTURER'S REQUIRED SERVICE AND AIRFLOW CLEARANCES.
8. UNIT HEATER SHALL BE U.L. LISTED.
9. INSTALL IN ACCORDANCE WITH THE MANUFACTURER'S REQUIREMENTS.



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51 N TWELFTH STREET, PHILADELPHIA PA, 19107

READING TERMINAL MARKET CAPITAL IMPROVEMENTS

NO.	DATE	DESCRIPTION	
REVISIONS			
GENERAL PACKAGE			
PROJECT NUMBER: 071274			
DESIGNED: SAJ	MODELED: SAJ	CHECKED: MJM	
DATE: 02/03/23			
DRAWING TITLE: MECHANICAL SCHEDULES			
DRAWING NO.: M601			

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Project Number: 071274
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ABBREVIATIONS

@	AT	MV	MEDICAL VACUUM
A	AIR	N	NITROGEN
AAV	AUTOMATIC AIR VENT	N/A	NOT APPLICABLE
ABV	ABOVE	NC	NORMALLY CLOSED, NOISE CRITERIA
AD	AREA DRAIN, ACCESS DOOR, AIR DRYER	NFPA	NATIONAL FIRE PROTECTION AGENCY
ADU	AMERICANS WITH DISABILITIES ACT	NFHW	NON-FREEZE WALL HYDRANT
ADJ	ADJUST, ADJUSTABLE	NG	NATURAL GAS
AF	ANTI-FREEZE	NGR	NATURAL GAS REGULATOR
ALL	ABOVE FINISHED FLOOR	NC	NOT IN CONTRACT
ALUM	ALUMINUM	NO	NORMALLY OPENED
AP	ACCESS PANEL	No	NUMBER
APPROX	APPROXIMATELY	NPW	NON-POTABLE WATER
ARCH	ARCHITECTURAL	NTS	NOT TO SCALE
AS	AIR SEPARATOR	IV	INDUSTRIAL VENT
AST	ABOVEGROUND STORAGE TANK	O/2, O2	OXYGEN
ATF	AUTO TRANSMISSION FLUID	OC	ON CENTER
AVG	ATMOSPHERIC VENT	OFD	OVERFLOW DRAIN
BA	BREATHABLE AIR	OI	OIL INTERCEPTOR
BAS	BUILDING AUTOMATION SYSTEM	OS&Y	OUTSIDE STEM AND YOKE VALVE
BFF	BELOW FINISHED FLOOR	OSD	OPEN SITE DRAIN
BFP	BACKFLOW PREVENTER	OVI	OVERHEAD
BLDG	BUILDING	OWS	OIL WATER SEPARATOR
BLW	BELOW	%	PERCENT
BMS	BUILDING MANAGEMENT SYSTEM	P	PUMP
BOD	BASIS OF DESIGN	PC	PUMPED CONDENSATE
BOT	BOTTOM	PD	PRESSURE DROP
BTU	BRITISH THERMAL UNIT	PH	PHASE
BTUH	BRITISH THERMAL UNITS PER HOUR	PW	PUMPED INDUSTRIAL WASTE
C	COMMON	PLBG	PLUMBING
CA	COMPRESSED AIR	PNEU	PNEUMATIC
CD	CONDENSATE DRAIN	POS	POSITION
CFH	CUBIC FEET PER HOUR	PRV	PRESSURE REDUCING VALVE
CI	CAST IRON	PRSS	PRESSURE
CL	CENTER LINE	PROPLER	PROPELLER
CLDIP	CEMENT-LINED DUCTILE IRON S PIPE	PSI	POUNDS PER SQUARE INCH
CLNG	CEILING	PSIG	POUNDS PER SQUARE INCH GAUGE
CNG	COMPRESSED NATURAL GAS	PVC	POLYVINYL CHLORIDE
CO	CLEANOUT, CARBON MONOXIDE	R	RELOCATED POSITION
CO2	CARBON DIOXIDE	RI	RISE
COL	COLUMN	RD	ROOF DRAIN
CONC	CONCRETE	REQD	REQUIRED
CONN	CONNECTION	RLA	RATED LOAD AMPS
CONT	CONTINUATION	ROM	ROOM
CONTD	CONTINUED	RPZ	REDUCED PRESSURE BFP
CPVC	CHLORINATED POLYVINYL CHLORIDE	RV	RECLAIMED WATER
CV	CLEANING VACUUM CHECK VALVE	RW	RAIN WATER CONDUCTOR
QW	COLD WATER	RWC	RAIN WATER CONDUCTOR
CA	COMMISSIONING	S	SWITCH
C&A	COMMISSIONING AUTHORITY	S/S	START/STOP
(D)	DEMOLISH, REMOVE	SAN	SANITARY
D	DRAIN, DEPTH	SCW	SOFTEN DOMESTIC COLD WATER
DB	DECIBELS	SD	STORM DRAIN
DCW	DOMESTIC COLD WATER	SF	SUPPLY FAN, SQUARE FEET
DOC	DIRECT DIGITAL CONTROL	SHR	SHOWER
DEG.	DEGREES	SHT	SHEET
DEH	DEHUMIDIFIER	SHW	SOFTEN DOMESTIC HOT WATER
DEPT	DEPARTMENT	SK	SINK
DESG	DESIGNATION	SNW	SOFTEN DOMESTIC NON-POTABLE WATER
DPU	DRAINAGE FIXTURE UNITS	SP	STATIC PRESSURE
DHW	DOMESTIC HOT WATER	SPEC	SPECIFICATION
DHWR	DOMESTIC HOT WATER RETURN	SPR	SPRINKLER
DI	DIAMETER	SQ	SQUARE
DIA. Ø	DIFFERENTIAL DIFFERENCE	SQ FT	SQUARE FOOT, SQUARE FEET
DISC	DISCONNECT	SS	STAINLESS STEEL
DN	DOWN	SBK	SERVICE SINK
DSB	DOWNSPOUT BOOT	ST	STORM WATER
DN	DOWNSPROUT NOZZLE	STD	STANDARD
DWG	DRAWING	STL	STEEL
DWH	DOMESTIC WATER HEATER	STO	STORM WATER OVERFLOW
(E)	EXISTING TO REMAIN	TD	TRENCH DRAIN
(ER)	EXISTING RELOCATED	TEMP	TEMPERATURE, TEMPORARY
EA	EACH	TMV	THERMOSTATIC MIXING VALVE
EJ	EFFICIENCY	TP	TRAP PRIMER
EL	EXPANSION JOINT	TW	DOMESTIC TEMPERED WATER
ELEC	ELECTRIC, ELECTRICAL	TYP	TYPICAL
ELEV	ELEVATOR	UL	UNDERWRITERS LABORATORIES
EM	EMERGENCY FIXTURE	UCN	UNLESS OTHERWISE NOTED
EQ	EQUAL	UR	URINAL
ET	EXPANSION TANK	UST	UNDERGROUND STORAGE TANK
ETC	ELECTRIC WATER COOLER	V	VOLTS, VENT
EXT	EXTERIOR	VAC	VACUUM
(F)	FUTURE	VCO	VERTICAL CLEAN OUT
FCO	FLOOR CLEANOUT	VEL	VELOCITY
FD	FLOOR DRAIN, FIRE DAMPER	VERT	VERTICAL
FDC	FIRE DEPARTMENT CONNECTION	VFD	VARIABLE FREQUENCY DRIVE
FDR	FLOOR DRAIN	VIB	VIBRATION
FF	FINISHED FLOOR	VSD	VARIABLE SPEED DRIVE
FG	FUEL GAS	VTR	VENT THROUGH ROOF
FLA	FULL LOAD AMPS	W	WIDTH, WIDE
FLEX	FLEXIBLE	W/O	WITHOUT
FLR	FLOOR	WA	WASTE ANTI-FREEZE
FM	FLOW METER	WAGD	WASTE ANESTHETIC GAS DISPOSAL
FO	FUEL OIL	WC	WATER CLOSET
FFM	FEET PER MINUTE	WCO	WALL CLEANOUT
FFS	FEET PER SECOND	WD	WASTE DRAIN
FRP	FIBERGLASS REINFORCED PLASTIC	WU	WATER SUPPLY FIXTURE UNITS
FS	FLOW SWITCH	WG	WATER GAUGE
FT	FEET OF HEAD	WH	WATER HEATER, WALL HYDRANT
FT-H	FOOT, FEET	WHA	WATER HAMMER ARRESTOR
FW	FILTERED WATER	WMS	WIRE MESH SCREEN
FZ	FRIEZE, FREEZESTAT	WO	WASTE OIL
°F	DEGREES FAHRENHEIT	WPD	WATER PRESSURE DROP
G	GAS	WS	WATER SOFTENER
GA	Gauge	WSP	WATER SOURCE HEAT PUMP
GAL	GALLON, GALLONS	WT	WEIGHT
GALV	GALVANIZED	WW	WELL WATER
GCO	GRADE CLEANOUT	ZN	ZONE
GEN	GENERATOR		
GI	GREASE INTERCEPTOR		
GL	GEAR LUBE		
GO	GEAR OIL		
GPH	GALLONS PER HOUR		
GPM	GALLONS PER MINUTE		
GR	GREASE		
GW	GREASE WASTE		
H	HEIGHT		
H-20	WATER		
HB	HOSE BIB		
HCRIZ	HORIZONTAL		
HP	HORSEPOWER		
HTC	HEAT TRACE CONTROLLER		
HTG	HEATING		
HTP	HEAT TRACE PANEL		
HUM	HUMIDIFIER		
HWR	HOT WATER RETURN		
HWS	HOT WATER SUPPLY		
HX	HEAT EXCHANGER		
HZ	HERTZ (CYCLES PER SECOND)		
ID	INSIDE DIAMETER		
IN-WG	INCHES OF WATER GAUGE		
IN."	INCH, INCHES		
INFO	INFORMATION		
INT	INTERIOR		
INV EL	INVERT ELEVATION		
ISOL	ISOLATION		
IW	INDUSTRIAL WASTE, INDIRECT WASTE		
KW	KILOWATTS		
L	LENGTH, LONG		
LAV	LAVATORY		
LBS	POUNDS		
LDR	LEADER		
LEC	LIGHTED END CONNECTION		
LED	LEADERSHIP IN ENERGY &		
LG	LIGHT GEAR LUBE		
LP	LIQUID PROPANE		
LPCR	LOW PRESSURE CONDENSATE RETURN		
LRA	LOAD RATED AMPS		
LWT	LEAVING WATER TEMPERATURE		
M	METER		
MA	MEDICAL AIR		
MAV	MANUAL AIR VENT		
MAX	MAXIMUM		
MBH	THOUSAND BRITISH THERMAL UNITS PER HOUR		
MCA	MINIMUM CIRCUIT AMPACITY		
MCH	MECHANICAL		
MFR	MANUFACTURER		
MG	MEDICAL GAS		
MN	MINIMUM		
MO	MOTOR OIL		
MR	MOP RECEPTOR		
MTD	MOUNTED		
MTG	MOUNTING		
MUW	MAKE UP WATER		

PIPING & FITTINGS

SYMBOL	DESCRIPTION
---	DOMESTIC COLD WATER
----	DOMESTIC HOT WATER
-----	DOMESTIC HOT WATER RECIRC/RETURN
-----	VENT
○	PIPING TURNING UP
○	PIPING TURNING DOWN
+	TEE DOWN
+	PIPE BRANCH BOTTOM TAKEOFF
+	PIPE BRANCH TOP TAKEOFF
+	VALVE IN VERTICAL PIPE
+	CAP
→	FLOW DIRECTION
→	PIPE SLOPE WITH IN/FT OR %
○	PIPE RISER UP/DOWN
○	CONCENTRIC REDUCER/INCREASER
○	ECCENTRIC REDUCER/INCREASER (FOB)
○	UNION
○	PIPE CONTINUATION
○	FLEXIBLE PIPE CONNECTOR
○	HOSEBIB
○	WALL HYDRANT
○	NON-FREEZE WALL HYDRANT
○	WATER HAMMER ARRESTOR
○	AIR ADMITTANCE VALVE
○	AUTOMATIC AIR VENT (EXTEND TO DRAIN)
○	MANUAL AIR VENT
○	PRESSURE/TEMPERATURE TEST PORT
○	AQUASTAT
○	PRESSURE GAUGE WITH COCK
○	THERMOMETER
○	TEMPERATURE SENSOR
○	PRESSURE SENSOR
○	DIFFERENTIAL PRESSURE TRANSDUCER
○	FLOW SWITCH
○	FLOW METER
○	TAMPER SWITCH
○	PUMP
○	ROOF DRAIN
○	ROOF DRAIN WITH OVERFLOW
○	FLOOR DRAIN
○	FLOOR CLEANOUT
○	GRADE CLEANOUT
○	CLEANOUT
○	WALL CLEANOUT
○	WATER METER
○	GAS METER
○	ACCESS PANEL

VALVES

SYMBOL	THREE LINE PLAN	THREE LINE ELEVATION	DESCRIPTION
○	○	○	GEN. SHUTOFF VALVE (BALL, GATE, BUTTERFLY)
○	○	○	GATE VALVE
○	○	○	GLOBE VALVE
○	○	○	OUTSIDE STEM & YOKE VALVE
○	○	○	BALL VALVE
○	○	○	BUTTERFLY VALVE
○	○	○	CHECK VALVE
○	○	○	GAS COCK
○	○	○	PRESSURE REDUCING VALVE
○	○	○	CALIBRATED BALANCING VALVE
○	○	○	CONTROL VALVE, TWO-WAY
○	○	○	CONTROL VALVE, THREE-WAY
○	○	○	THREE-WAY MANUAL VALVE
○	○	○	SOLENOID VALVE
○	○	○	ANGLE VALVE
○	○	○	RELIEF/SAFETY VALVE
○	○	○	STRAINER
○	○	○	STRAINER WITH DRAIN VALVE AND CAP

LINES & REFERENCE SYMBOLS

SYMBOL	DESCRIPTION	SYMBOL	DESCRIPTION
---	NEW WORK LINEWEIGHT	○	NATURAL GAS RISER
----	DEMOLITION WORK LINEWEIGHT	○	RAIN WATER CONDUIT RISER
----	EXISTING WORK LINEWEIGHT	○	SANITARY RISER
----	FUTURE WORK LINEWEIGHT	○	VENT RISER
○	POINT OF CONNECTION	○	NORTH ARROW
○	TERMINATION POINT OF DEMOLITION		
○	POINT OF FUTURE CONNECTION		
○	SHEET NOTE REFERENCE		
○	DRAWING REVISION NUMBER		
○	EQUIPMENT DESIGNATION		
○	DOMESTIC WATER RISER		
○	CONDENSATE DRAIN RISER		

GENERAL NOTES

- PLUMBING SYMBOLS, ABBREVIATIONS, AND GENERAL NOTES INDICATED ON THIS DRAWING ARE TYPICAL. PLUMBING DRAWINGS MAY NOT INDICATE ALL SYMBOLS AND ABBREVIATIONS SHOWN ON THIS DRAWING.
- THE DRAWINGS ARE GENERALLY DIAGRAMMATIC AND INDICATIVE OF THE WORK TO BE PERFORMED. THE DRAWINGS ARE NOT INTENDED TO SHOW EXACT LOCATIONS OR TO SHOW EVERY PIPE, FITTING, VALVE OR APPURTENANCE REQUIRED FOR A COMPLETE INSTALLATION. DO NOT SCALE DIMENSIONS FROM THESE DRAWINGS.
- INSTALL EQUIPMENT IN A SERVICEABLE MANNER WITHOUT DISRUPTION TO ADJACENT SERVICES OR DAMAGING INSULATION. THIS INCLUDES, BUT IS NOT LIMITED TO, PROVIDE VALVE OPERATOR EXTENSIONS TO EXTEND THRU THE INSULATION AND HANDLES TO SWING TOWARD THE OPERATOR FOR ISOLATION.
- PROVIDE ALL NEW AND REUSED WALL PENETRATIONS WITH A SLEEVE/CONDUIT FOR SERVICES PENETRATING IT. THIS INCLUDES, BUT IS NOT LIMITED TO, PIPING, POWER, AND CONTROL WIRING.
- THE SCOPE OF WORK SHALL INCLUDE PROVIDING ALL WORK INDICATED AND COORDINATION WITH ALL TRADES. SCOPE OF WORK IS INDICATED ON THE CONTRACT DOCUMENTS INCLUDING THE DRAWINGS AND THE SPECIFICATIONS, WHICH ARE COMPLEMENTARY. WORK INDICATED IN ANY CONTRACT DOCUMENT SHALL BE CONSIDERED PART OF THE SCOPE OF WORK. IN GENERAL, WORK REQUIREMENTS ARE NOT INDICATED IN BOTH DOCUMENTS, WHERE DOCUMENTS CONFLICT WITHIN THEMSELVES OR WITH CODES AND REGULATIONS, PROVIDE THE HIGHER QUANTITY AND QUALITY AND FOLLOW THE STRICTER REQUIREMENTS.
 - CHECK ARCHITECTURAL, ELECTRICAL, & MECHANICAL DRAWINGS FOR WORK SHOWN TO BE WITHIN PLUMBING SCOPE.
 - COORDINATE PLUMBING WORK WITH OTHER DISCIPLINES. SEE SPECIFICATIONS FOR INFORMATION REGARDING COORDINATION DRAWINGS.
 - PROVIDE DEDUCTIONS FOR ANY OWNER AGREED REDUCTIONS IN PIPING RUNS.
 - COORDINATE ROUGH-IN INFORMATION WITH FIXTURES AND EQUIPMENT SUPPLIERS.
 - COORDINATE PLUMBING FIXTURE LOCATIONS WITH ARCHITECTURAL PLANS. COORDINATE ALL BELOW GRADE PLUMBING PIPING WITH FOUNDATION ELEVATIONS AND SITE UTILITY INVERTS. VERIFY EXISTING ELEVATIONS AND INVERTS PRIOR TO CONSTRUCTION.
- THE ENTIRE PLUMBING SYSTEM SHALL BE IN CONFORMANCE WITH ALL FEDERAL, STATE AND LOCAL REGULATIONS.
 - CONFORM TO APPLICABLE BUILDING CODES AND THE OWNER'S INSURANCE AGENCY.
 - PROCURE ALL LICENSES, PERMITS, CERTIFICATIONS, AND AGENCY APPROVALS PRIOR TO COMMENCING FABRICATION OR INSTALLATION.
 - PROVIDE ALL REQUIRED DOCUMENTS, CALCULATIONS AND DRAWINGS.
- PLUMBING SYSTEMS SHALL NOT BE LOCATED IN ELEVATOR SHAFTS AND ELEVATOR PIT ROOMS EXCEPT FLOOR DRAINS, SUMP PUMPS AND SUMP PUMP DISCHARGE PIPING DEDICATED TO THE SHAFT AND LOCATED AT THE BASE OF THE SHAFT.
- PLUMBING SYSTEMS SHALL NOT BE LOCATED IN ELECTRICAL EQUIPMENT ROOMS, TRANSFORMER VAULT, ELECTRICAL CLOSETS, TELE DATA ROOMS OR SIMILAR AREAS CONTAINING ELECTRICAL EQUIPMENT.
 - DO NOT INSTALL PIPING OVER, AROUND, IN FRONT OF, BEHIND OR DIRECTLY BELOW ELECTRICAL EQUIPMENT, SWITCHES, TERMINALS OR SIMILAR ELECTRICAL EQUIPMENT.
 - MAINTAIN 42" IN FRONT OF 480 VAC EQUIPMENT AND 36" IN FRONT OF 240 VAC EQUIPMENT.
 - CONFORM TO NEC.
- NO PLUMBING SYSTEMS SHALL PENETRATE INTO OR PASS THROUGH STAIRWAYS UNLESS IT IS FOR SERVICING THE STAIRWAY.
- INSTALL PIPING IN A CONCEALED MANNER, STRAIGHT, PLUMB, AND FORM RIGHT ANGLES PARALLEL WITH BUILDING WALLS. LOCATE GROUPS OF PIPES PARALLEL TO EACH OTHER. PIPE WILL BE LOCATED TO PERMIT ACCESS FOR SERVICE VALVES.
- CONCRETE PADS AND PITS FOR PLUMBING EQUIPMENT SHALL BE AS INDICATED ON THE STRUCTURAL AND ARCHITECTURAL PLANS.
- COORDINATE PLUMBING SYSTEM SHUT DOWN REQUIREMENTS WITH OWNER. NOTIFY OWNER A MINIMUM OF 48 HOURS PRIOR TO SYSTEM SHUT DOWN.
- NOTIFY ARCHITECT/ENGINEER OF ANY DISCREPANCIES BETWEEN CONSTRUCTION DOCUMENTS AND EXISTING CONDITIONS PRIOR TO CONSTRUCTION.
- ONLY CAST IRON PIPING FOR SANITARY AND VENTING SHALL BE INSTALLED IN PLENUM SPACES. CONTRACTOR SHALL VERIFY / COORDINATE THE EXACT PLENUM SPACES WITH THE MECHANICAL PLANS AND CONTRACTOR PRIOR TO THE START OF CONSTRUCTION.
- PROVIDE PIPING PENETRATIONS WITH FIRE RATINGS EQUAL TO OR GREATER THAN, THE FIRE RATING OF THE WALL OR FLOOR PENETRATED.
 - COORDINATE PIPE PENETRATIONS WITH CONCRETE CONSTRUCTION.
 - PROVIDE CORE DRILLED PENETRATIONS AT ALL LOCATIONS WHERE CONCRETE OR MASONRY WALLS OR FLOORS HAVE BEEN CONSTRUCTED PRIOR TO PLUMBING PIPING INSTALLATION.
 - CORING SIZES AND LOCATIONS SHALL BE APPROVED BY THE ARCHITECT/ENGINEER.
 - EXTEND SLEEVES 2" ABOVE FLOOR SLAB IN ALL WET AREAS SUCH AS MECHANICAL ROOMS AND WASH AREA.
- PROVIDE FLUSH TYPE ACCESS DOORS OR PANELS FOR ALL VALVES OR APPARATUS LOCATED IN CHASES, WALLS, NON ACCESSIBLE CEILINGS OR FLOOR.
- PROVIDE CLEANOUTS FOR ALL HORIZONTAL STORM AND SANITARY PIPING AT EVERY CHANGE IN DIRECTION GREATER THAN 45-DEGREES AND AT THE BASE OF ALL STACKS.
- PROVIDE PIPE IDENTIFICATION LABELS WITH DIRECTIONAL FLOW ARROWS ON ALL HORIZONTAL RUNS EVERY 20 FT.
- PROVIDE TRAP PRIMERS WITH 1/2" PIPING FOR ALL FLOOR DRAINS WITHOUT SUFFICIENT WATER TO MAINTAIN TRAP SEAL OR A BARRIER TYPE TRAP SEAL PROTECTION DEVICE COMPLYING WITH ASSE 1072.
- SUPPORT ALL PIPING IN CONFORMANCE WITH SPECIFICATIONS AND THE PLUMBING CODE.
 - SEE PLUMBING CODE FOR SPACING REQUIREMENTS.
 - CONFORM TO THE BUILDING CODE AND MSS SP-127 FOR SEISMIC, WIND AND DYNAMIC FORCES.
- PROVIDE WATER HAMMER ARRESTORS ON SUPPLY LINES TO FLUSH VALVES, SOLENOID VALVES AND AUTOMATIC VALVES. IN CONFORMANCE WITH PDJ AND LOCAL ORDINANCES, INSTALL IN ACCESSIBLE LOCATIONS OR PROVIDE ACCESS PANEL FOR MAINTENANCE.
- PROVIDE SHUT-OFF VALVES, WITHIN 2 FT. OF MAINS, ON ALL BRANCH PIPING SERVING PLUMBING FIXTURES, EQUIPMENT OR CASEWORK, CONNECT SERVICE BRANCHES TO TOP OF MAINS.
- PROVIDE DRAIN VALVES AND HOSE CONNECTIONS AT ALL LOW POINTS IN SERVICE PIPING SYSTEM.
- SLOPE ALL PIPING IN CONFORMANCE WITH SPECIFICATIONS AND THE PLUMBING CODE.
- PROVIDE PIPING MATERIAL IN CONFORMANCE WITH THE SPECIFICATIONS AND THE PLUMBING CODE.
- DISINFECT DOMESTIC WATER SYSTEM IN CONFORMANCE WITH THE SPECIFICATIONS AND THE PLUMBING CODE.
- INSTALL PLUMBING FIXTURES AND EQUIPMENT IN CONFORMANCE WITH MANUFACTURER'S RECOMMENDATIONS AND THE PLUMBING CODE.
- PROVIDE PIPE SLEEVES THROUGH CONCRETE BEAMS WHERE REQUIRED, COORDINATE WITH THE ARCHITECTURAL AND STRUCTURAL DRAWINGS.
- PROVIDE HEAT TRACING FOR PIPING LOCATED IN UNHEATED AREAS. PROVIDE 1" INSULATION AND JACKET AROUND ALL PIPE WITH HEAT TRACING.
- PROVIDE RETENTION SHAPES ON ALL ABOVE GROUND CAST IRON NO-HUB FITTINGS AT CHANGE OF DIRECTION IN PIPES OF 6" AND LARGER AS REQUIRED BY CISPI 301.

GENERAL DEMOLITION NOTES

- UNLESS OTHERWISE NOTED, PIPING TO BE DEMOLISHED SHALL BE REMOVED BACK TO ACTIVE MAIN AND CAPPED AIRWATER TIGHT. CAP PIPING AS NOT TO CREATE DEAD LEGS.
- THE DRAWINGS ARE PRIMARILY INTENDED TO SHOW GENERAL PLUMBING DEMOLITION WORK AND SCOPE OF DEMOLITION. EXISTING WORK WHICH IS TO BE DEMOLISHED IS SHOWN DARK OR AS NOTED.
- COORDINATE ALL DEMOLITION REQUIREMENTS WITH THE OWNER. SECURE OPEN FLAME PERMITS FROM THE OWNER SO ALARM SYSTEMS AND FIRE WATCH PERSONNEL CAN BE EMPLOYED AS NECESSARY.
- ANY SHUTDOWNS OF EXISTING PLUMBING SYSTEMS SHALL BE COORDINATED WITH THE OWNER'S FACILITIES MANAGEMENT OFFICE AND SHALL BE BRIEF, OCCUR WHEN USAGE IS NONEXISTENT OR VERY LIGHT, OR METHODS SHALL BE EMPLOYED WHICH PERMIT SYSTEMS TO STAY IN OPERATION AVOIDING SHUTDOWNS ALTOGETHER. THE OWNER SHALL DETERMINE WHEN AND IF AN EXISTING SYSTEM MAY BE SHUTDOWN.
- ALL PLUMBING VALVES, OR EQUIPMENT INDICATED TO BE DEMOLISHED SHALL FIRST BE OFFERED TO THE OWNER. THE SCOPE OF DEMOLITION WORK, HOWEVER, SHALL INCLUDE THE DISPOSAL OF ALL DEMOLISHED EQUIPMENT. THE DISPOSAL SHALL BE OFF-SITE AND IN A SAFE & LEGAL MANNER.
- WHERE EXISTING CEILINGS REMAIN, CAREFULLY REMOVE AND REINSTALL EXISTING CEILING TILES, AS REQUIRED, IN ORDER TO GAIN ACCESS TO DEMOLITION WORK. REPLACE DAMAGED TEE BARS, TILE ETC. IF DAMAGED.
- REFER TO AND COORDINATE PLUMBING DEMOLITION WORK WITH ALL OTHER DISCIPLINES AS SHOWN ON ARCHITECTURAL, MECHANICAL, AND ELECTRICAL DEMOLITION DRAWINGS.
- WHERE EQUIPMENT AND PIPING ETC. IS TO REMAIN, AND IS SUPPORTED FROM ITEMS BEING REMOVED, EXTEND EXISTING HANGERS OR PROVIDE NEW HANGERS AND SUPPORTS AS REQUIRED TO RE-SUPPORT ITEMS FROM BUILDING STRUCTURE.
- CAP THE OPEN END OF EXISTING PIPING AND EQUIPMENT IMMEDIATELY AFTER OPENING PIPE/EQUIPMENT CONNECTIONS TO PREVENT DEBRIS FROM CONTAMINATING EXISTING-TO-REMAIN ITEMS AND TO PREVENT SEWER GASES FROM ENTERING INTO THE INTERIOR OF THE BUILDING.
- PROVIDE CUTTING OF ANY SHAFT, CEILING, FLOOR OR WALL AS REQUIRED FOR THE REMOVAL OF PIPING AND EQUIPMENT. ANY SHAFT, CEILING, FLOOR OR WALL OPENING CREATED TO IMPLEMENT PIPE DEMOLITION OR CREATED BY REMOVED PIPE OR FIXTURES SHALL BE REPAIRED BY THE CONTRACTOR. FILL OPENINGS WITH THE SAME MATERIAL AS THE WALL OR FLOOR. FINISH FLUSH TO THE EXISTING SURFACE.
- ALL WORK SHALL BE DONE IN ACCORDANCE WITH THE CURRENT PLUMBING AND BUILDING CODES.
- EXISTING HANGERS SHALL BE MODIFIED TO FACILITATE NEW ABOVE CEILING WORK.
- EQUIPMENT NOT TO BE REUSED SHALL BE REMOVED IN ITS ENTIRETY AS REQUIRED TO FACILITATE NEW WORK.



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WKK

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02/03/23

DRAWING TITLE:

PLUMBING

LEGEND, GENERAL


NOTES & ABBREVIATIONS

DRAWING NO.:

P001


Local File Autodesk Docs\\071274-RTM_Renovation_Project\\071274_ReadTerminalMarket MEP_R222.rvt

Project Number: 071274
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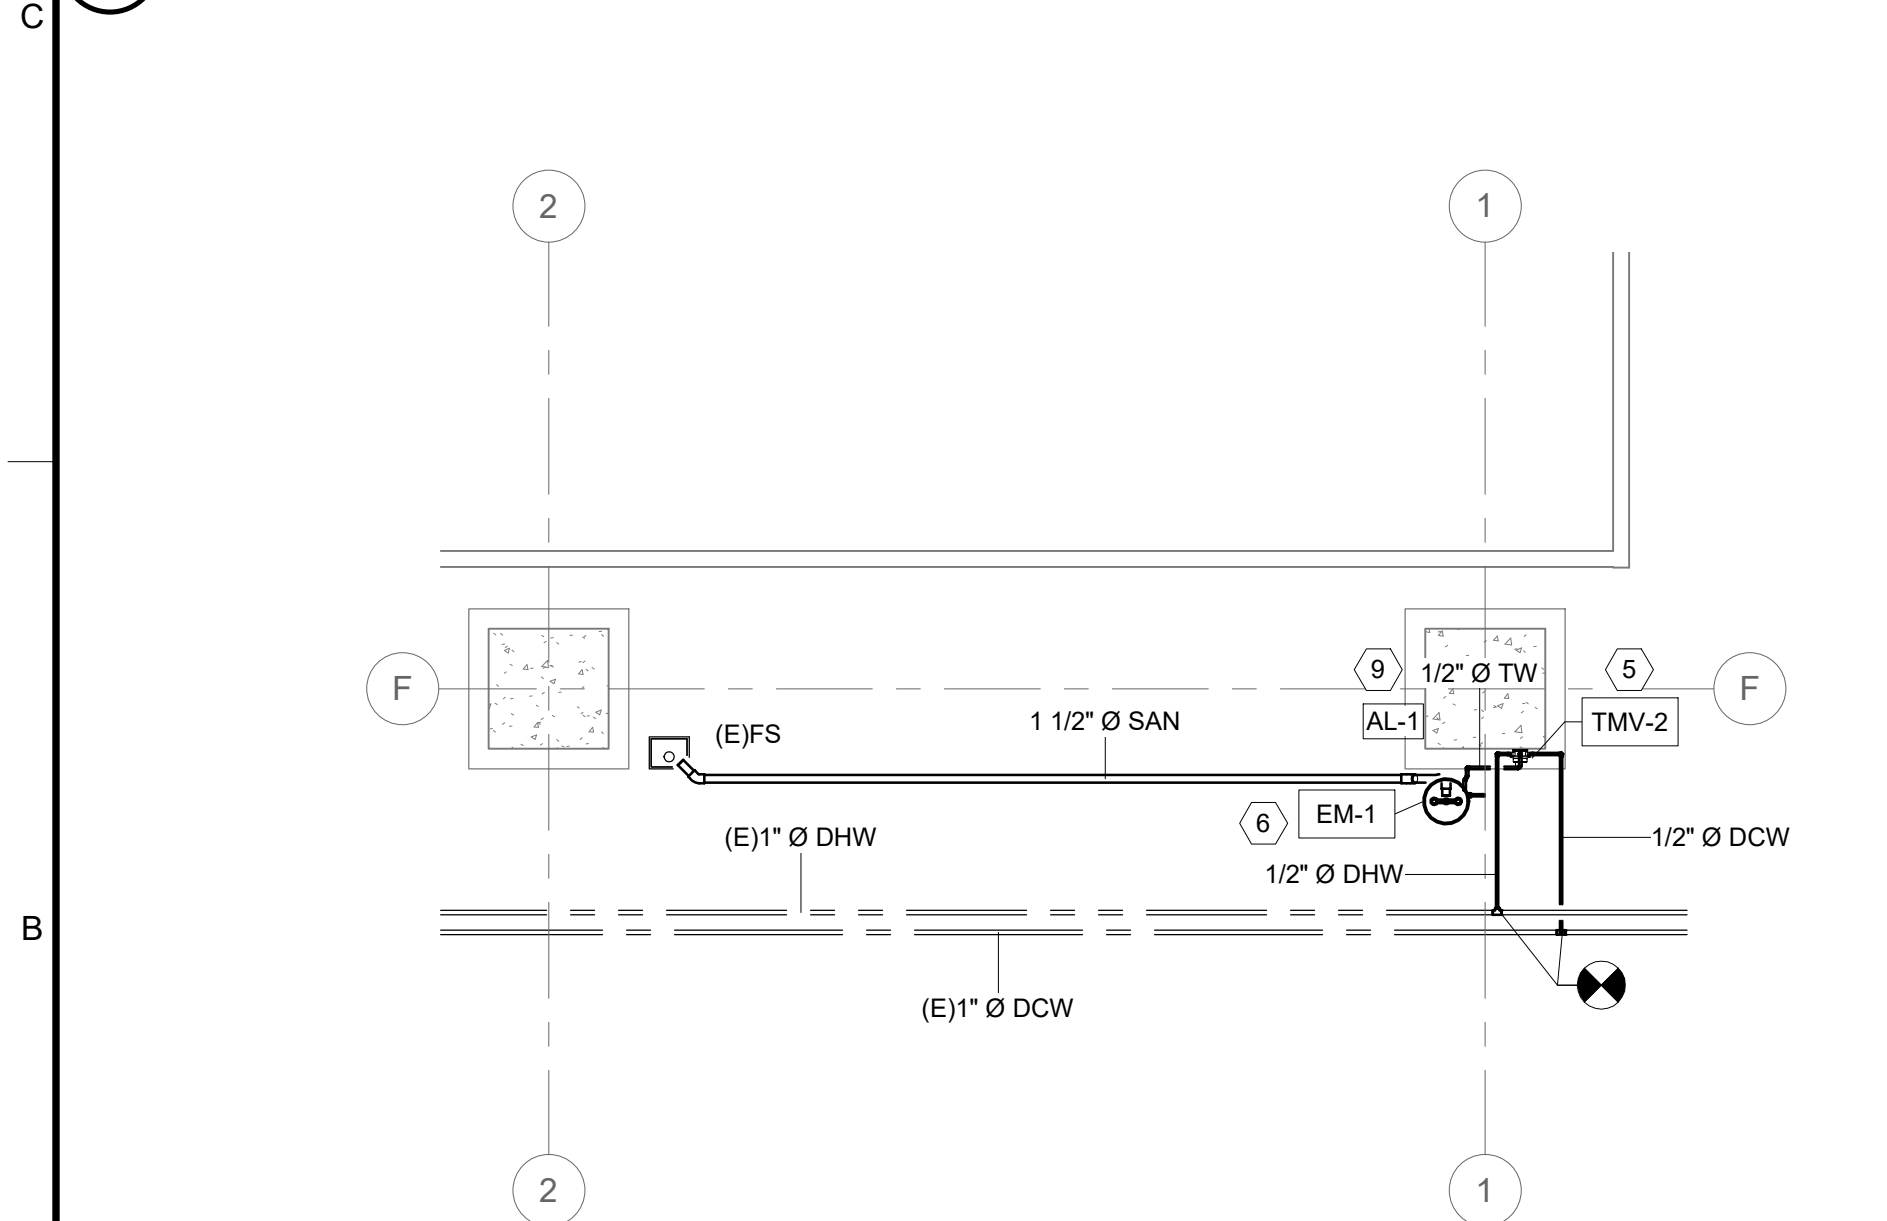
1 PLUMBING BASEMENT NEW WORK KEY PLAN

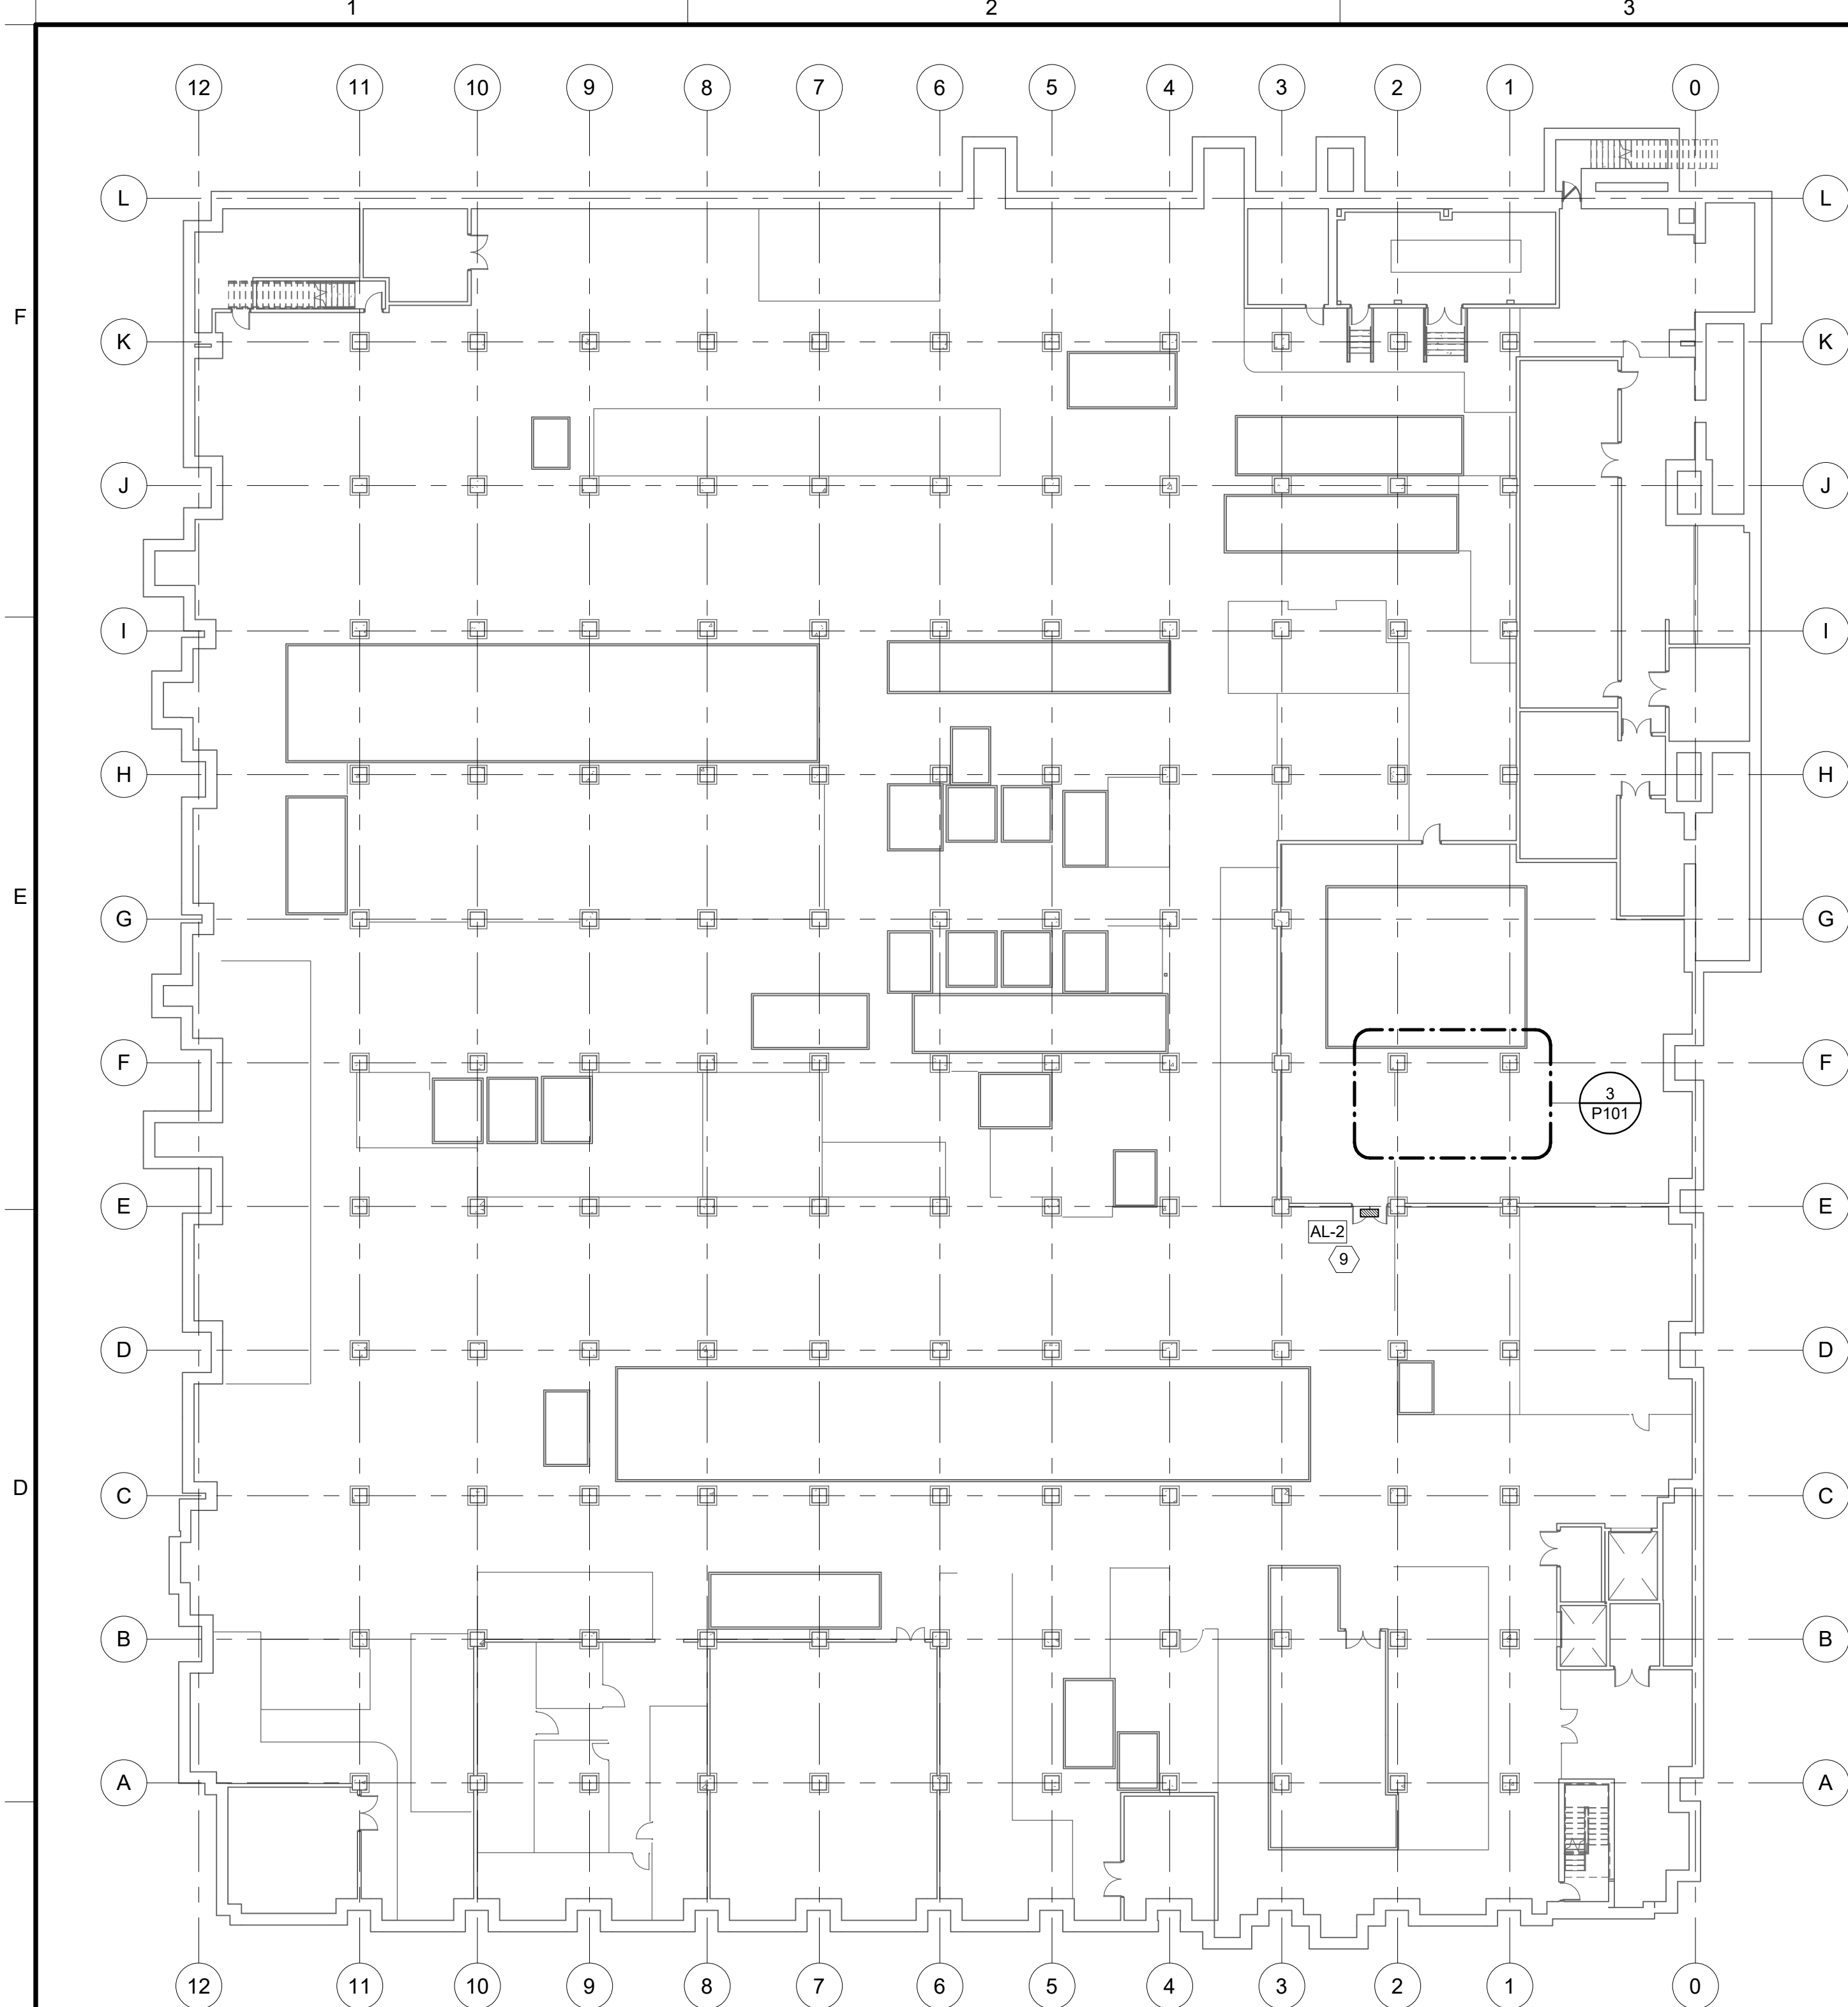SCALE: 3/64" = 1'-0"




2 PLUMBING GROUND FLOOR NEW WORK KEY PLAN

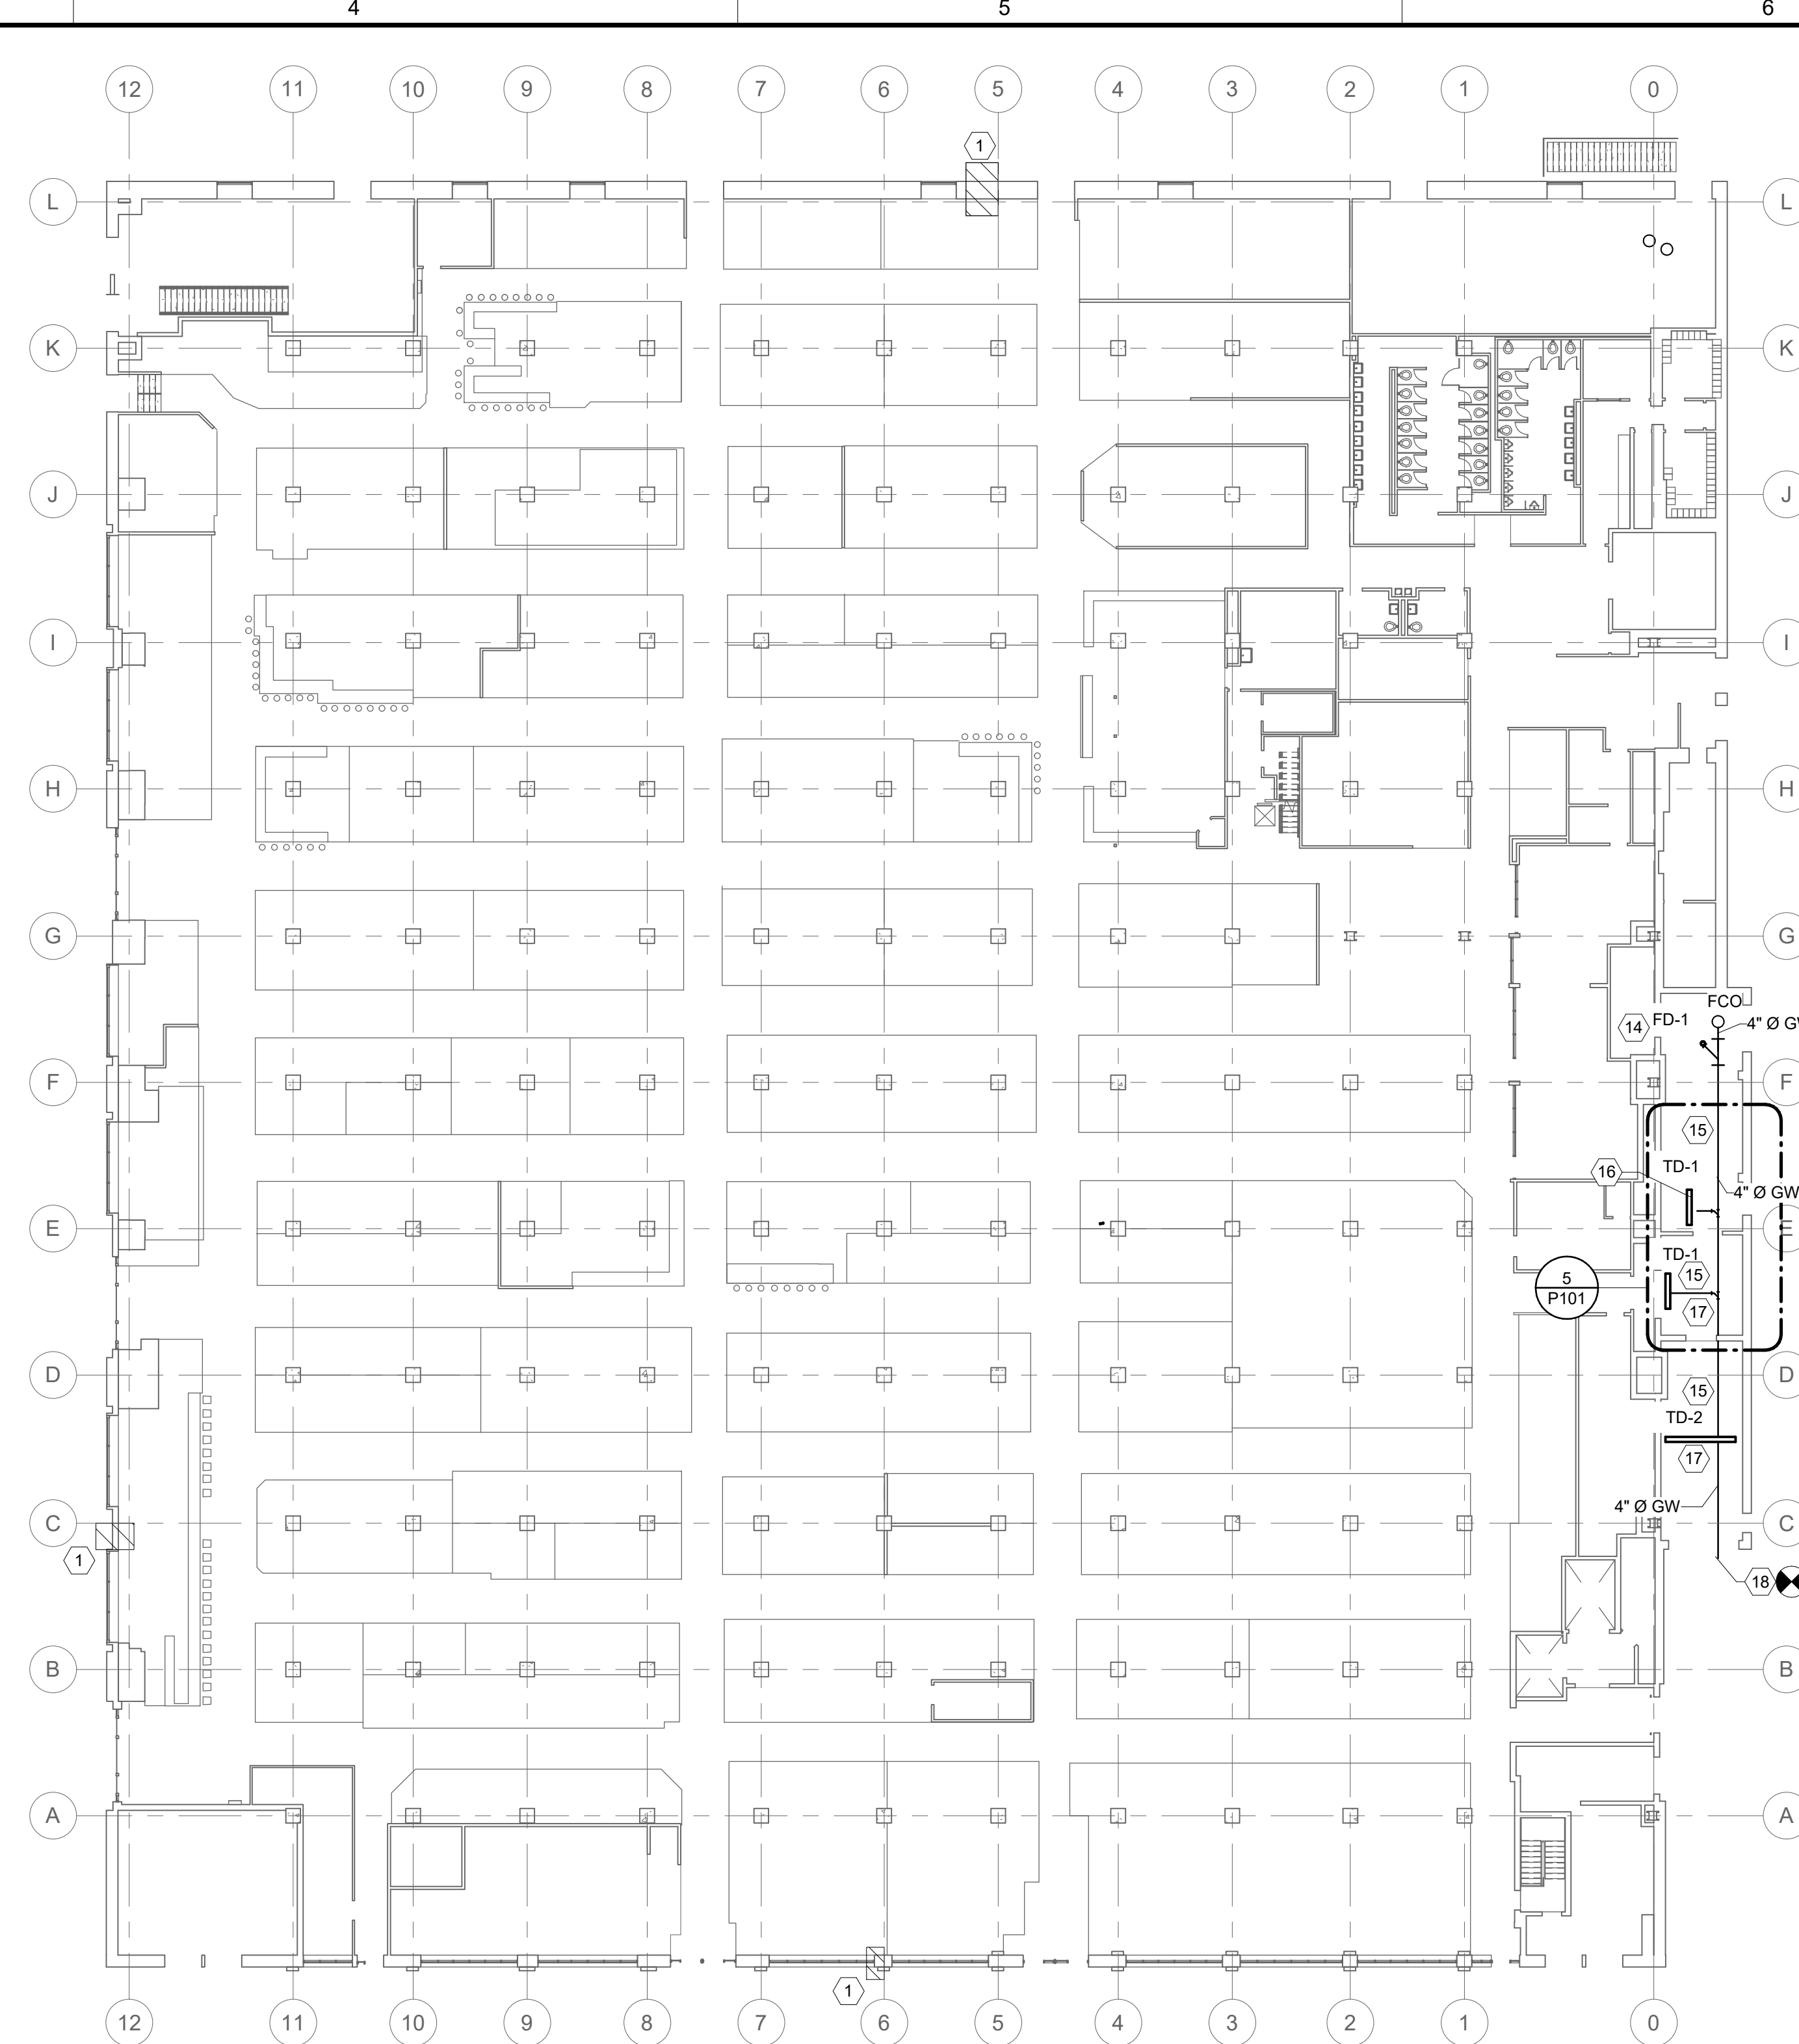SCALE: 3/64" = 1'-0"




3 PLUMBING NEW WORK MECHANICAL ROOM FLOOR PLAN

SCALE: 1/4" = 1'-0"

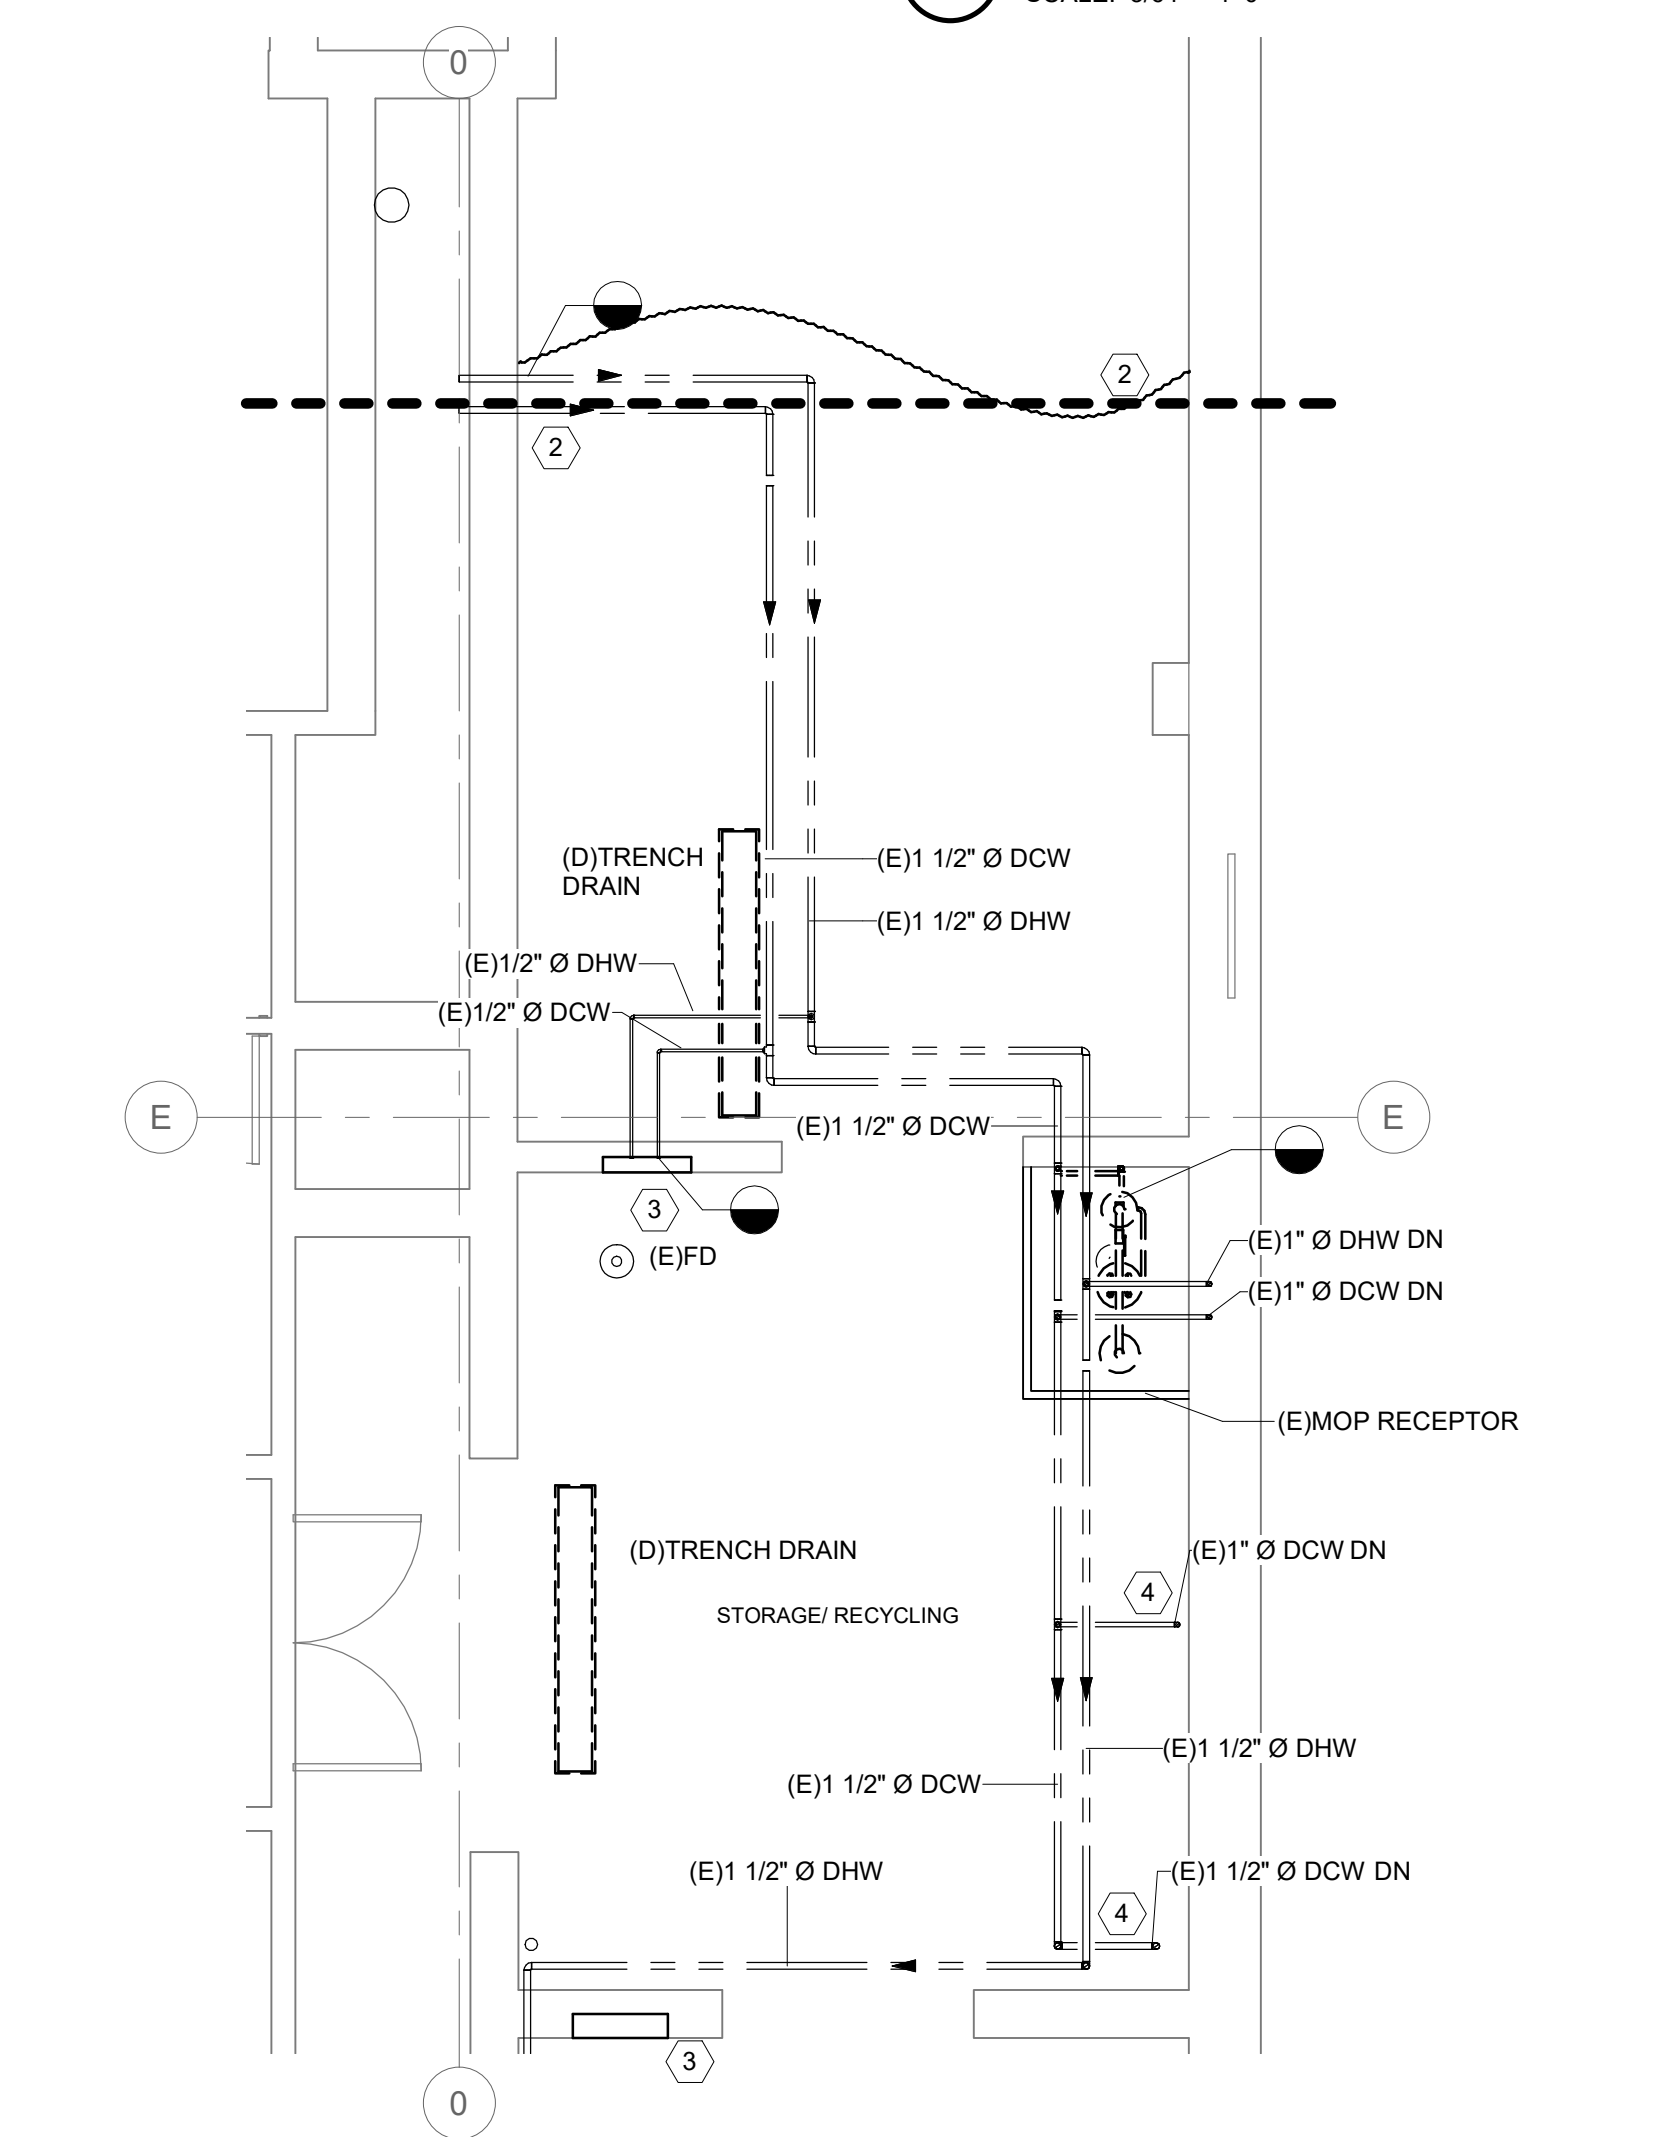

4 PLUMBING DEMLITION TRASH/STORAGE ROOM FLOOR PLAN

SCALE: 1/4" = 1'-0"

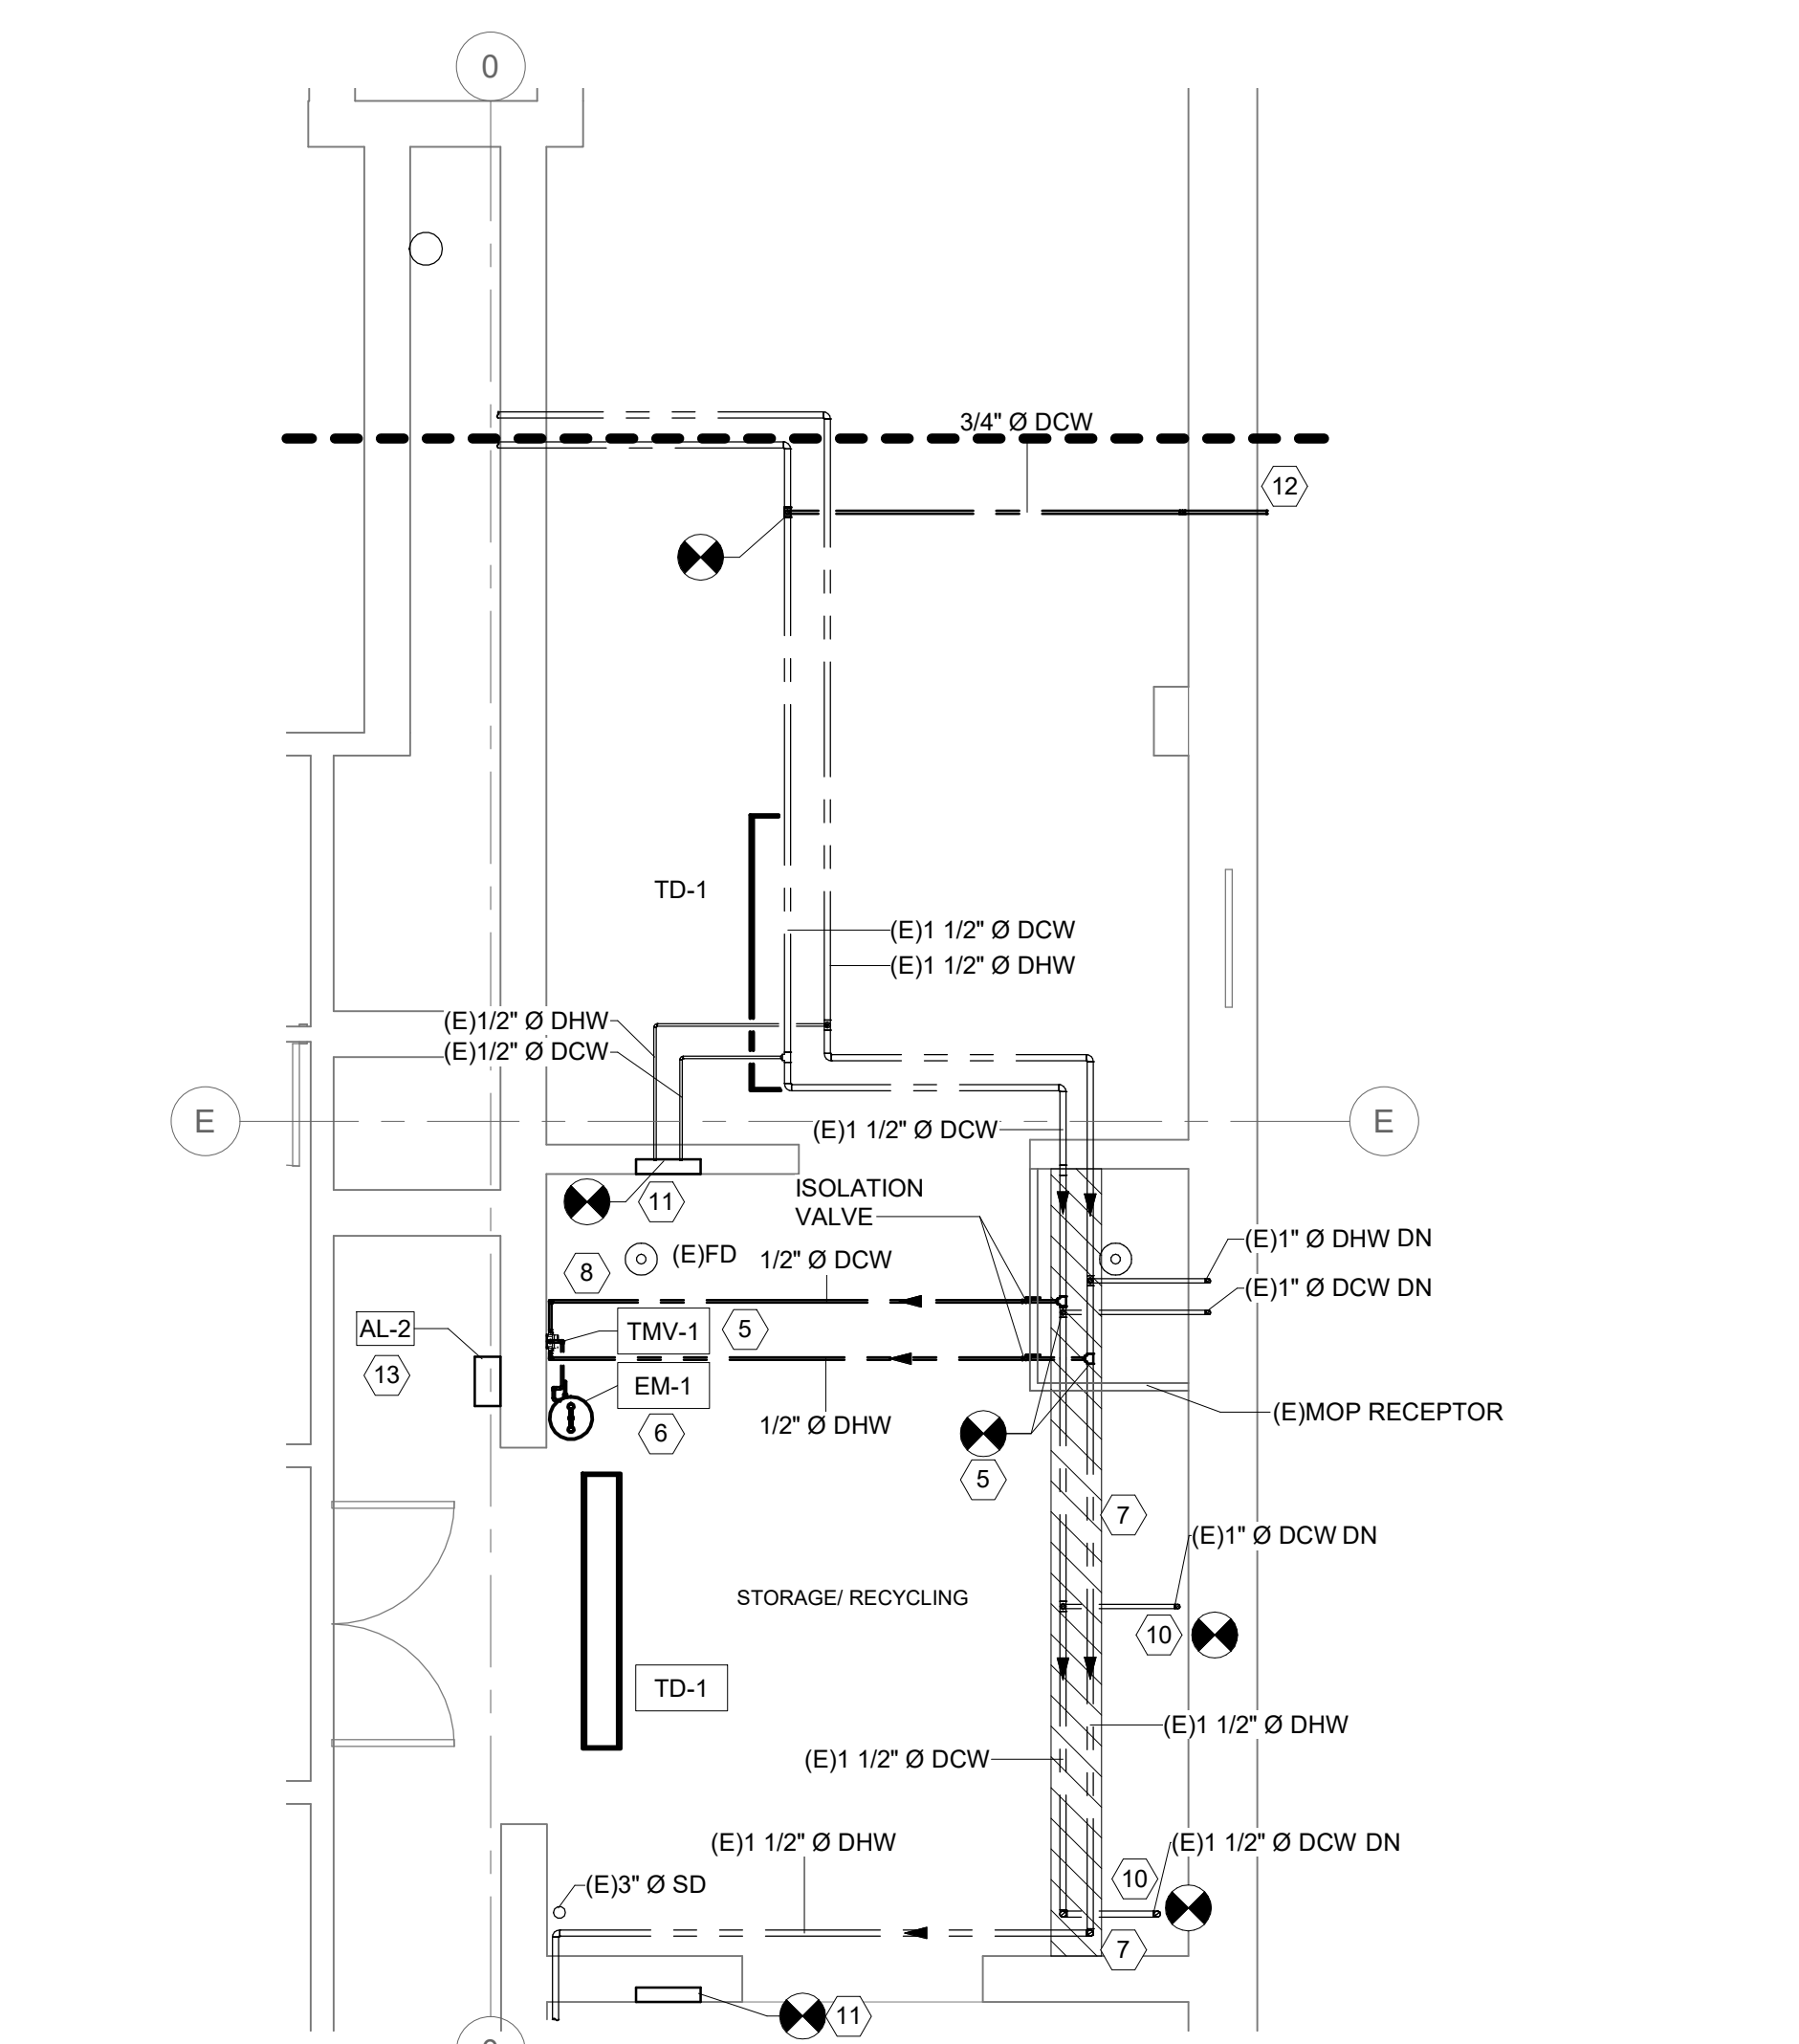

5 PLUMBING NEW WORK TRASH/STORAGE ROOM FLOOR PLAN

SCALE: 1/4" = 1'-0"

GENERAL NEW WORK NOTES

1. LABEL ALL NEW PIPING, VALVES, AND EQUIPMENT. PROVIDE LABELS WITH DIRECTIONAL ARROWS.
2. CLEAN ALL EXISTING WALL OPENINGS, PROVIDE SLEEVE AND MECHANICAL SEAL. SEAL AROUND PIPE SLEEVE WITH 20-YEAR SILICONE CAULK.
3. INSULATE ALL NEW PIPING, FITTINGS, VALVES, AND PIPING ACCESSORIES. INSULATE EXISTING PIPING WHERE NEW WORK WAS PERFORMED.
4. REMOVE ANY EXCAVATED MATERIAL FROM SITE THAT IS NOT REQUIRED FOR NEW WORK. PROVIDE PIPE BEDDING AND BACKFILL MATERIAL. BACK FILL THE EXCAVATION UP TO THE LEVEL REQUIRED. INSTALL STONE BASE AND POUR NEW CONCRETE SLAB.

SHEET KEYNOTES

1. DISCONNECT DOMESTIC COLD WATER PIPING FROM EXISTING WALL HYDRANT AND REMOVE EXISTING WALL HYDRANT. REMOVE WATER PIPING BACK INTO BASEMENT AND TEMPORARILY CAP DOMESTIC COLD WATER FOR NEW WORK. PROVIDE NEW RECESSED NON-FREEZE WALL HYDRANT WITH LOCKABLE COVER. REMOVE CAP FROM DOMESTIC COLD WATER PIPING. PROVIDE NEW BALL VALVE AND CONNECT TO HYDRANT. CAULK AND REPAIR SURROUNDING MASONRY WEATHERTIGHT TO MATCH EXISTING.
2. DISCONNECT DOMESTIC COLD WATER PIPING FROM TRAP PRIMER DEVICE. REMOVE 1/2" Ø COLD WATER PIPING FROM THE OUTLET OF THE TRAP PRIMER DEVICE TO WITHIN 6" OF THE FLOOR AND CAP. REMOVE COLD WATER PIPING, FITTINGS, VALVE, WYE HOSE FITTING AND PIPE ACCESSORIES TO OVERHEAD, BACK TO ACTIVE BRANCH AND CAP FOR NEW WORK. REMOVE HOSE THAT EXTENDS OVERHEAD TO THE OTHER SIDE OF THE ROOM.
3. DISCONNECT HOT AND COLD WATER PIPING FROM THE HOSE STATION. REMOVE AND CAP PIPING OVERHEAD FOR NEW WORK. REMOVE EXISTING HOT/COLD WATER HOSE STATION.
4. REMOVE DOMESTIC COLD WATER PIPE, INSULATION, FITTINGS, VALVE AND PIPE ACCESSORIES. REMOVE PIPING TO OVERHEAD AND CAP FOR NEW WORK.
5. PROVIDE 1/2" Ø DOMESTIC COLD WATER AND 1/2" Ø DOMESTIC HOT WATER PIPING AND CONNECT TO EXISTING OVERHEAD DOMESTIC WATER PIPING. PROVIDE ALL PIPING SUPPORTS, INSULATION, AND ACCESSORIES. AND CONNECT TO THERMOSTATIC MIXING VALVE.
6. PROVIDE WALL MOUNTED EMERGENCY FIXTURE (EM-1), FLOW SWITCH (FS-1) AND LOCKABLE (OPEN) BALL VALVE. EXTEND 1 1/4" Ø FIXTURE DRAIN TO 6" ABOVE THE FLOOR AND EXTEND ALONG THE WALL TOWARDS THE EXISTING FLOOR DRAIN. MOUNT FLOW SWITCH (FS-1) AND BALL VALVE AS CLOSE TO THE FIXTURE AS POSSIBLE AS NOT TO CREATE A DEADLEG.
7. REPLACE EXISTING HOT AND COLD WATER PIPE INSULATION AND INSTALL JACKETING WITHIN HATCHED AREA.
8. PROVIDE THERMOSTATIC MIXING VALVE. CONNECT 1/2" Ø DOMESTIC COLD AND HOT WATER TO THE INLETS OF THE MIXING VALVE. EXTEND 1/2" Ø TEPID WATER FROM THE OUTLET OF THE MIXING VALVE TO THE EMERGENCY FIXTURE. MODIFY THE EXISTING DOMESTIC HOT AND COLD WATER PIPING AS REQUIRED TO CONNECT NEW PIPING. MOUNT THE MIXING VALVE AND ENCLOSURE AT 54" ABOVE FINISHED FLOOR. PROVIDE LOCKABLE (OPEN) BALL VALVES AND UNIONS ON THE INLETS/OUTLET OF THE MIXING VALVE.
9. PROVIDE ALARMS (AL-1 AND AL-2). MOUNT ALARM (AL-1) ON THE COLUMN ABOVE EMERGENCY FIXTURE (EM-1). MOUNT ALARM (AL-2) ABOVE THE MECHANICAL ROOM DOOR. WIRING BETWEEN ALARMS AND THE FLOW SWITCH IS BY THE ELECTRICAL CONTRACTOR AND SHALL BE INSTALLED PER N.E.C.
10. PROVIDE HOSE BIBB (HB) WITH VACUUM BREAKER, PIPING, FITTINGS, BALL VALVE, PIPE ACCESSORIES. INSULATION AND PVC JACKET. MODIFY AND EXTEND 3/4" Ø DOMESTIC COLD-WATER PIPING FROM OVERHEAD AND CONNECT TO HOSE BIB. OWNER TO PROVIDE HOSE.
11. PROVIDE HOT AND COLD WATER HOSE STATION WITH VACUUM BREAKER, SPRAY NOZZLE, PIPING, BALL VALVE, INSULATION AND PVC JACKET. REMOVE CAPS FROM HOT AND COLD WATER PIPING OVERHEAD, MODIFY PIPING AS REQUIRED, DROP AND CONNECT TO HOSE STATION. OWNER TO PROVIDE HOSE.
12. PROVIDE HOSE BIBB (HB) WITH VACUUM BREAKER, RECESSED NON-FREEZE WALL HYDRANT (NFWH) WITH VACUUM BREAKER AND LOCKABLE COVER. PIPING, FITTINGS, BALL VALVE, PIPE ACCESSORIES, INSULATION AND PVC JACKET. MODIFY AND EXTEND 3/4" Ø DOMESTIC COLD-WATER PIPING FROM OVERHEAD AND CONNECT TO HOSE BIB AND NON-FREEZE WALL HYDRANT. CORE DRILL EXTERIOR WALL. PROVIDE WALL SLEEVE AND MECHANICAL SEAL. SEAL AROUND SLEEVE WITH 20-YEAR SILICONE CAULK. OWNER TO PROVIDE HOSE.
13. PROVIDE ALARM (AL-2). MOUNT AT 6'-0" ABOVE FINISHED FLOOR. CORE DRILL WALL TO EXTEND WIRING BETWEEN THE FLOW SWITCH AND ALARM (AL-2). WIRING BY E.C. AND INSTALLED PER N.E.C.
14. EXCAVATE CONCRETE AND SOIL AS REQUIRED TO REMOVE EXISTING FLOOR DRAIN. CLEANOUT AND ASSOCIATED PIPING. PROVIDE NEW FLOOR DRAIN, CLEANOUT, IN-LINE TRAP SEAL AND GREASE WASTE PIPING. FIELD VERIFY THE LOCATION OF THE EXISTING PIPING.
15. EXCAVATE CONCRETE AND SOIL AS REQUIRED TO REMOVE EXISTING TRENCH DRAIN, GRATES, AND ASSOCIATED PIPING.
16. REMOVE EXISTING TRENCH DRAIN, GRATES, AND ASSOCIATED 4" Ø PIPING. PROVIDE NEW TRENCH DRAIN, GRATES, 4" Ø GREASE WASTE PIPING. INSTALL NEW TRENCH DRAIN OUTSIDE OF THE RAISED CONCRETE SLAB FOOTPRINT. SUPPORT RAISED SLAB DURING CONSTRUCTION. ADJUST THE LOCATION OF THE PIPING AS REQUIRED TO INSTALL TRENCH DRAIN. MODIFY EXISTING ABOVE FLOOR DRAIN PIPE AND DISCHARGE TO NEW TRENCH DRAIN.
17. REMOVE EXISTING TRENCH DRAIN, SLOTTED AND SOLID GRATES, AND ASSOCIATED 4" Ø PIPING. PROVIDE NEW TRENCH DRAIN, SLOTTED AND SOLID GRATES, AND 4" Ø GREASE WASTE PIPING.
18. REMOVE AND REPLACE EXISTING 4" Ø PIPING TO THIS POINT. CONNECT TO EXISTING PIPING



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NO.	DATE	DESCRIPTION
REVISIONS		
GENERAL PACKAGE		
PROJECT NUMBER: 071274		
DESIGNED: WKK	MODELED: JMJ	CHECKED: MJM
DATE: 02/03/23		
DRAWING TITLE: PLUMBING DOMESTIC NEW WORK FLOOR PLANS		
DRAWING NO.:		

P101

Local File:Autodesk Docs\\071274-RTM_Renovation_Project\\071274_Read\\TerminalMarket MEP_R022.rvt

Project Number: 071274
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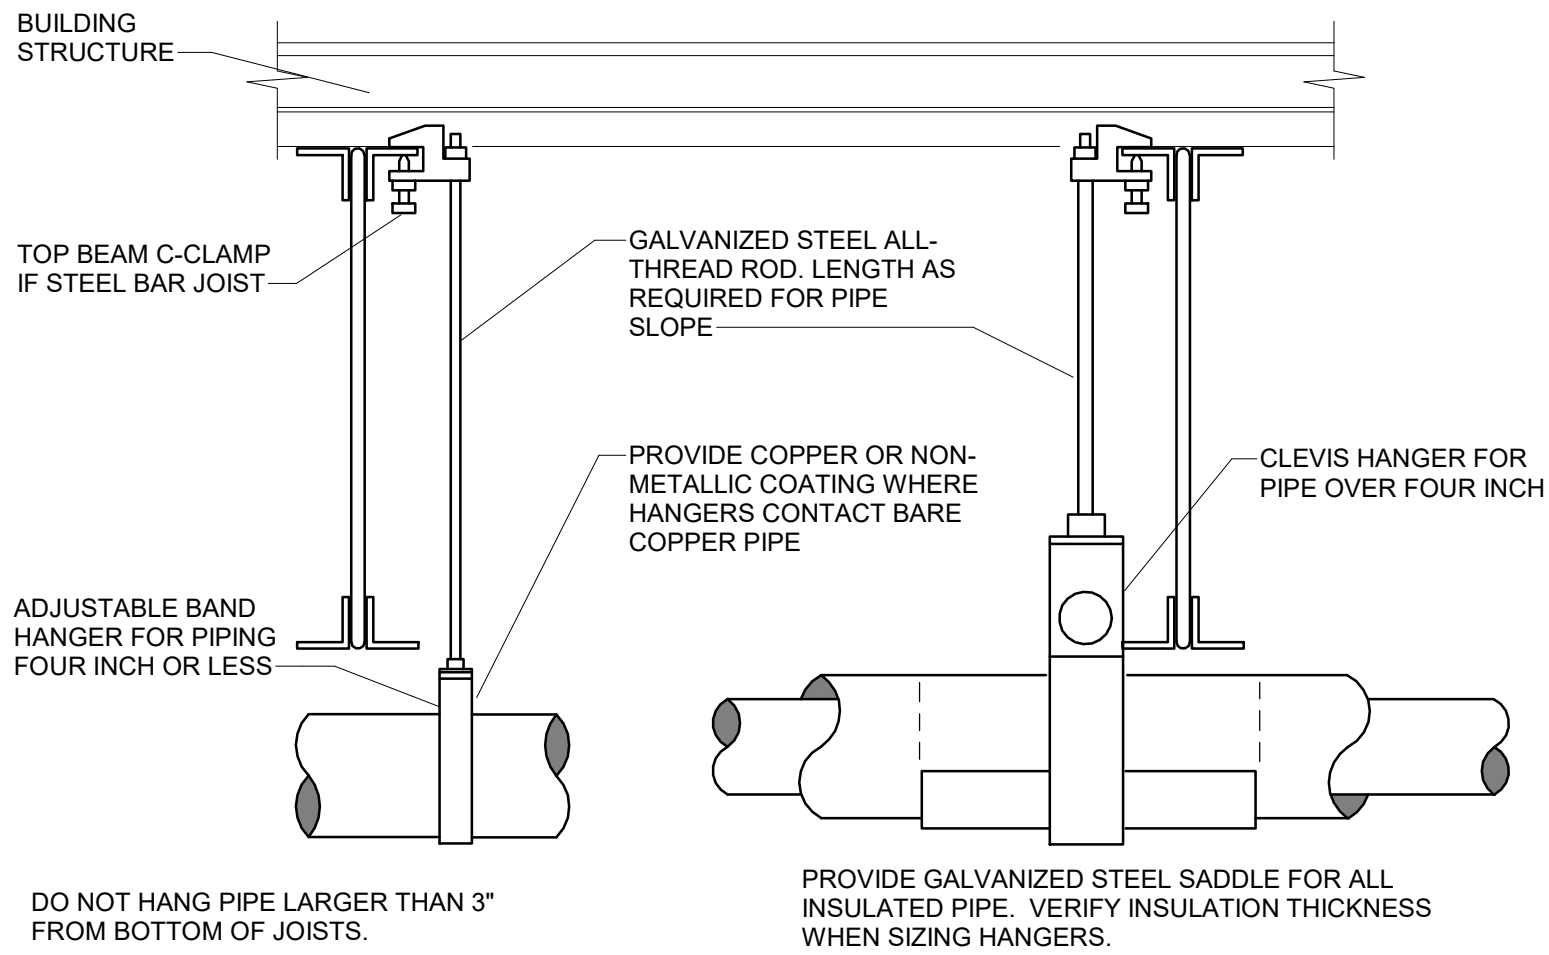
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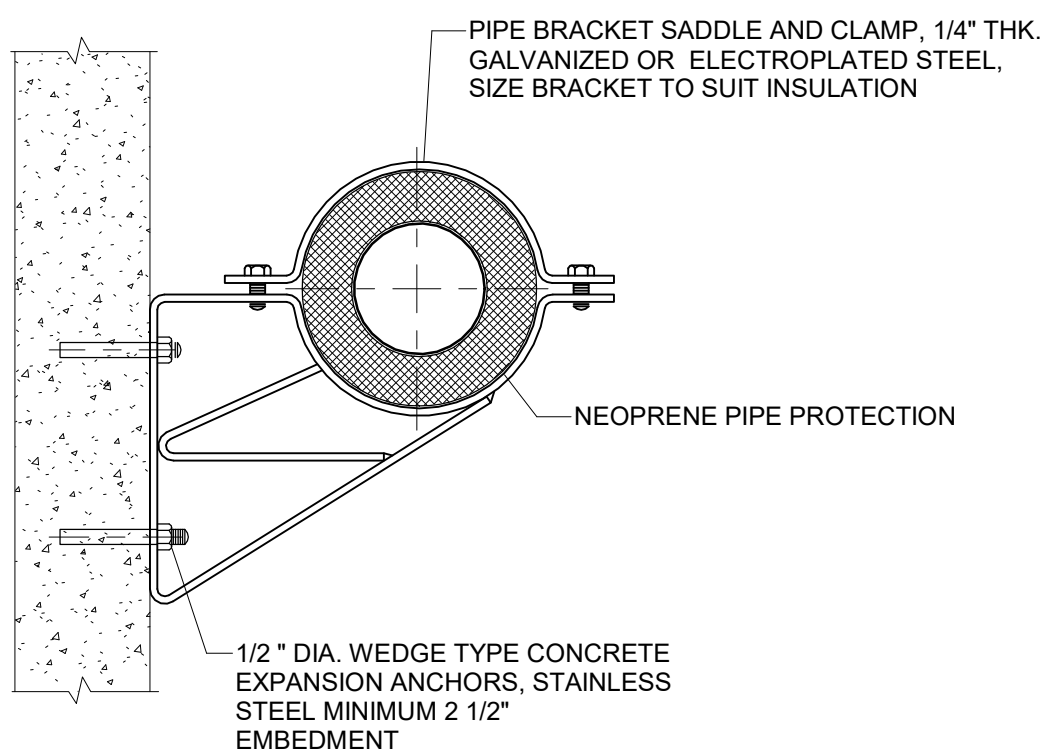
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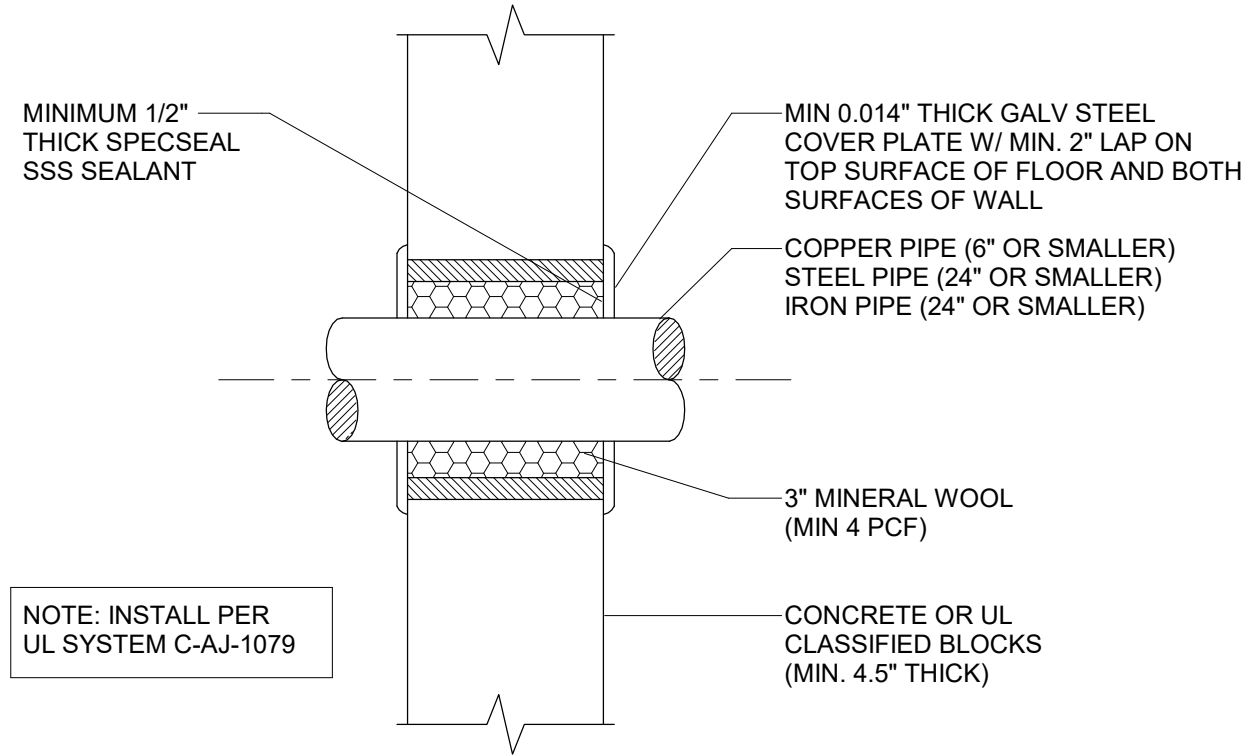
1 PLUMBING PIPE HANGER

SCALE: NTS



2 WALL HUNG PIPE SUPPORT FOR INSULATED PIPE

SCALE: NTS



3 INTERIOR FIRE RATED WALL OR FLOOR PENETRATION

SCALE: NTS

EMERGENCY FIXTURE SCHEDULE													
MARK	FIXTURE TYPE	TW CONNECTION	FIXTURE BASIS OF DESIGN		FLOW SWITCH					ALARM			REMARKS
			MANUFACTURER	MODEL	MARK	SIZE	MANUFACTURER	MODEL	ELECTRICAL	MANUFACTURER	MODEL	ELECTRICAL	
AL-1	VISUAL ONLY	N/A	N/A	N/A	N/A	N/A	N/A	N/A	N/A	GUARDIAN	AP275-215MOD	120/160 0.48A	FLASHING LIGHT, NO CORD
AL-2	AUDIBLE/VISUAL	N/A	N/A	N/A	N/A	N/A	N/A	N/A	N/A	GUARDIAN	AP275-250MOD	120/160 0.48A	FLASHING LIGHT, HORN, NO CORD
EM-1	EYE/FACE WASH	1/2"	GUARDIAN	G1760-BC	FS-1	1/2"	GUARDIAN	AP285-617	N/A	N/A	N/A	N/A	WALL MTD. SS WITH BOWL COVER

PLUMBING MIXING VALVE SCHEDULE								
MARK	FLOW RATE		DCW INLET (IN)	DHW INLET (IN)	SYSTEM PRESSURE (PSI)	MANUFACTURER	MODEL	REMARKS
	MIN (GPM)	MAX (GPM)						
TMV-1	3	8	1/2"	1/2"	125	GUARDIAN	G6020	1,2,3,4
TMV-2	3	8	1/2"	1/2"	125	GUARDIAN	G6020	1,2,3,4

REMARKS:
1. THERMOSTATIC MIXING VALVE SHALL BE PROVIDED WITH COLD WATER BYPASS AND BE ANSI/ASSE 1071 CERTIFIED.
2. CONTRACTOR SHALL ADJUST AND SET TEPID WATER SUPPLY TEMPERATURE TO 80 DEGREE F.
3. PROVIDE WITH MOUNTING BRACKET AND STAINLESS STEEL HARDWARE.
4. PROVIDE WITH MANUFACTURER OUTLET TEMPERATURE GAUGE. VALVE SHALL BE ANSI/ASSE 1017 CERTIFIED.

FLOOR DRAIN SCHEDULE								
MARK	FIXTURE TYPE	OUTLET (IN)	BODY	STRAINER	LOCATION	BASIS OF DESIGN		REMARKS
						MANUFACTURER	MODEL	
FD-1	FLOOR DRAIN	4"	CAST IRON	CAST IRON	STORAGE/RECYCLING	ZURN	Z-520-Y	
TD-1	TRENCH DRAIN	4"	CAST IRON	CAST IRON	VARIES	ZURN	P12-HDPE	
TD-2	TRENCH DRAIN	4"	CAST IRON	CAST IRON	TRASH COMPACTOR	ZURN	P12-HDPE	

PLUMBING MATERIAL SCHEDULE							
SERVICE	MATERIAL	SIZE RANGE	MAXIMUM DESIGN		JOINT TYPE	ISOLATION VALVE TYPE	REMARKS
			PRESSURE (PSIG)	TEMPERATURE (°F)			
ABOVE GRADE							
DOMESTIC COLD WATER	TYPE L COPPER	> 2-1/2"	75	65	1 OR 2	1	
DOMESTIC HOT WATER	TYPE L COPPER	> 2-1/2"	75	140	1 OR 2	1	
DOMESTIC HOT WATER RETURN	TYPE L COPPER	> 2-1/2"	75	140	1 OR 2	1	
TEPID WATER	TYPE L COPPER	> 2-1/2"	150	80	1 OR 2	1	
JOINT TYPE				VALVE TYPE			
TYPE 1: 95-5 SOLDER				TYPE 1: 2-PIECE BALL VALVE, FULL PORT			
TYPE 2: PRESS COUPLED				TYPE 2: PLUG			

PLUMBING PIPE INSULATION SCHEDULE			
SYSTEM TYPE	PIPE SIZE	INSULATION CONDUCTIVITY	THICKNESS
DOMESTIC COLD WATER	1"Ø AND SMALLER	0.21 - 0.28	1/2"
DOMESTIC COLD WATER	1 1/2"Ø AND LARGER	0.21 - 0.28	1"
DOMESTIC HOT WATER	1"Ø AND SMALLER	0.21 - 0.28	1"
DOMESTIC HOT WATER	1 1/2"Ø AND LARGER	0.21 - 0.28	1 1/2"
TEPID WATER SUPPLY/RETURN	1/2"Ø AND LARGER	0.21 - 0.28	1"



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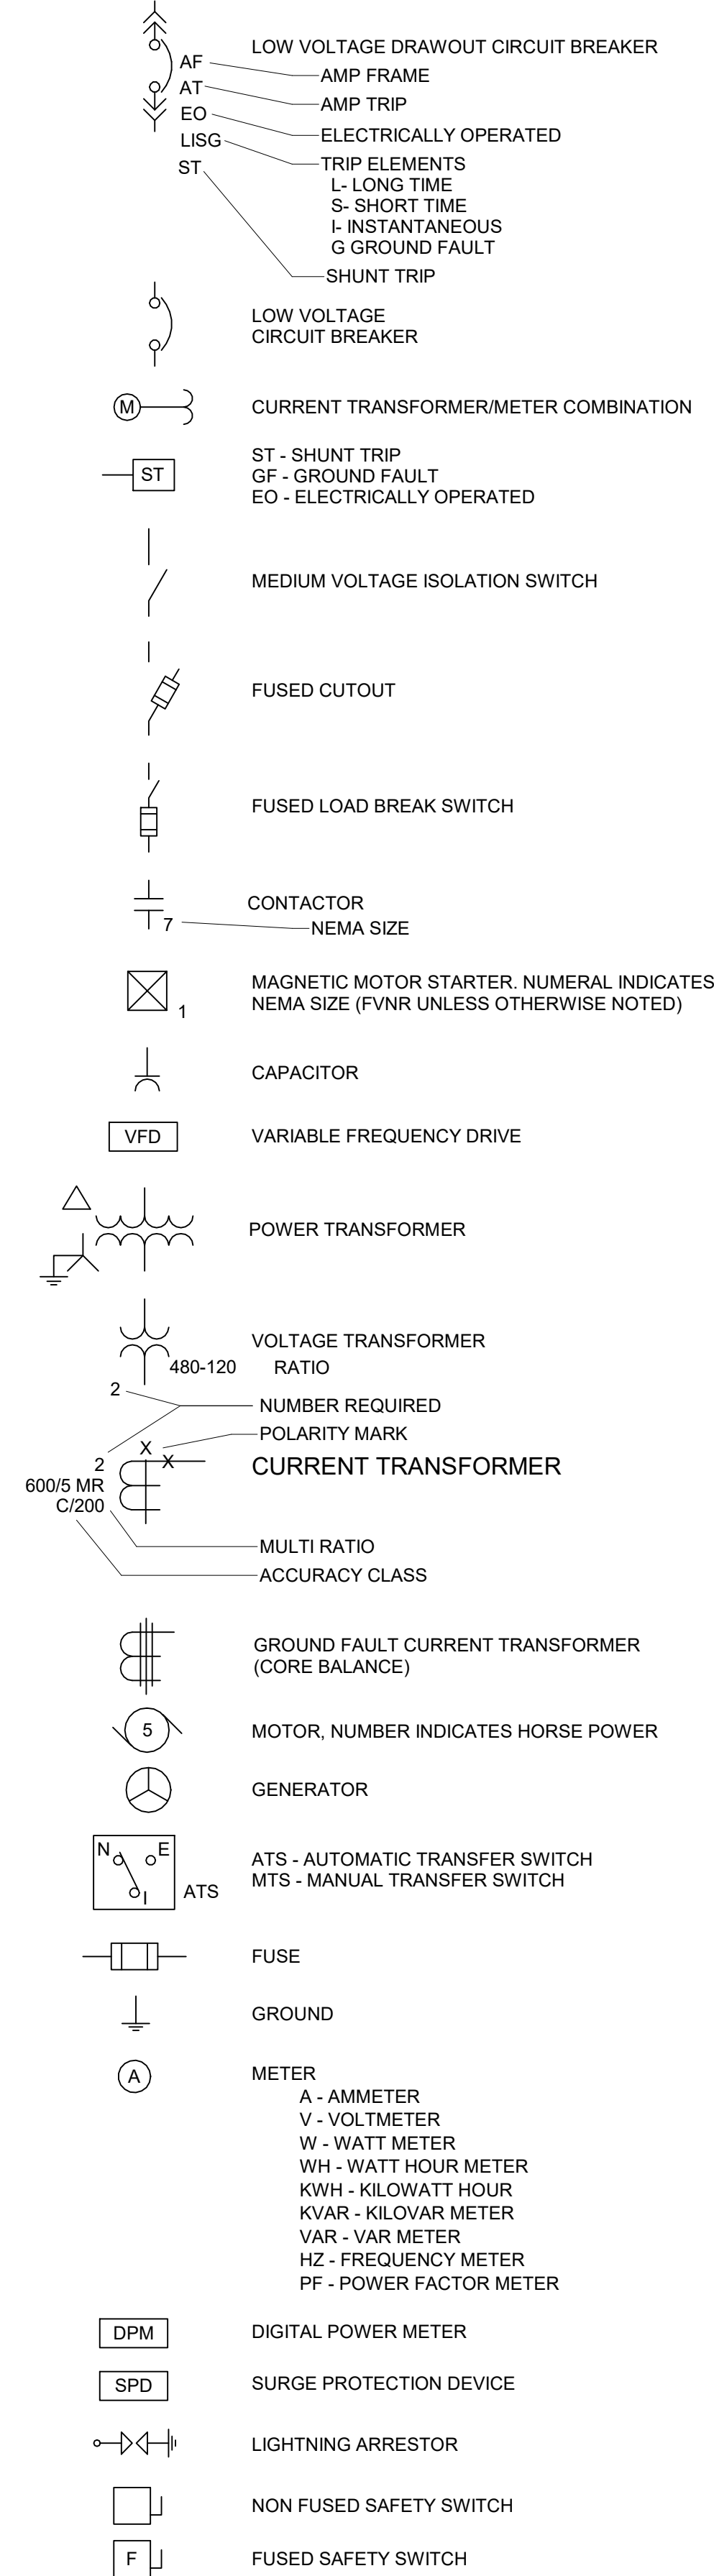
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DESIGNED: WKK	MODELED: JMJ	CHECKED: MJM
DATE: 02/03/23		
DRAWING TITLE: PLUMBING		
DETAILS & SCHEDULES		
DRAWING NO.: P501		


ABBREVIATIONS

(D)	DEMOLISH
(E)	EXISTING
A or AMP	AMPERE
AC	ALTERNATING CURRENT
AFF	ABOVE FINISH FLOOR
AFG	ABOVE FINISH GRADE
AIC	AMPERE INTERRUPTING CAPACITY
AS	AMMETER SELECTOR SWITCH
ATS	AMMETER SELECTOR SWITCH
AUTO	AUTOMATIC TRANSFER SWITCH
AWG	AMERICAN WIRE GAUGE
BLDG	BUILDING
C	CONDUIT
CP	CONTROL PANEL
CPT	CONTROL POWER TRANSFORMER
DISC	DISCONNECT
DIV	DIVISION
DS	DISCONNECT SWITCH
EC	ELECTRICAL CONTRACTOR
ECH	ELECTRIC CABINET HEATER
EF	EXHAUST FAN
EMT	ELECTRICAL METALLIC TUBING(CONDUIT)
	ELECTRICAL METALLIC TUBING(CONDUIT)
EP	EXPLOSION PROOF
EUH	ELECTRIC UNIT HEATER
F/T	FEED THROUGH
FAAP	FIRE ALARM ANNUNCIATOR PANEL
FACP	FIRE ALARM CONTROL PANEL
FRE	FIBERGLASS REINFORCED EPOXY
FU	FUSE
GFI	GROUND FAULT INTERRUPTER
GRD	GROUND
HID	HIGH INTENSITY DISCHARGE
HP	HORSEPOWER
HPS	HIGH PRESSURE SODIUM
HVAC	HEATING - VENTILATION - AIR CONDITIONING
IG	ISOLATED GROUND
IND	INDUSTRIAL
JIC	JOINT INDUSTRIAL COUNCIL
KV	KILOVOLT
KVA	KILOVOLT AMPERE
KW	KILOWATT
LA	LIGHTNING ARRESTOR
LC	LIGHTING CONTACTOR
LTG	LIGHTING
MCC	MOTOR CONTROL CENTER
MLO	MAIN LUG ONLY
MOA	MULTI OUTLET ASSEMBLY
MOD	MOTOR OPERATED DAMPER
MS	MOTOR STARTER
MTD	MOUNTED
MV	MEDIUM VOLTAGE
N/A	NOT APPLICABLE
NC	NORMALLY CLOSED
NO	NORMALLY OPEN
No	NUMBER
PMT	PAD MOUNTED TRANSFORMER
PNL	PANEL
PT	POTENTIAL TRANSFORMER
PVC	POLYVINYL CHLORIDE (CONDUIT)
RECP	RECEPTACLE
RGS	RIGID GALVANIZED STEEL(CONDUIT)
RVAT	REDUCED VOLTAGE AUTOTRANSFORMER
RVSS	REDUCED VOLTAGE SOLID STATE
SC	SURGE CAPACITOR
SPD	SURGE PROTECTION DEVICE
SW	SWITCH
SWBD	SWITCHBOARD
TC	CABLE TRAY - CABLE
TTB	TELEPHONE TERMINAL BOARD
TTT	TELEPHONE TERMINAL CABINET
TYP	TYPICAL
UH	UNIT HEATER
UL	UNDERWRITER LABORATORIES
UON	UNLESS OTHERWISE NOTED
UPS	UNINTERRUPTIBLE POWER SUPPLY
V	VOLT
VS	VOLTMETER SELECTOR SWITCH
W	WIRE
WP	WEATHERPROOF
XFMR	TRANSFORMER
1-PH	SINGLE PHASE
3-PH	THREE PHASE


ONE LINE DIAGRAM



GENERAL POWER

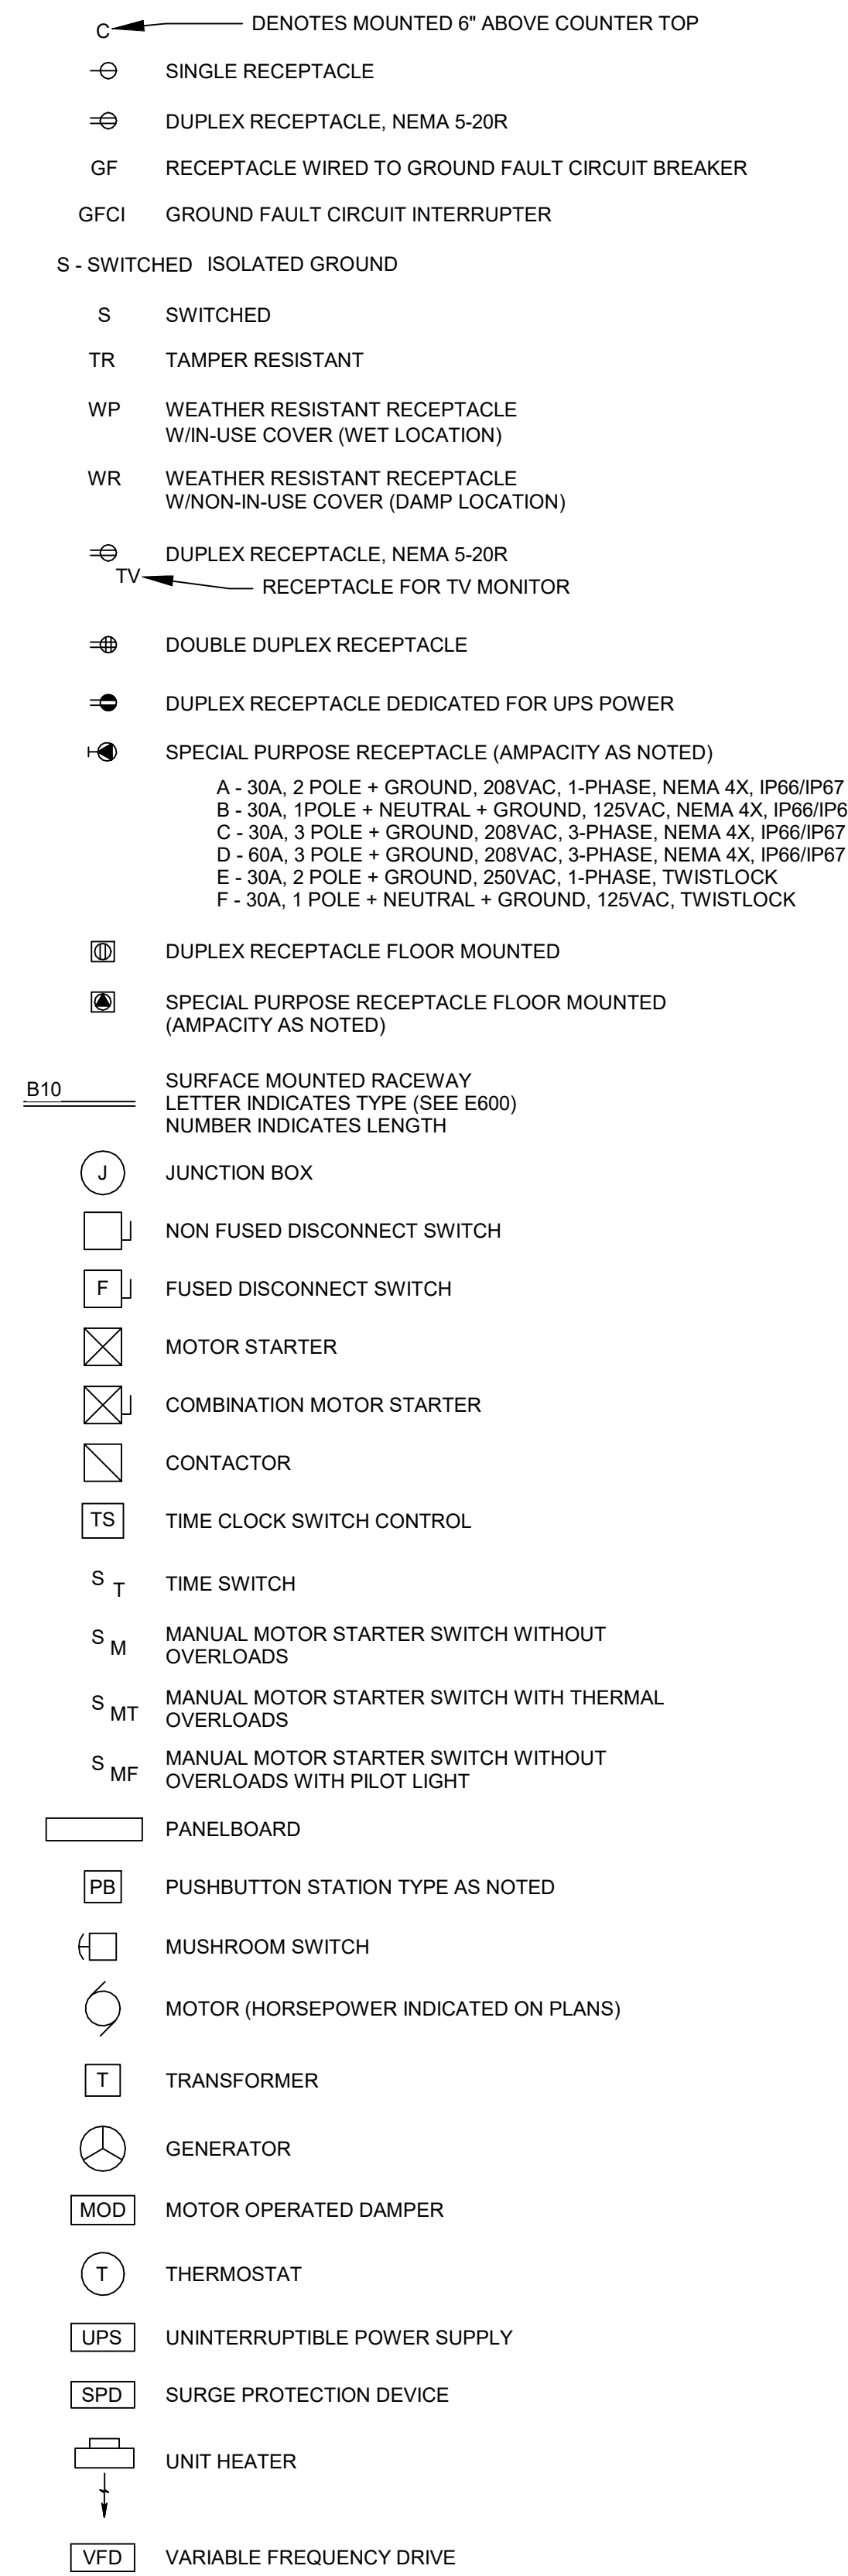

MISCELLANEOUS

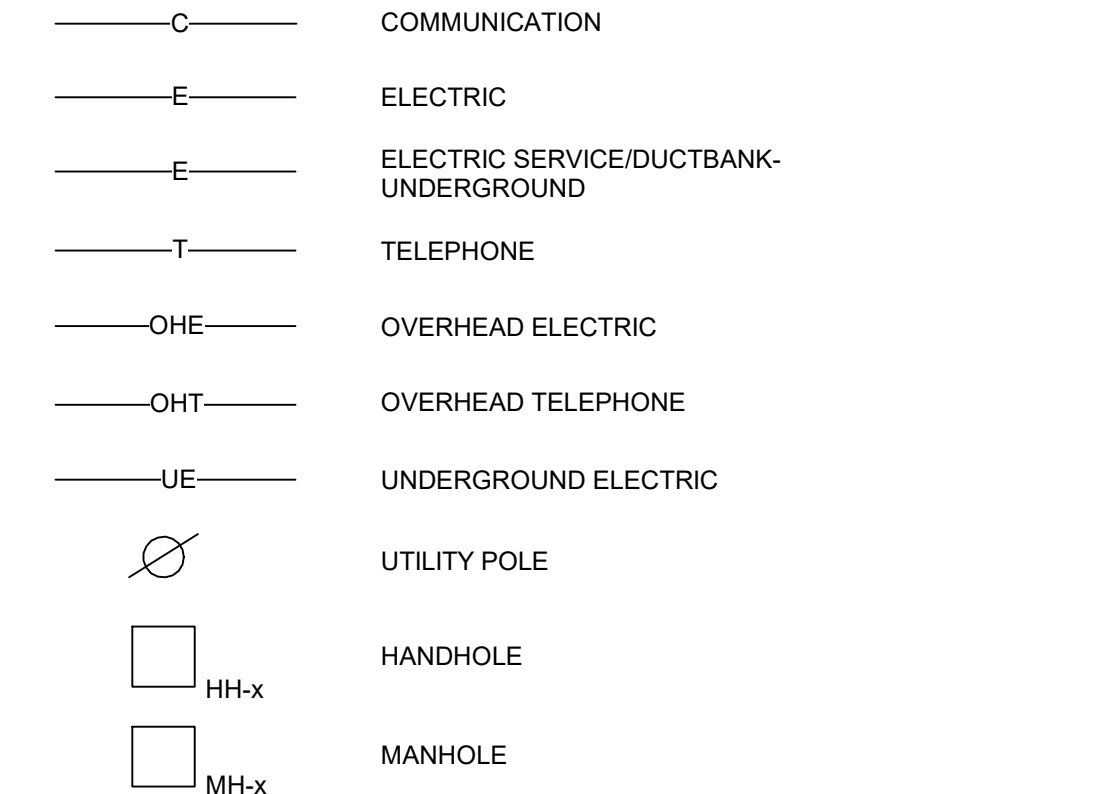


GENERAL NOTES

- ALL WORK SHALL BE PERFORMED IN ACCORDANCE WITH THE NATIONAL ELECTRICAL CODE (NFPA-70) AS ADOPTED AND AMENDED BY PHILADELPHIA ELECTRICAL CODE AND THE THE COMMONWEALTH OF PENNSYLVANIA.
- ALL ELECTRICAL WORK SHALL BE PROPERLY GROUNDED AND SHALL MEET ALL REQUIREMENTS OF THE APPLICABLE SECTION OF THE NATIONAL ELECTRICAL CODE (NEC) AND ANY AUTHORITIES HAVING JURISDICTION.
- DRAWINGS ARE DIAGRAMMATIC IN NATURE. THE CONTRACTOR SHALL VERIFY DIMENSIONS PRIOR TO INSTALLATION. CONTRACTOR SHALL COORDINATE ALL WORK WITH OTHER DIVISIONS TRADES TO PROVIDE A COMPLETE AND OPERATIONAL SYSTEM. CONTRACTOR SHALL COORDINATE LOCATION OF FIXTURES, DEVICES, ETC WITH OTHER TRADES IN ORDER TO AVOID INTERFERENCES.
- ARCHITECTURAL FEATURES SHOWN ON THESE DRAWINGS ARE FOR BACKGROUND INFORMATION ONLY. REFER TO THE ARCHITECTURAL AND STRUCTURAL DRAWINGS FOR ACTUAL BUILDING CONSTRUCTION WALLS AND CURBS. REFER TO EQUIPMENT DRAWINGS FOR ACTUAL LOCATION OF EQUIPMENT.
- EXACT CONDUIT STUB-UP LOCATIONS ARE TO BE DETERMINED BY THE ELECTRICAL CONTRACTOR BASED ON THE CERTIFIED MANUFACTURER'S DRAWINGS OF RESPECTIVE EQUIPMENT. CONDUITS SHALL BE INSTALLED TO AGREE WITH EQUIPMENT DRAWINGS.
- WALL AND FLOOR PENETRATIONS SHALL BE BY THE ELECTRICAL CONTRACTOR. PROVIDE FIRESTOP AS REQUIRED FOR ALL PENETRATIONS MADE FOR ELECTRICAL WORK.
- COORDINATE THE COLORS OF WIRING DEVICES AND FACEPLATES WITH THE ARCHITECT.
- EQUIPMENT AND DEVICES SHALL MATCH THE BUILDING STANDARD.


WIRING METHODS

- UNDERGROUND
 - A. UNLESS OTHERWISE NOTED ON THE DRAWINGS CONCRETE ENCASED AND DIRECT BURIED CONDUIT SHALL BE SCHEDULE 40 PVC. WHERE CONDUITS PASS THROUGH GRADE, THROUGH CONCRETE PADS, OR THROUGH BUILDING FOUNDATION WALLS OR FLOOR SLABS CONDUIT SHALL BE PVC COATED.
- OUTDOORS
 - A. UNLESS OTHERWISE NOTED ON THE DRAWINGS CONDUIT INSTALLED OUTDOORS SHALL BE GALVANIZED RIGID STEEL AND FLEXIBLE CONNECTIONS SHALL BE LIQUIDTIGHT FLEXIBLE METAL CONDUIT.
- INDOORS
 - A. IN FINISHED AREAS ALL RACEWAY AND WIRING SHALL BE CONCEALED AND BOXES RECESSES. WIRING INSTALLED IN MASONRY WALLS SHALL BE EMT OR GALVANIZED RIGID STEEL. WIRING INSTALLED IN STUD WALL CAVITIES OR ABOVE HUNG CEILINGS MAY BE TYPE MC CABLE OR EMT.
 - B. IN UNFINISHED AREAS SUCH AS MECHANICAL AND ELECTRICAL ROOMS WIRING SHALL BE INSTALLED IN EMT.
 - C. WIRING IN THE CRAWLSPACE SHALL BE INSTALLED IN RIGID METAL CONDUIT.


LINES & REFERENCE SYMBOLS

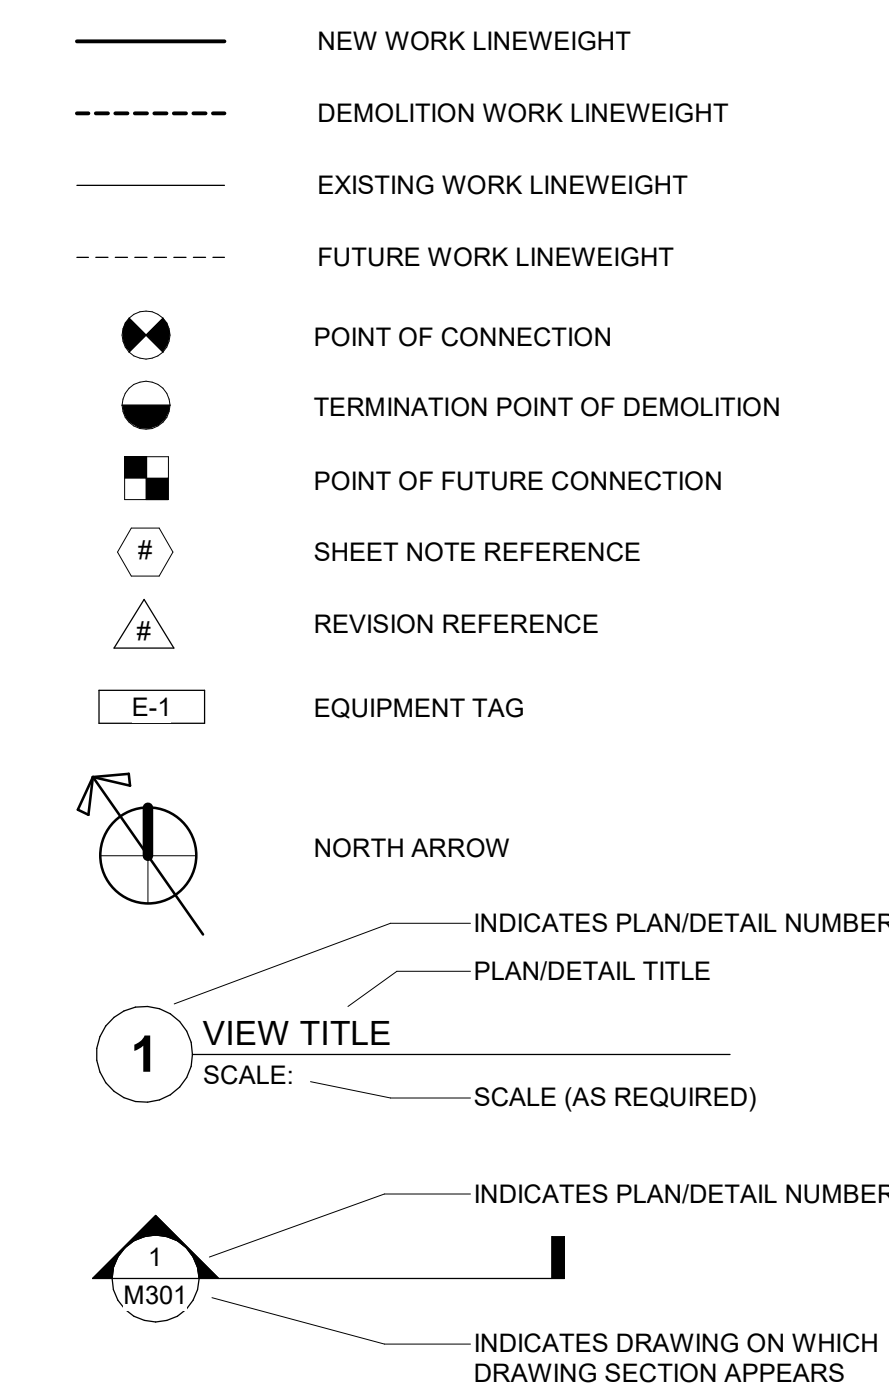

CONDUIT FEEDERS & BRANCH CIRCUITS

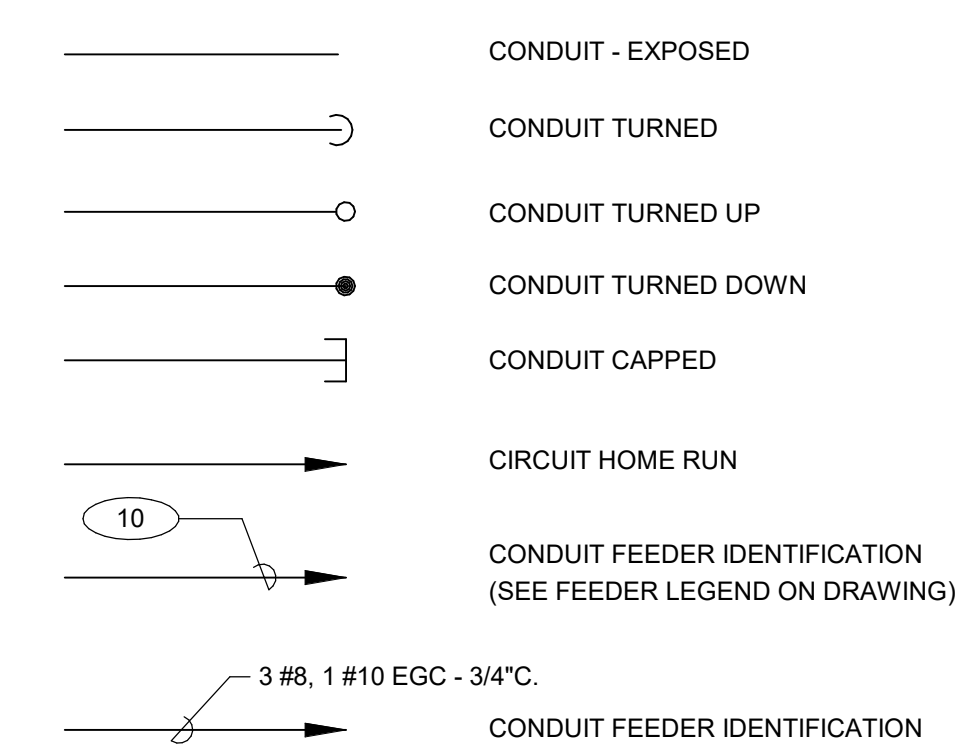

GROUNDING

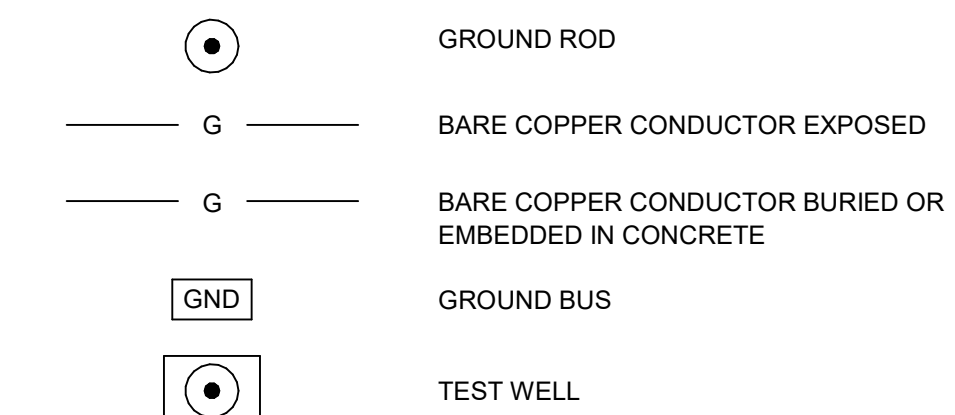

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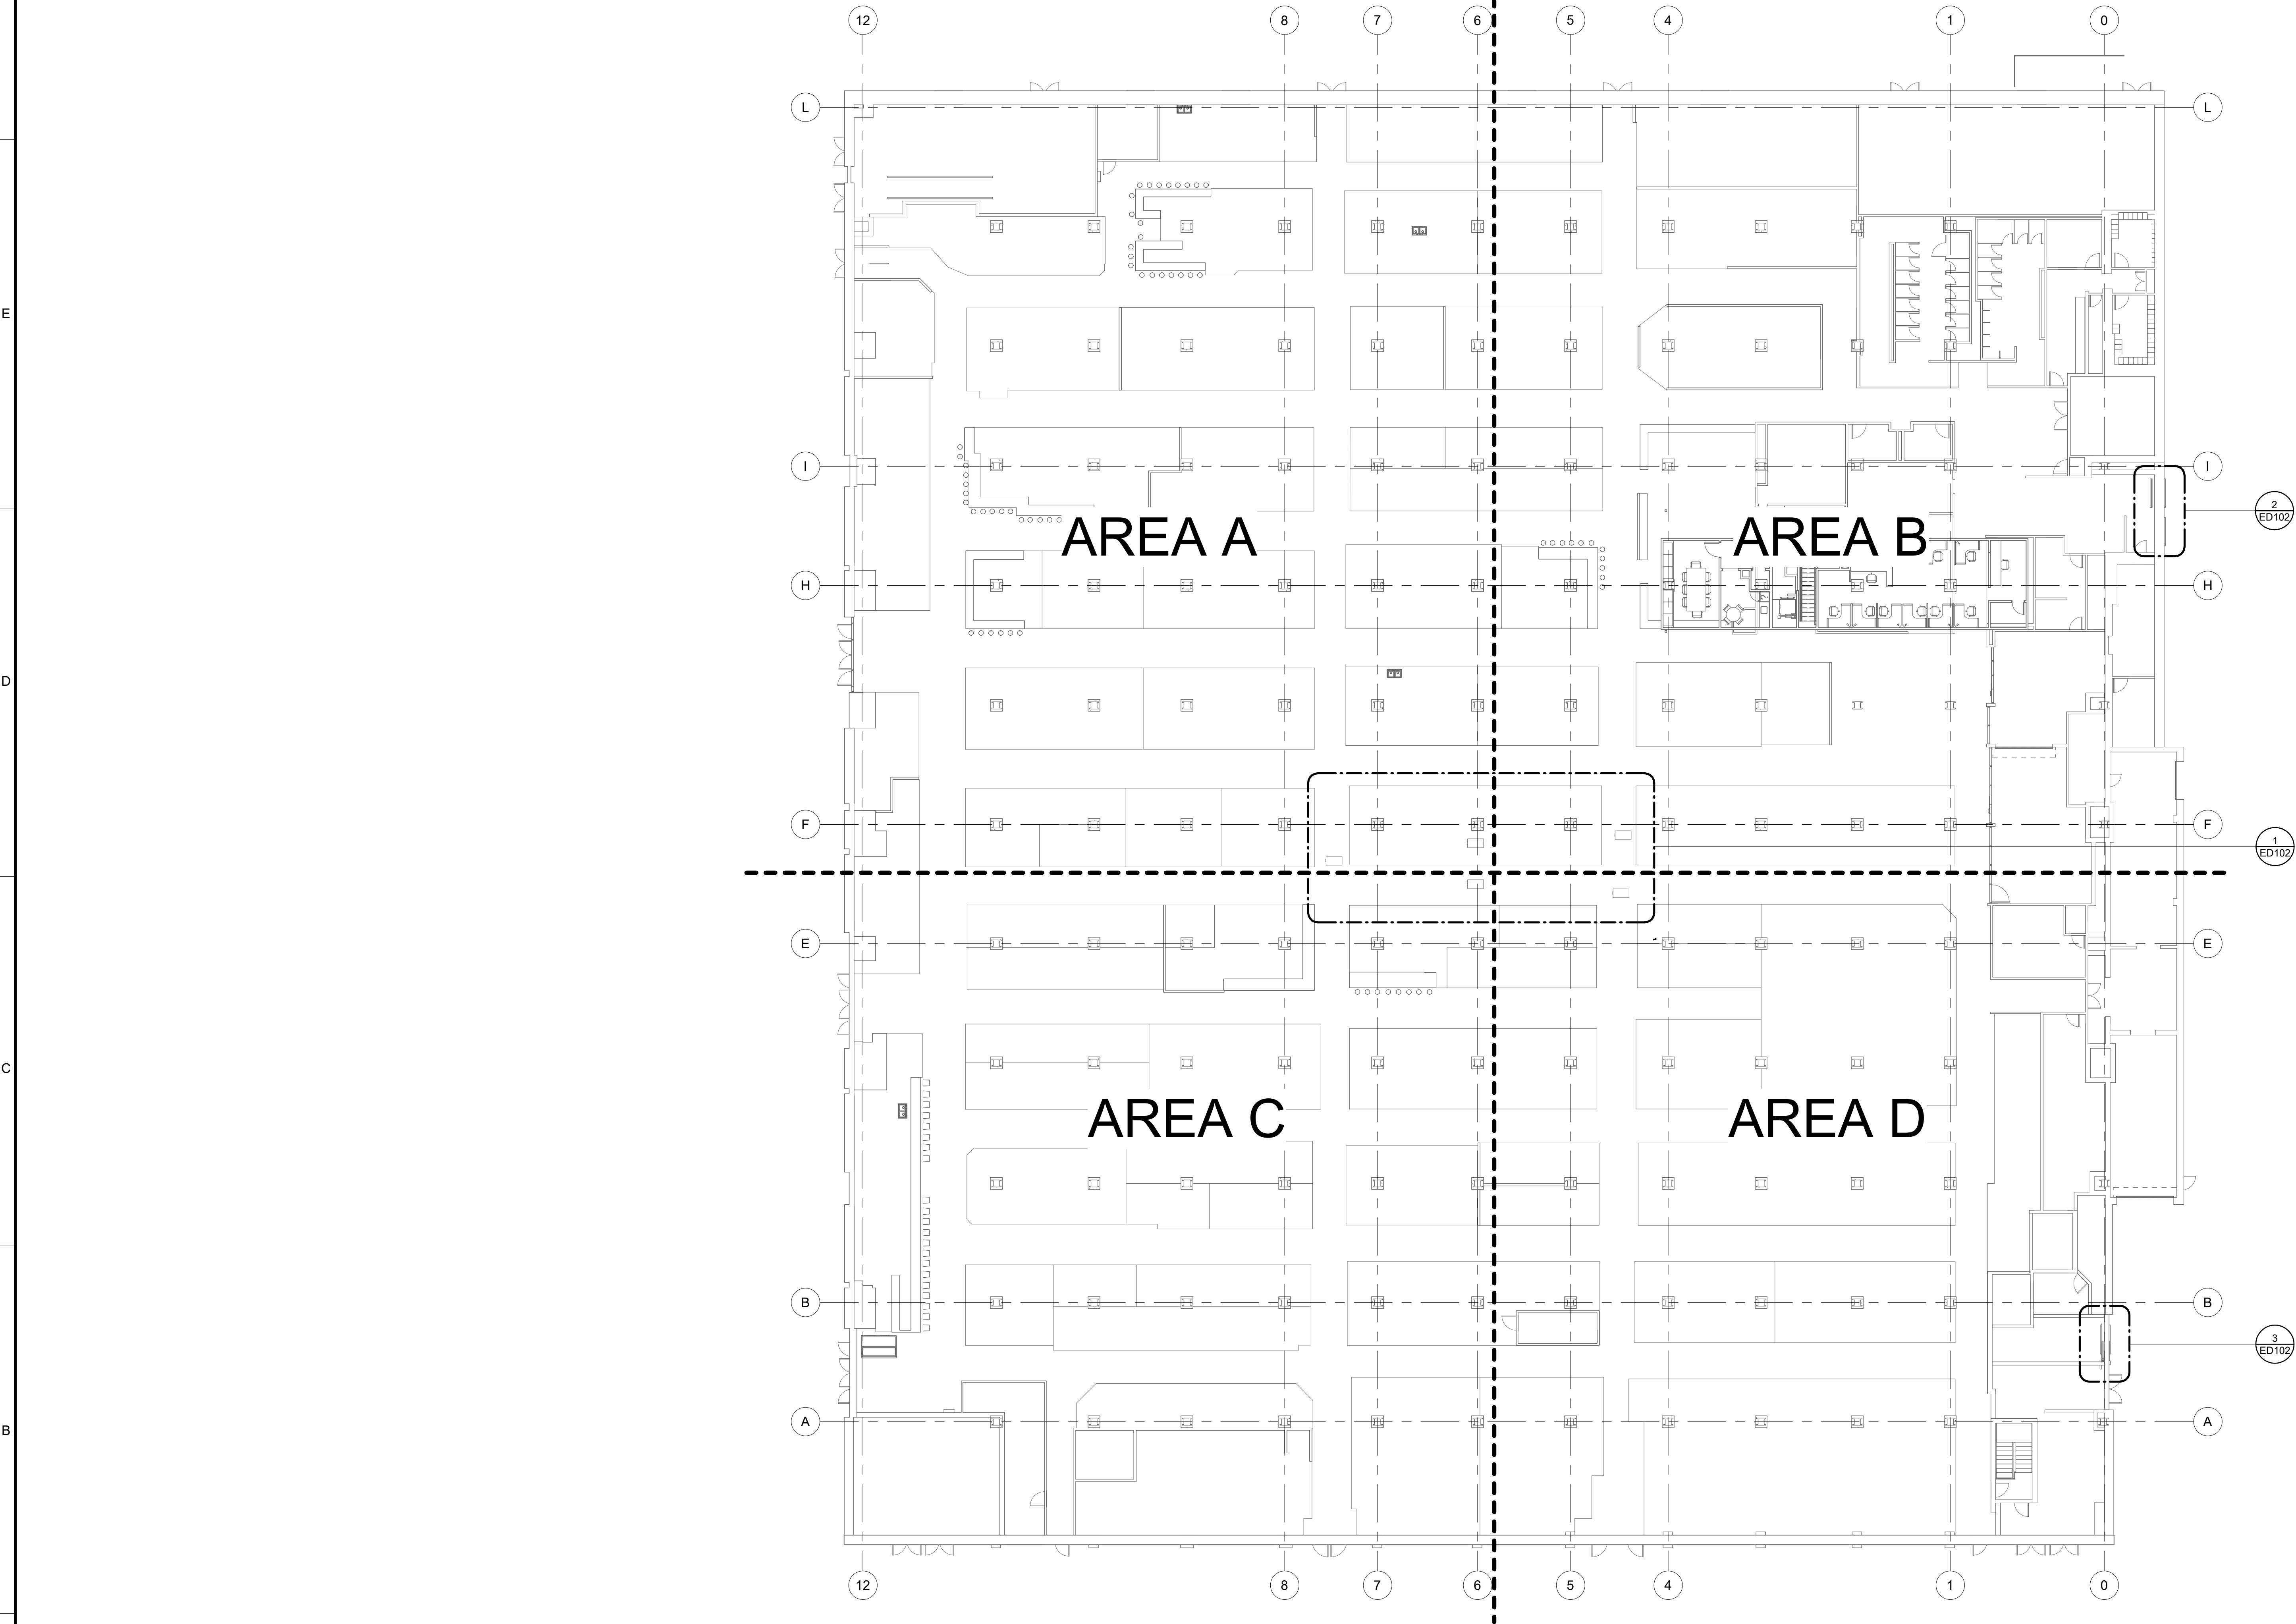
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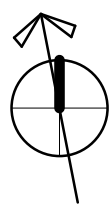
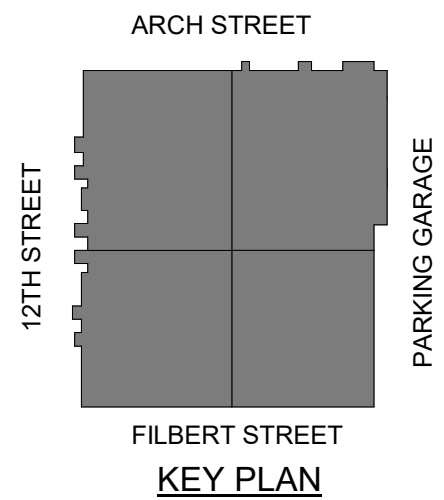
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GENERAL PACKAGE		
PROJECT NUMBER: 071274		
DESIGNED: FJR	MODELED: FJR	CHECKED: RLP
DATE: 02/03/23		
DRAWING TITLE: ELECTRICAL GENERAL NOTES, SYMBOLS & ABBREVIATIONS		
DRAWING NO.: E001		

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Project Number: 071274
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1 ELECTRICAL DEMOLITION OVERALL PLAN
SCALE: 1/16" = 1'-0"



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071274

DESIGNED:	MODELED:	CHECKED:
Designer	Author	Checker


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02/03/23

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GROUND FLOOR
DEMOLITION OVERALL
PLAN


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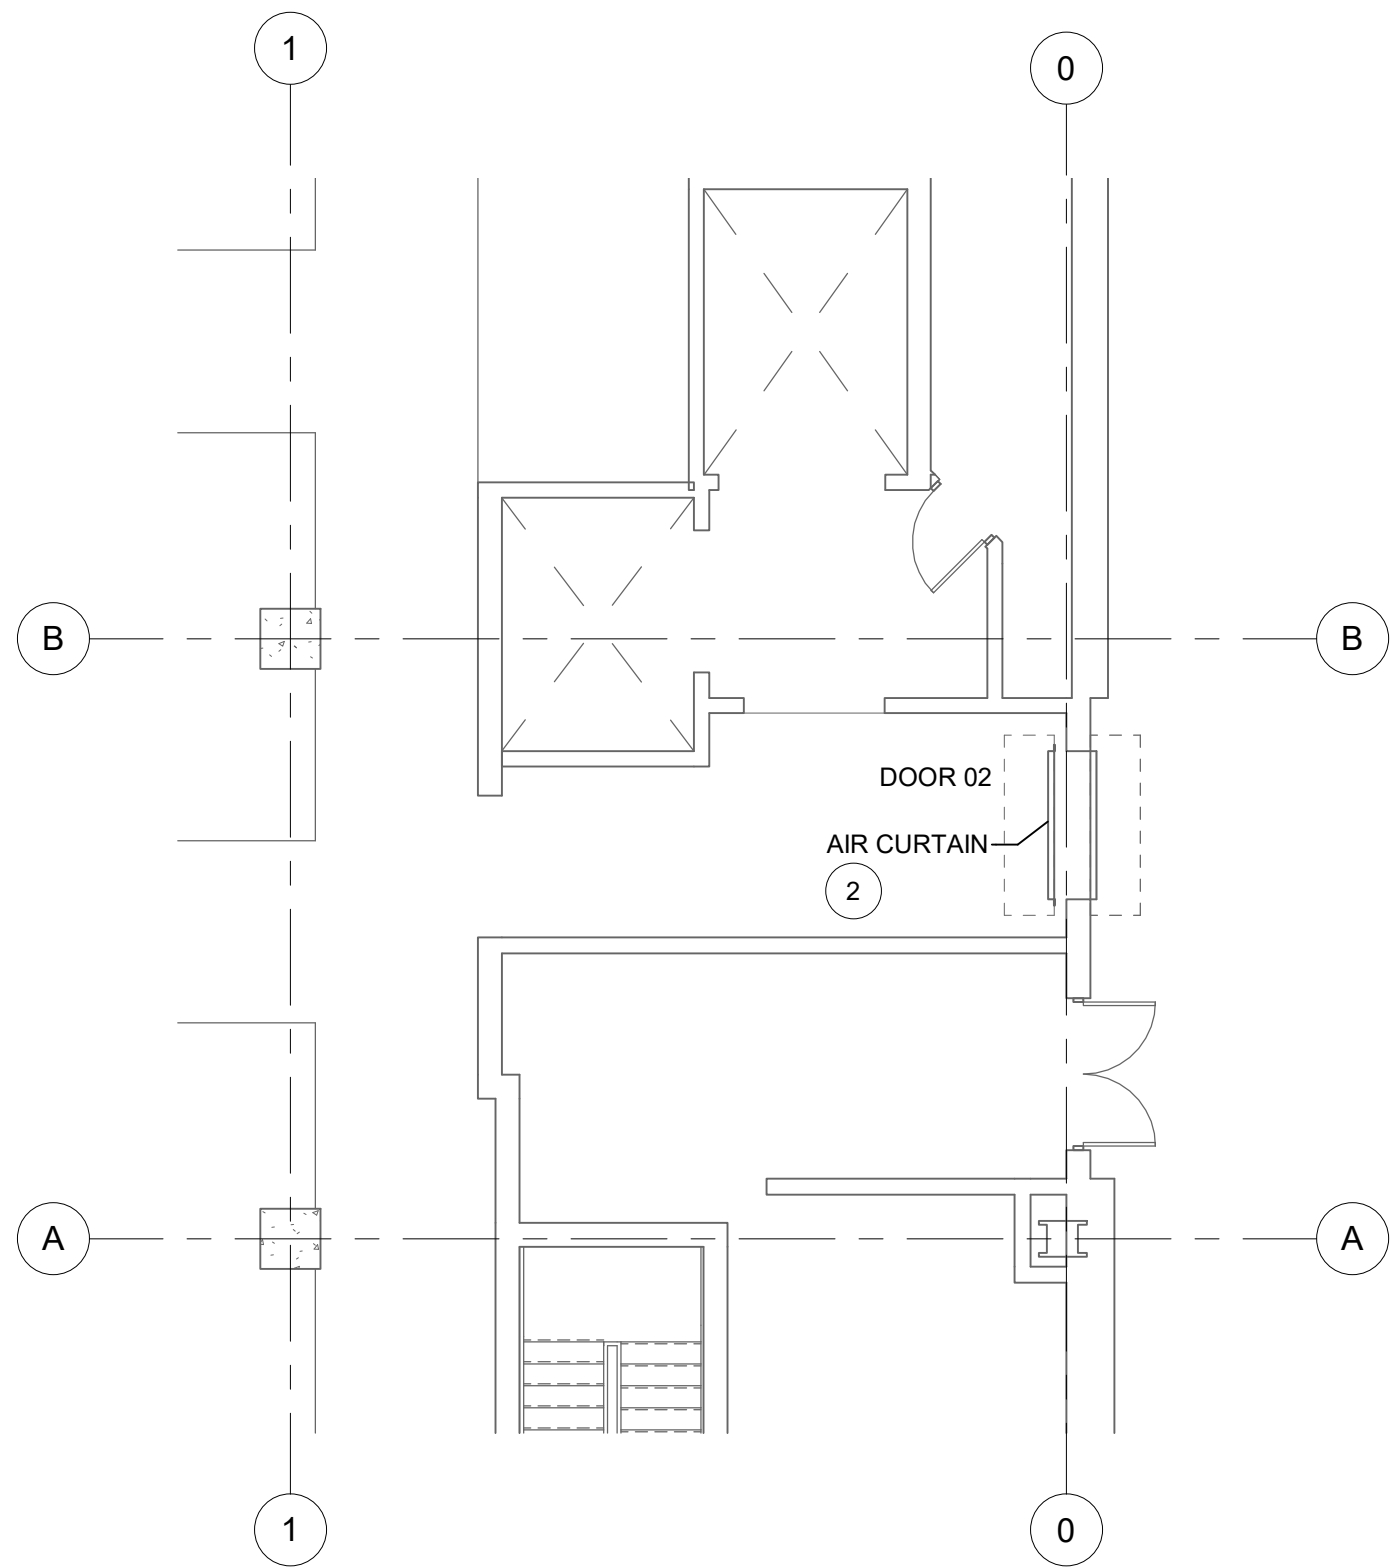
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Project Number: 071274
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1 ELECTRICAL GROUND FLOOR DEMOLITION ENLARGED PLAN
SCALE: 1/4" = 1'-0"



2 ELECTRICAL ENLARGED DEMOLITION PLAN - AREA B (AIR CURTAIN)
SCALE: 1/8" = 1'-0"

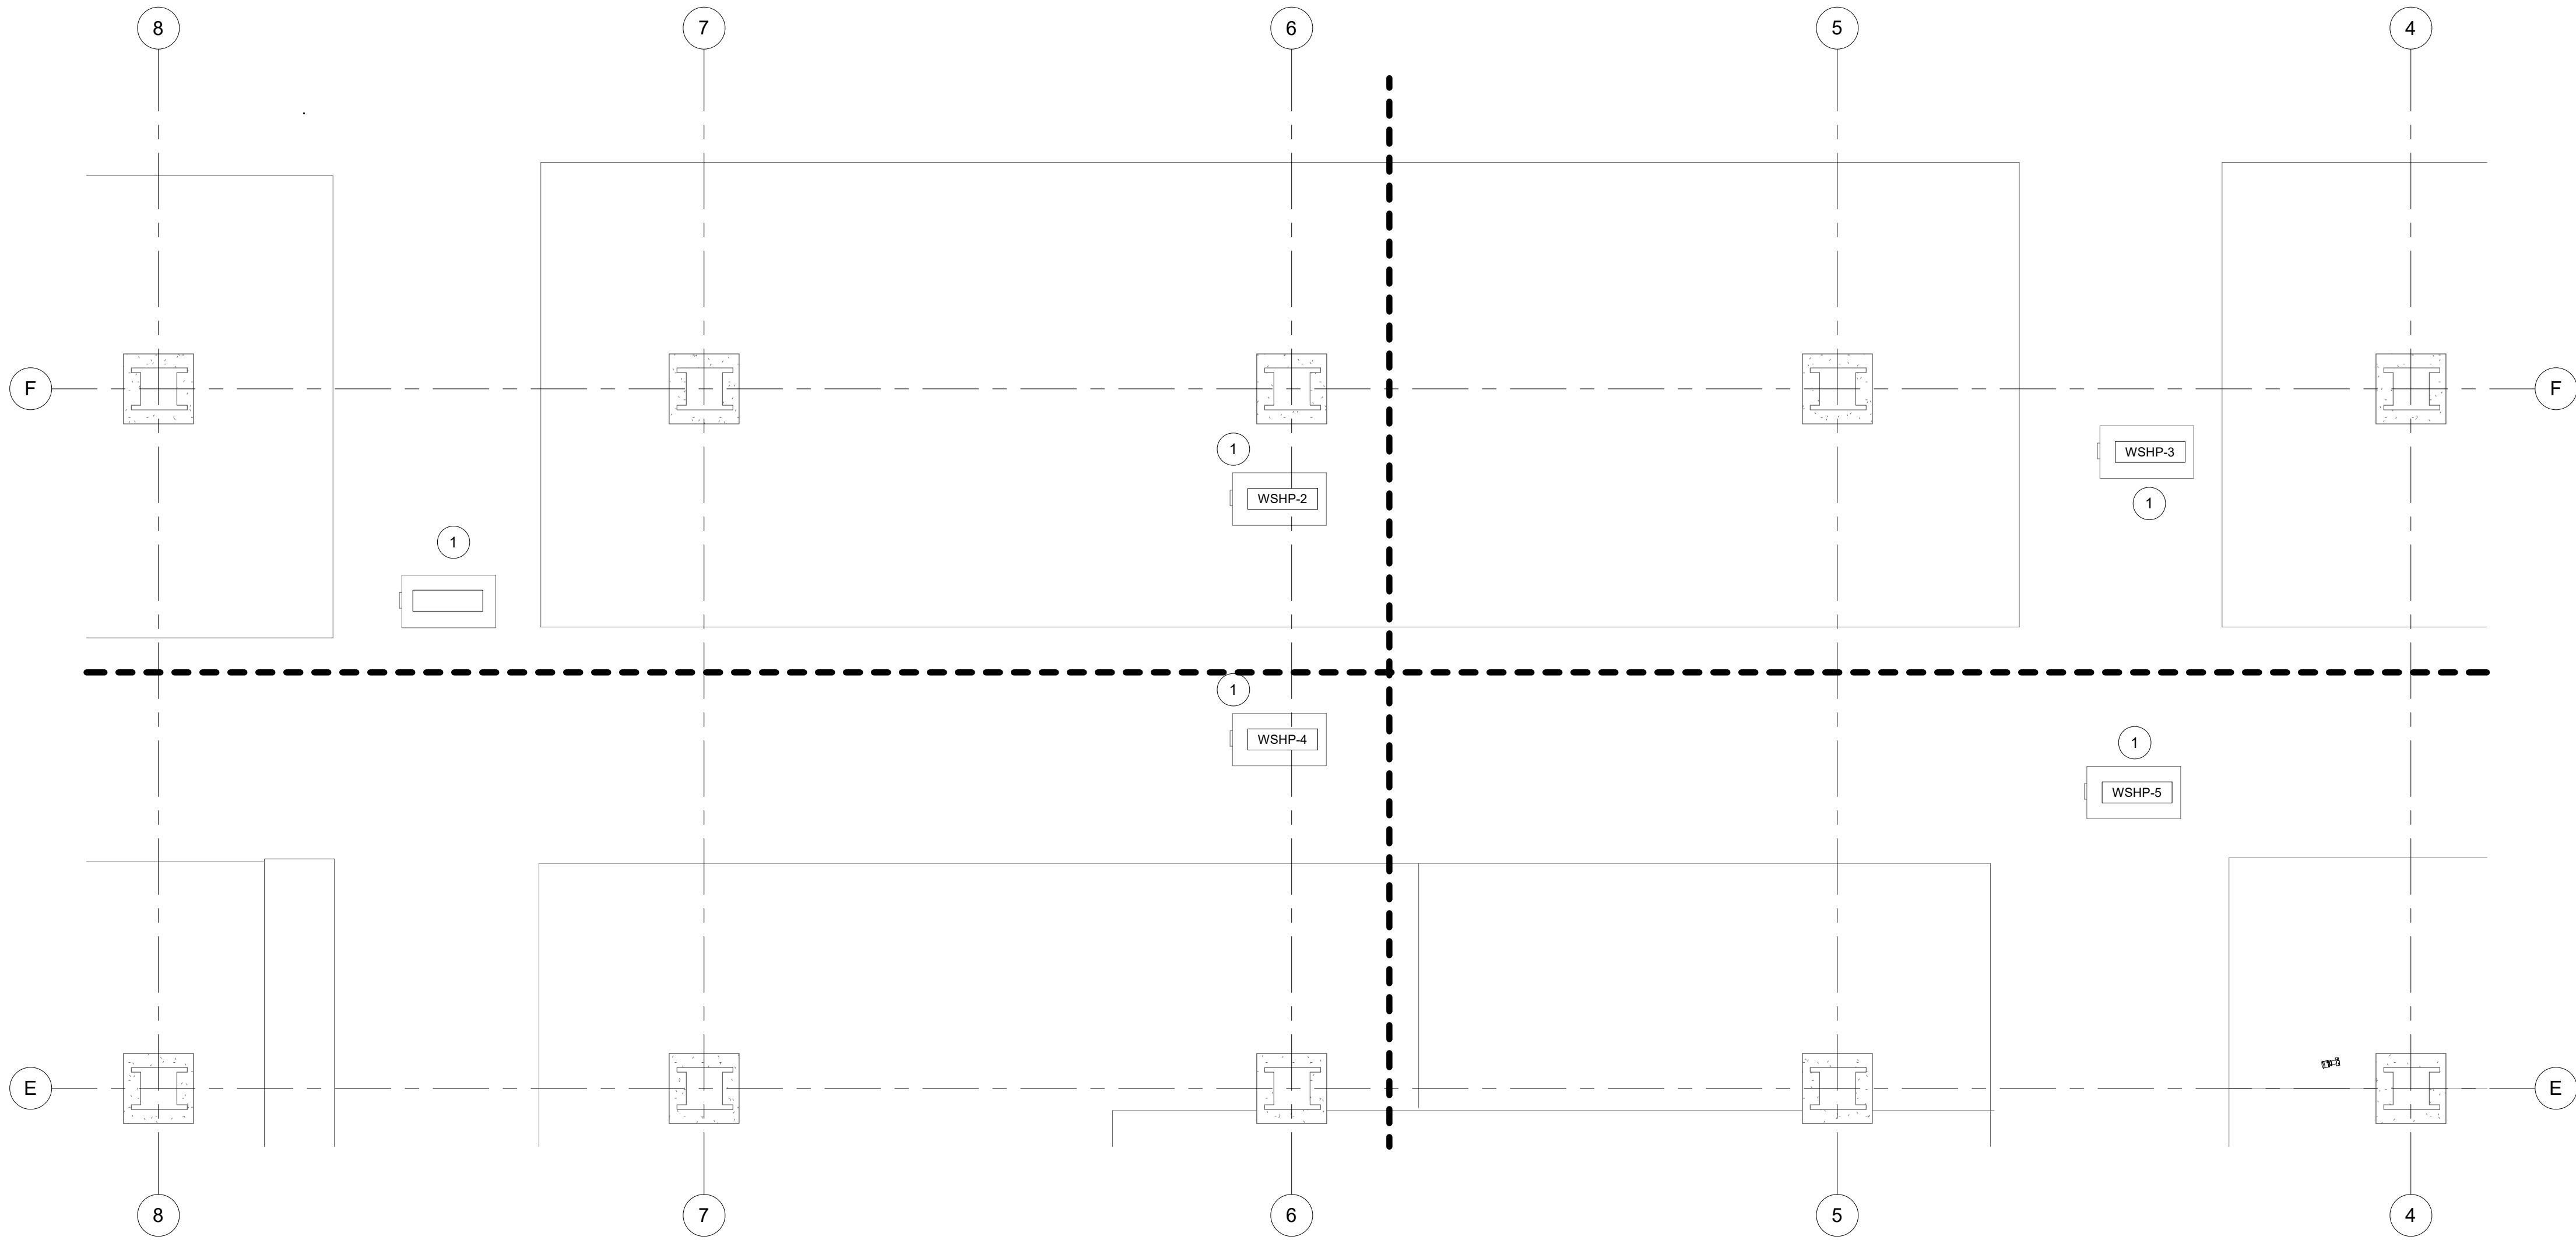




3 ELECTRICAL ENLARGED DEMOLITION PLAN - AREA D (AIR CURTAIN)
SCALE: 1/8" = 1'-0"

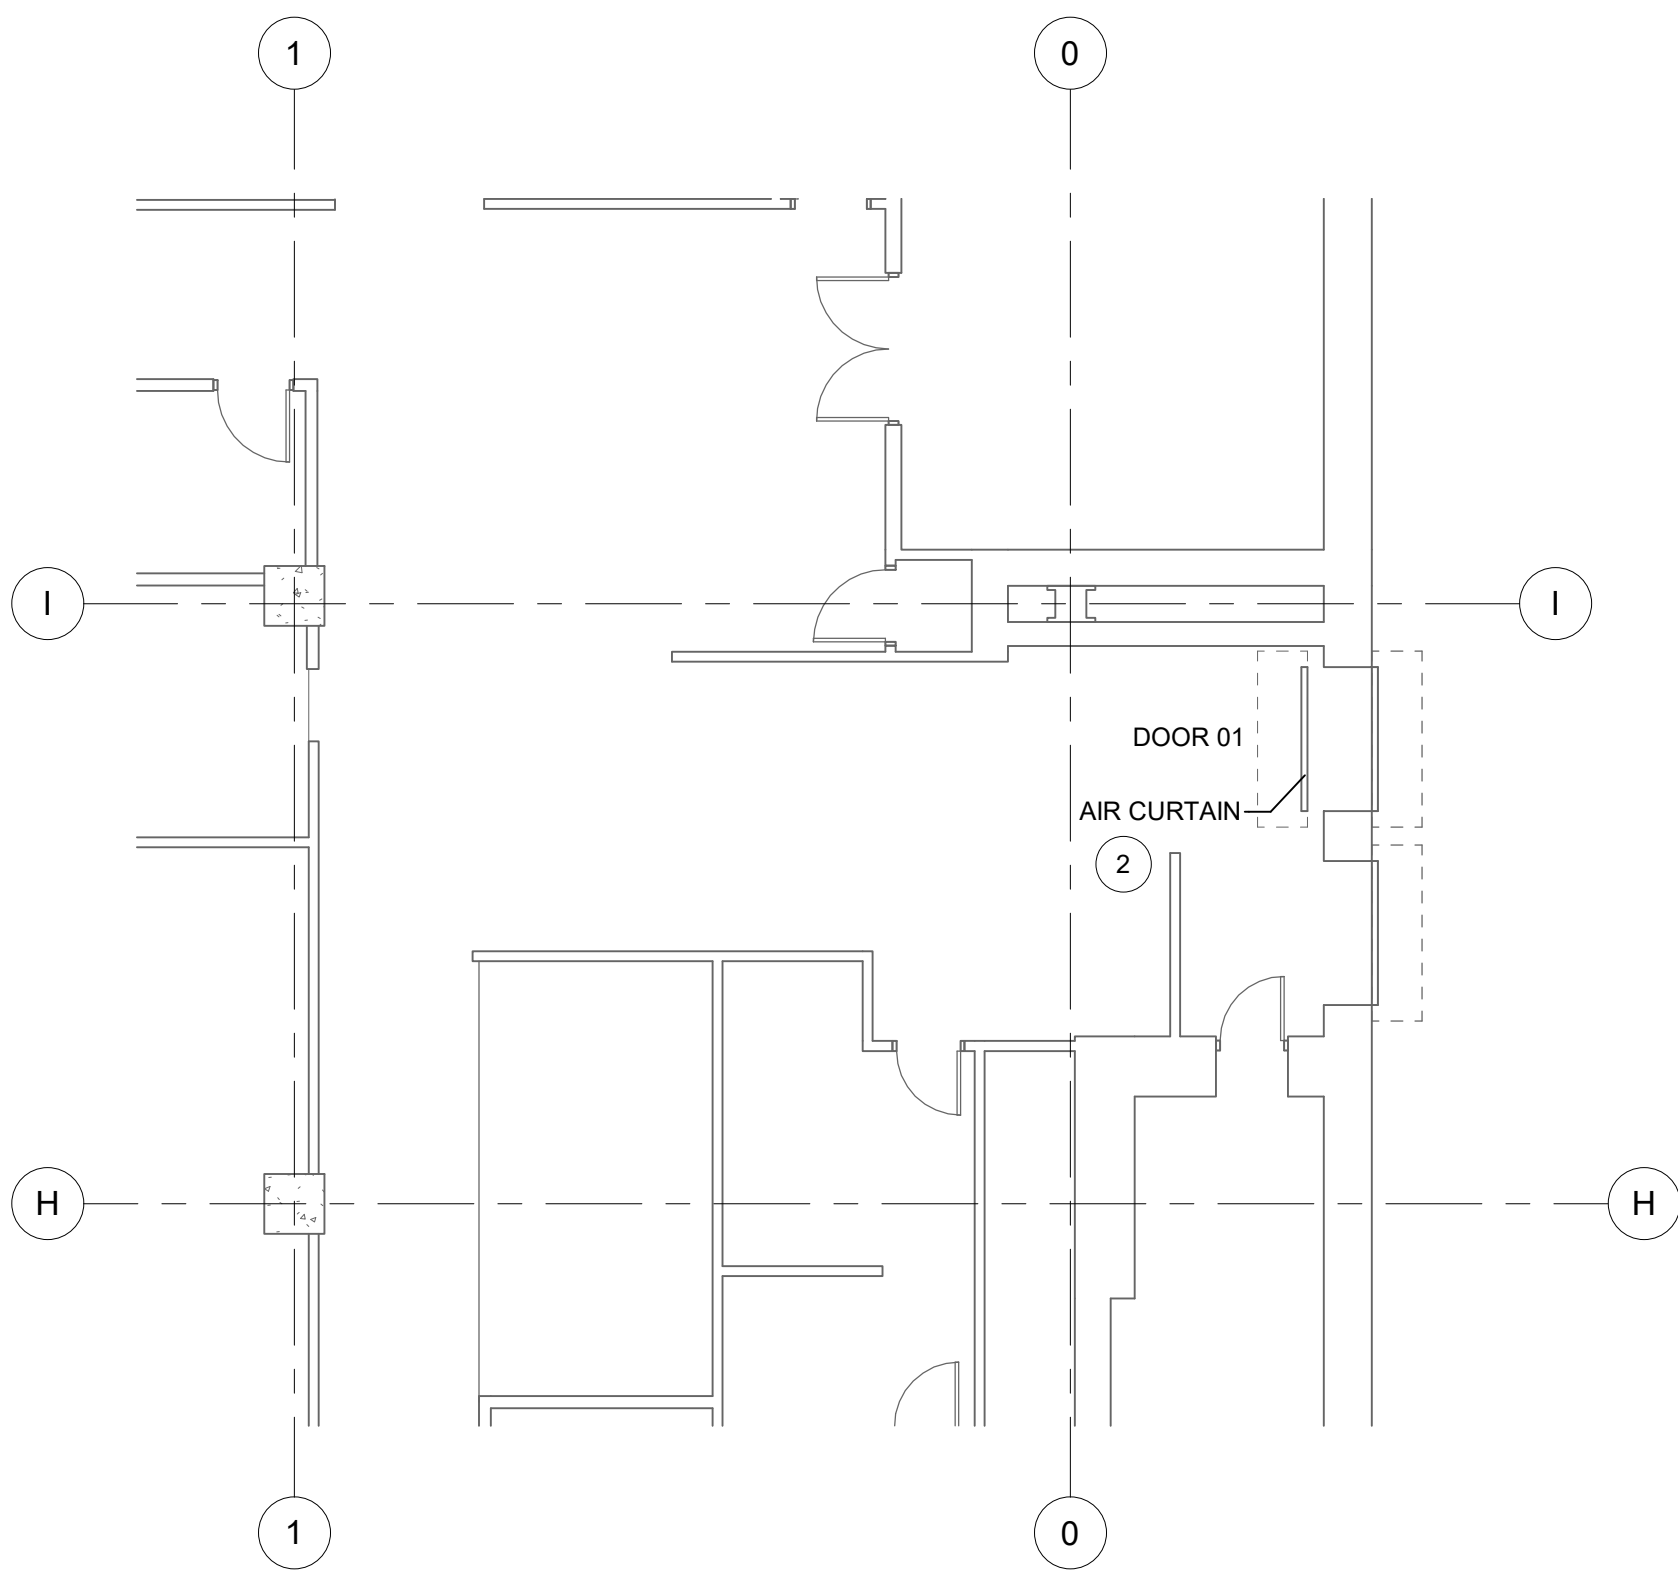GENERAL DEMOLITION NOTES

- SEE ELECTRICAL DRAWING E001 FOR GENERAL NOTES AND PROJECT INFORMATION.
- NOTES AND GRAPHIC REPRESENTATIONS SHALL NOT LIMIT THE EXTENT OR DEMOLITION REQUIRED. CONTRACTOR SHALL VISIT THE SITE, CAREFULLY EXAMINE EXISTING CONDITIONS AND SHALL PERFORM ALL DEMOLITION REQUIRED TO ACHIEVE THE FINAL DESIGN INTENT AS REQUIRED BY THE CONTRACT DOCUMENTS. EXTENT OF ALL DEMOLITION WORK SHALL BE COORDINATED WITH THE OWNER & ENGINEER.
- ALL WORK REQUIRED TO REMAIN IN SERVICE BUT INTERFERING WITH THE ALTERATIONS SHALL BE RELOCATED AND RECONNECTED USING MATERIALS AND STANDARDS OF THIS CONTRACT.
- EQUIPMENT AND WIRING TO BE REMOVED SHALL BE DE-ENERGIZED PRIOR TO ANY DEMOLITION WORK.
- EQUIPMENT INDICATED TO BE REMOVED SHALL BE TAKEN FROM THE SITE AND DISPOSED OF IN ACCORDANCE WITH APPLICABLE LAWS AND ENVIRONMENTAL REGULATIONS. EQUIPMENT REQUIRED TO BE TURNED OVER TO THE OWNER, SHALL BE PLACED IN A MUTUALLY ACCEPTED LOCATION.
- PROCEDURE FOR FEEDERS AND BRANCH CIRCUITS TO BE REMOVED: CONDUIT AND SUPPORTS SHALL BE REMOVED TO THE PANEL OF ORIGIN OR THE BOUNDARY OF THE PROJECT AREA. WIRING SHALL BE REMOVED TO THE PANEL OF ORIGIN WHERE EMPTY CONDUITS REMAIN, INSTALL A PULL STRING AND IDENTIFY AT BOTH ENDS.
- PROCEDURE FOR FEEDERS AND BRANCH CIRCUITS TO BE RE-USED: REMOVE CONDUIT AND WIRING TO LOCATIONS WHICH AVOID CONFLICTS WITH NEW WORK. INSTALL JUNCTION BOXES, TAPE OFF CONDUCTORS AND IDENTIFY WITH PANEL AND CIRCUIT NUMBER.
- WHERE PORTIONS OF EXISTING BRANCH CIRCUITS ARE REMOVED, MAINTAIN THE CONTINUITY OF CIRCUITING TO REMAINING DEVICES.
- PROVIDE BLANK COVER PLATES AT OPEN BOXES WHERE EXISTING RECEPTACLES OR ELECTRICAL DEVICES ARE REMOVED FROM ENCLOSURES OR SURFACES NOT INDICATED TO BE REPAIRED OR REFINISHED.
- PROVIDE ADDITIONAL SUPPORT FOR ALL EXISTING CONDUITS, LOW VOLTAGE CABLING AND DEVICES TO REMAIN WHICH ARE AFFECTED BY DEMOLITION OF EXISTING CEILINGS AND PARTITIONS.
- ALL WORK SHALL BE PROPERLY IDENTIFIED AFTER DEMOLITION. UPDATE ALL PANEL SCHEDULES TO REFLECT EQUIPMENT AND CIRCUIT REMOVALS.

DEMOLITION SHEET KEYNOTES

- DISCONNECT EXISTING WATER SOURCE HEAT PUMP (WSHP). REMOVE EXISTING CIRCUIT CONDUCTORS BACK TO SOURCE. WHERE NEW HVAC TERMINAL EQUIPMENT IS TO BE INSTALLED AT SAME LOCATION, EXISTING CONDUIT MAY BE REUSED TO THE EXTENT FEASIBLE. ALL UNUSED EXISTING CONDUIT SHALL BE REMOVED. EXISTING CIRCUIT TO BE REUSED.
- DISCONNECT EXISTING AIR CURTAIN. REMOVE EXISTING CIRCUIT CONDUCTORS BACK TO SOURCE. WHERE NEW EQUIPMENT IS TO BE INSTALLED AT SAME LOCATION, EXISTING CONDUIT MAY BE REUSED TO THE EXTENT FEASIBLE. ALL UNUSED EXISTING CONDUIT SHALL BE REMOVED. EXISTING CIRCUIT TO BE REUSED.

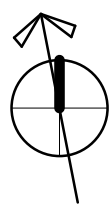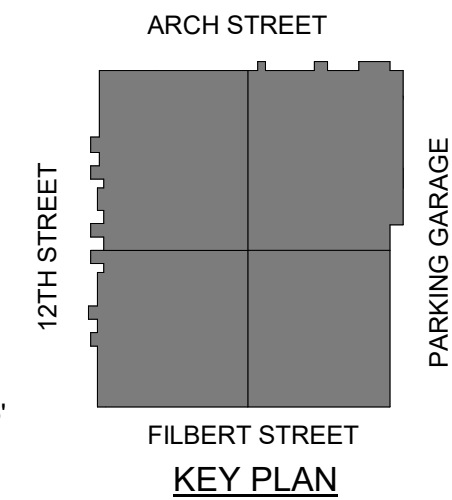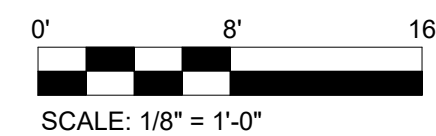

Gannett Fleming, Inc.

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www.gannettfleming.com



READING TERMINAL MARKET

51 N TWELFTH STREET, PHILADELPHIA PA, 19107

READING TERMINAL MARKET CAPITAL IMPROVEMENTS

NO.	DATE	DESCRIPTION
REVISIONS		

GENERAL PACKAGE

PROJECT NUMBER:
071274

DESIGNED:
FJR

MODELED:
FJR

CHECKED:
RLP




DATE:
02/03/23

DRAWING TITLE:
ELECTRICAL
GROUND FLOOR
ENLARGED DEMOLITION
PLANS

DRAWING NO.:

ED102

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Project Number: 071274
2/3/2023 8:47:52 AM

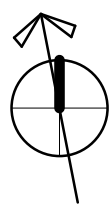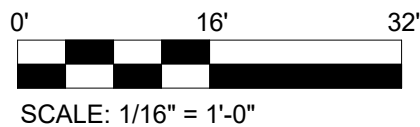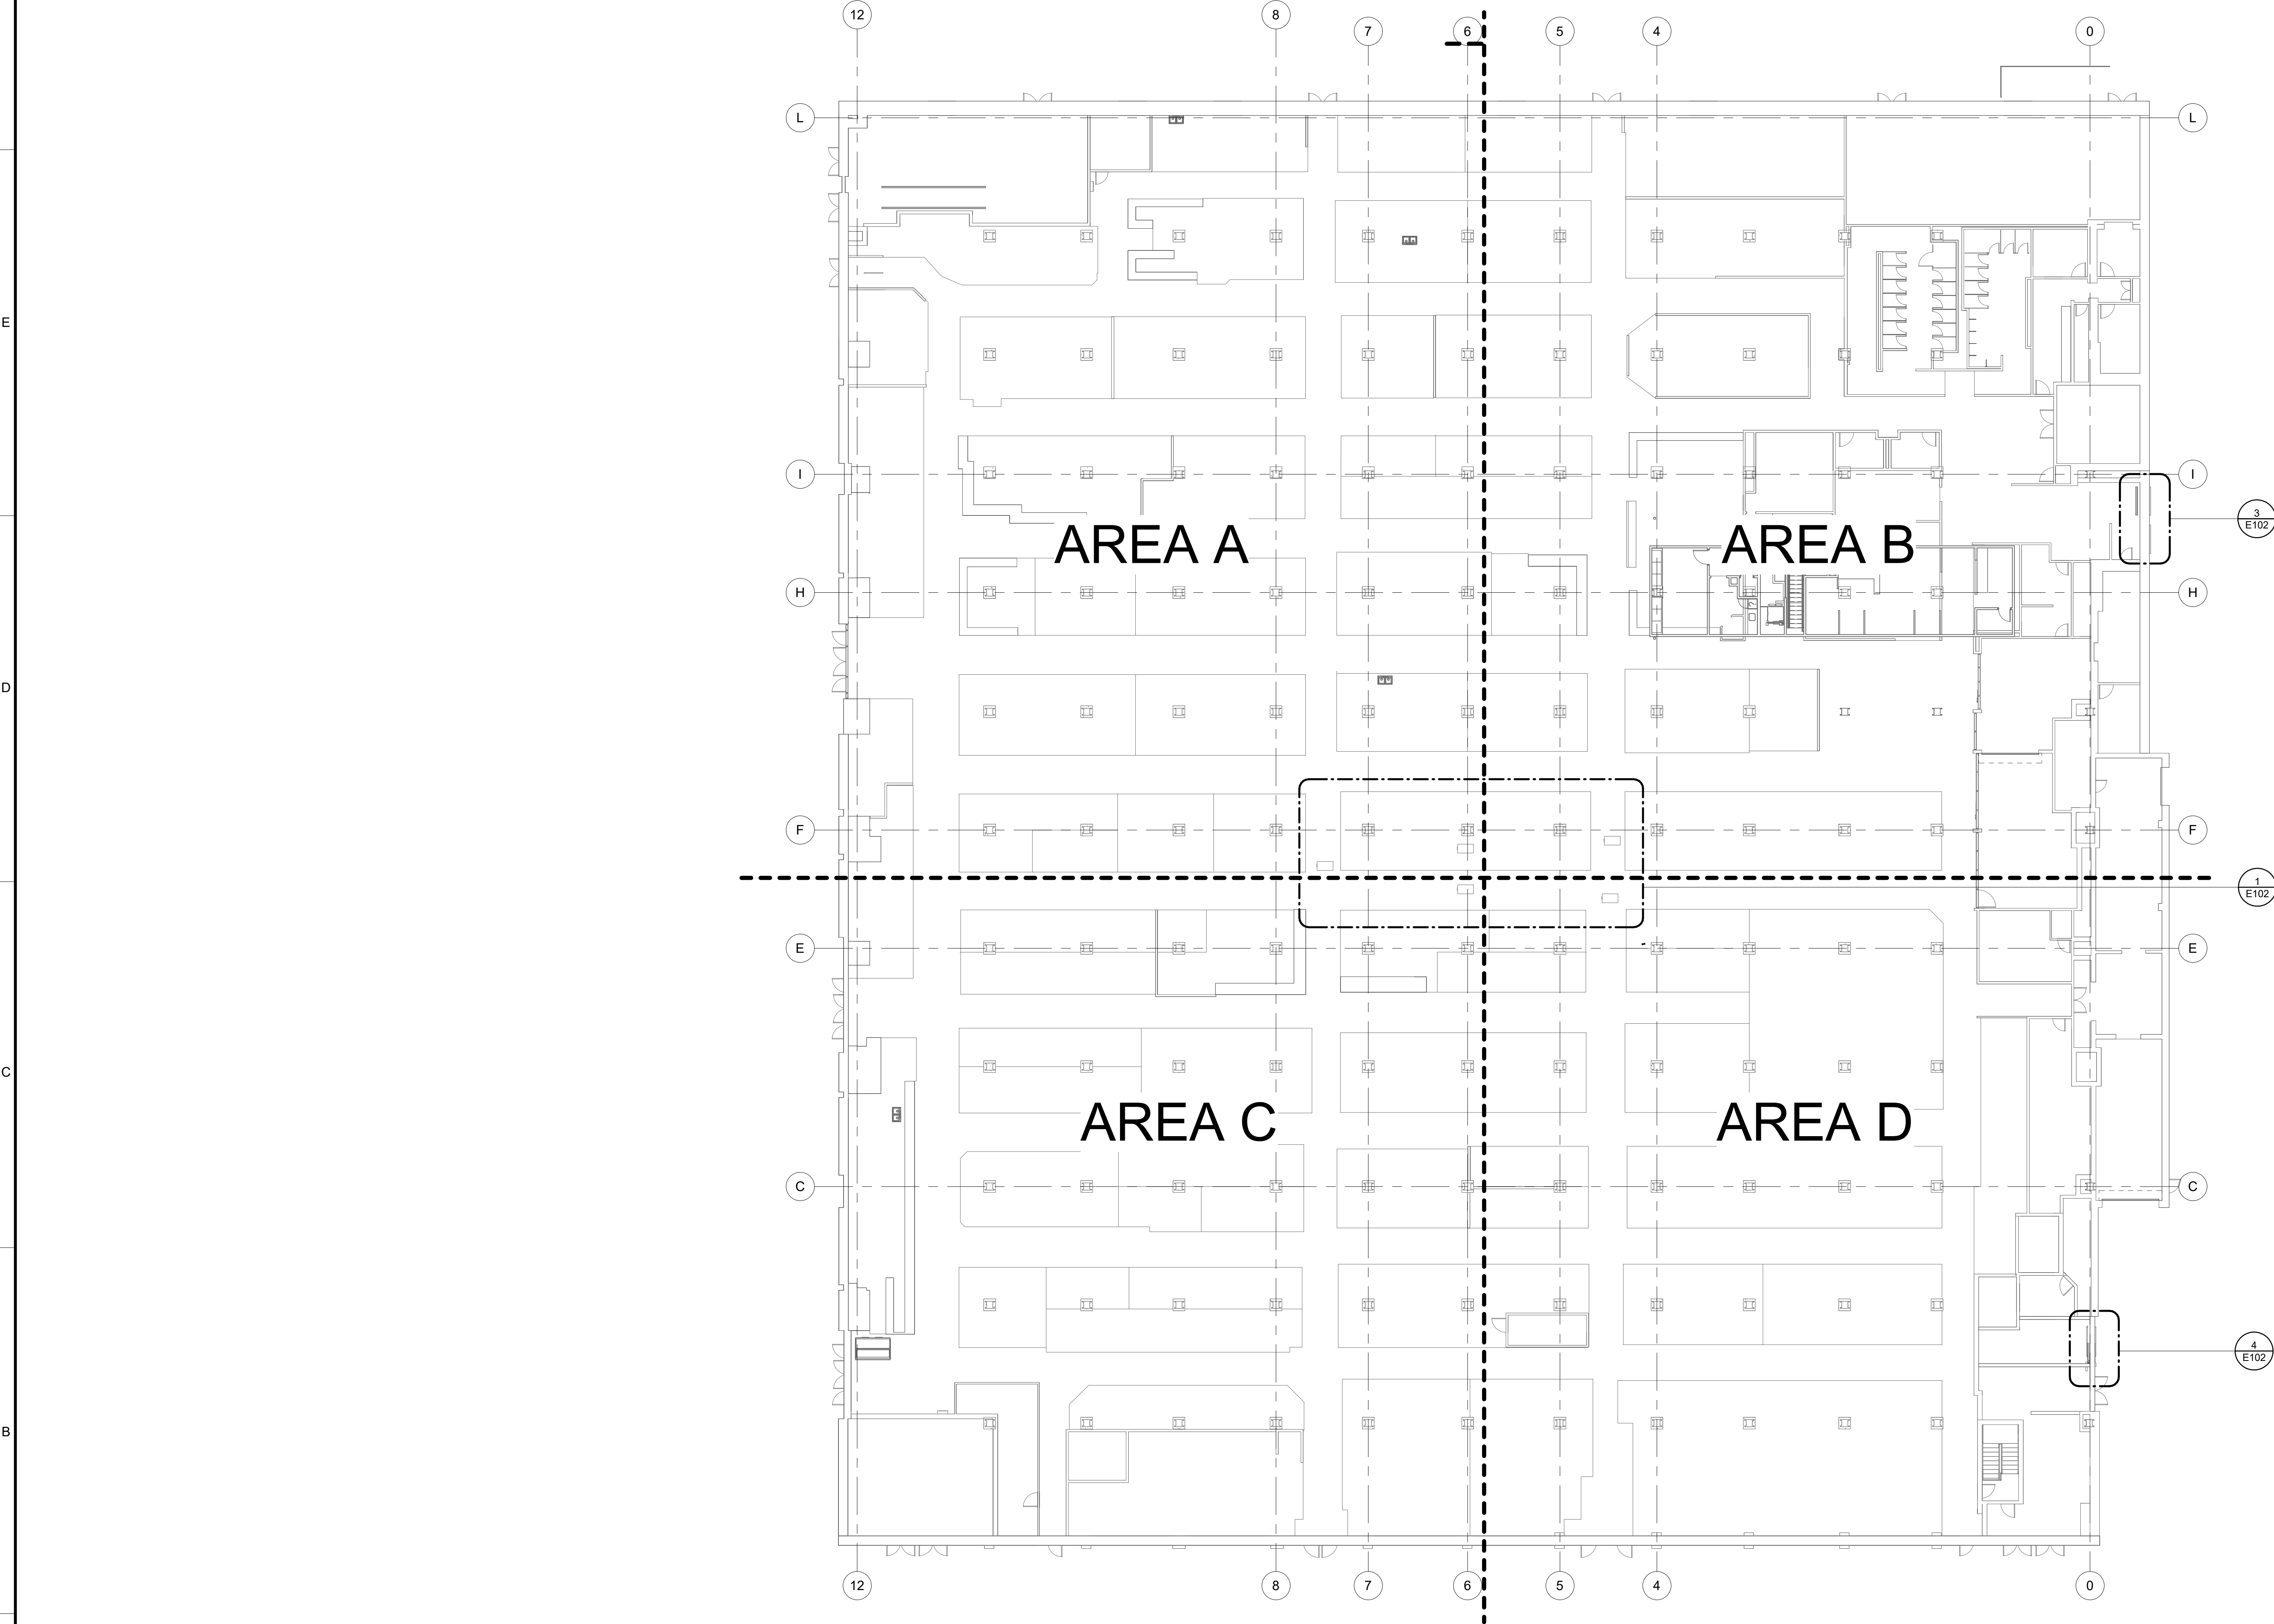

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READING TERMINAL MARKET

51 N TWELFTH STREET, PHILADELPHIA PA, 19107

READING TERMINAL MARKET CAPITAL IMPROVEMENTS

NO.	DATE	DESCRIPTION
REVISIONS		

GENERAL PACKAGE

PROJECT NUMBER: 071274		
DESIGNED: FJR	MODELED: FJR	CHECKED: RLP

DATE:
02/03/23

DRAWING TITLE:
ELECTRICAL
GROUND FLOOR
OVERALL PLAN

DRAWING NO.:
E101

1. REFER TO DRAWING E001 FOR GENERAL NOTES AND WIRING METHODS.
2. ALL ELECTRICAL EQUIPMENT SHOWN ON DRAWING IS NEW UNLESS NOTED OTHERWISE.

1. CONNECT NEW HEAT PUMP. REUSE EXISTING WIRING AND CONDUIT TO THE EXTENT FEASIBLE. EXTEND WIRING AND/OR CONDUIT AS NEEDED. REUSE EXISTING CIRCUIT.
2. CONNECT NEW AIR CURTAIN. REUSE EXISTING WIRING AND CONDUIT TO THE EXTENT FEASIBLE. EXTEND WIRING AND/OR CONDUIT AS NEEDED. REUSE EXISTING CIRCUIT. RELOCATE EXISTING CONDUITS, WIRING AND/OR EXISTING DEVICES THAT INTERFERE WITH THE NEW OVERHEAD DOOR ASSEMBLIES. COORDINATE WITH OWNER.

<p>READING TERMINAL MARKET</p> <p>51 N TWELFTH STREET, PHILADELPHIA PA, 19107</p>	<p>READING TERMINAL MARKET CAPITAL IMPROVEMENTS</p>
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READING TERMINAL MARKET

51 N TWELFTH STREET, PHILADELPHIA PA, 19107

READING TERMINAL MARKET CAPITAL IMPROVEMENTS

NO.	DATE	DESCRIPTION
REVISIONS		

PROJECT NUMBER:
071274

DESIGNED: FJR	MODELED: FJR	CHECKED: RLP
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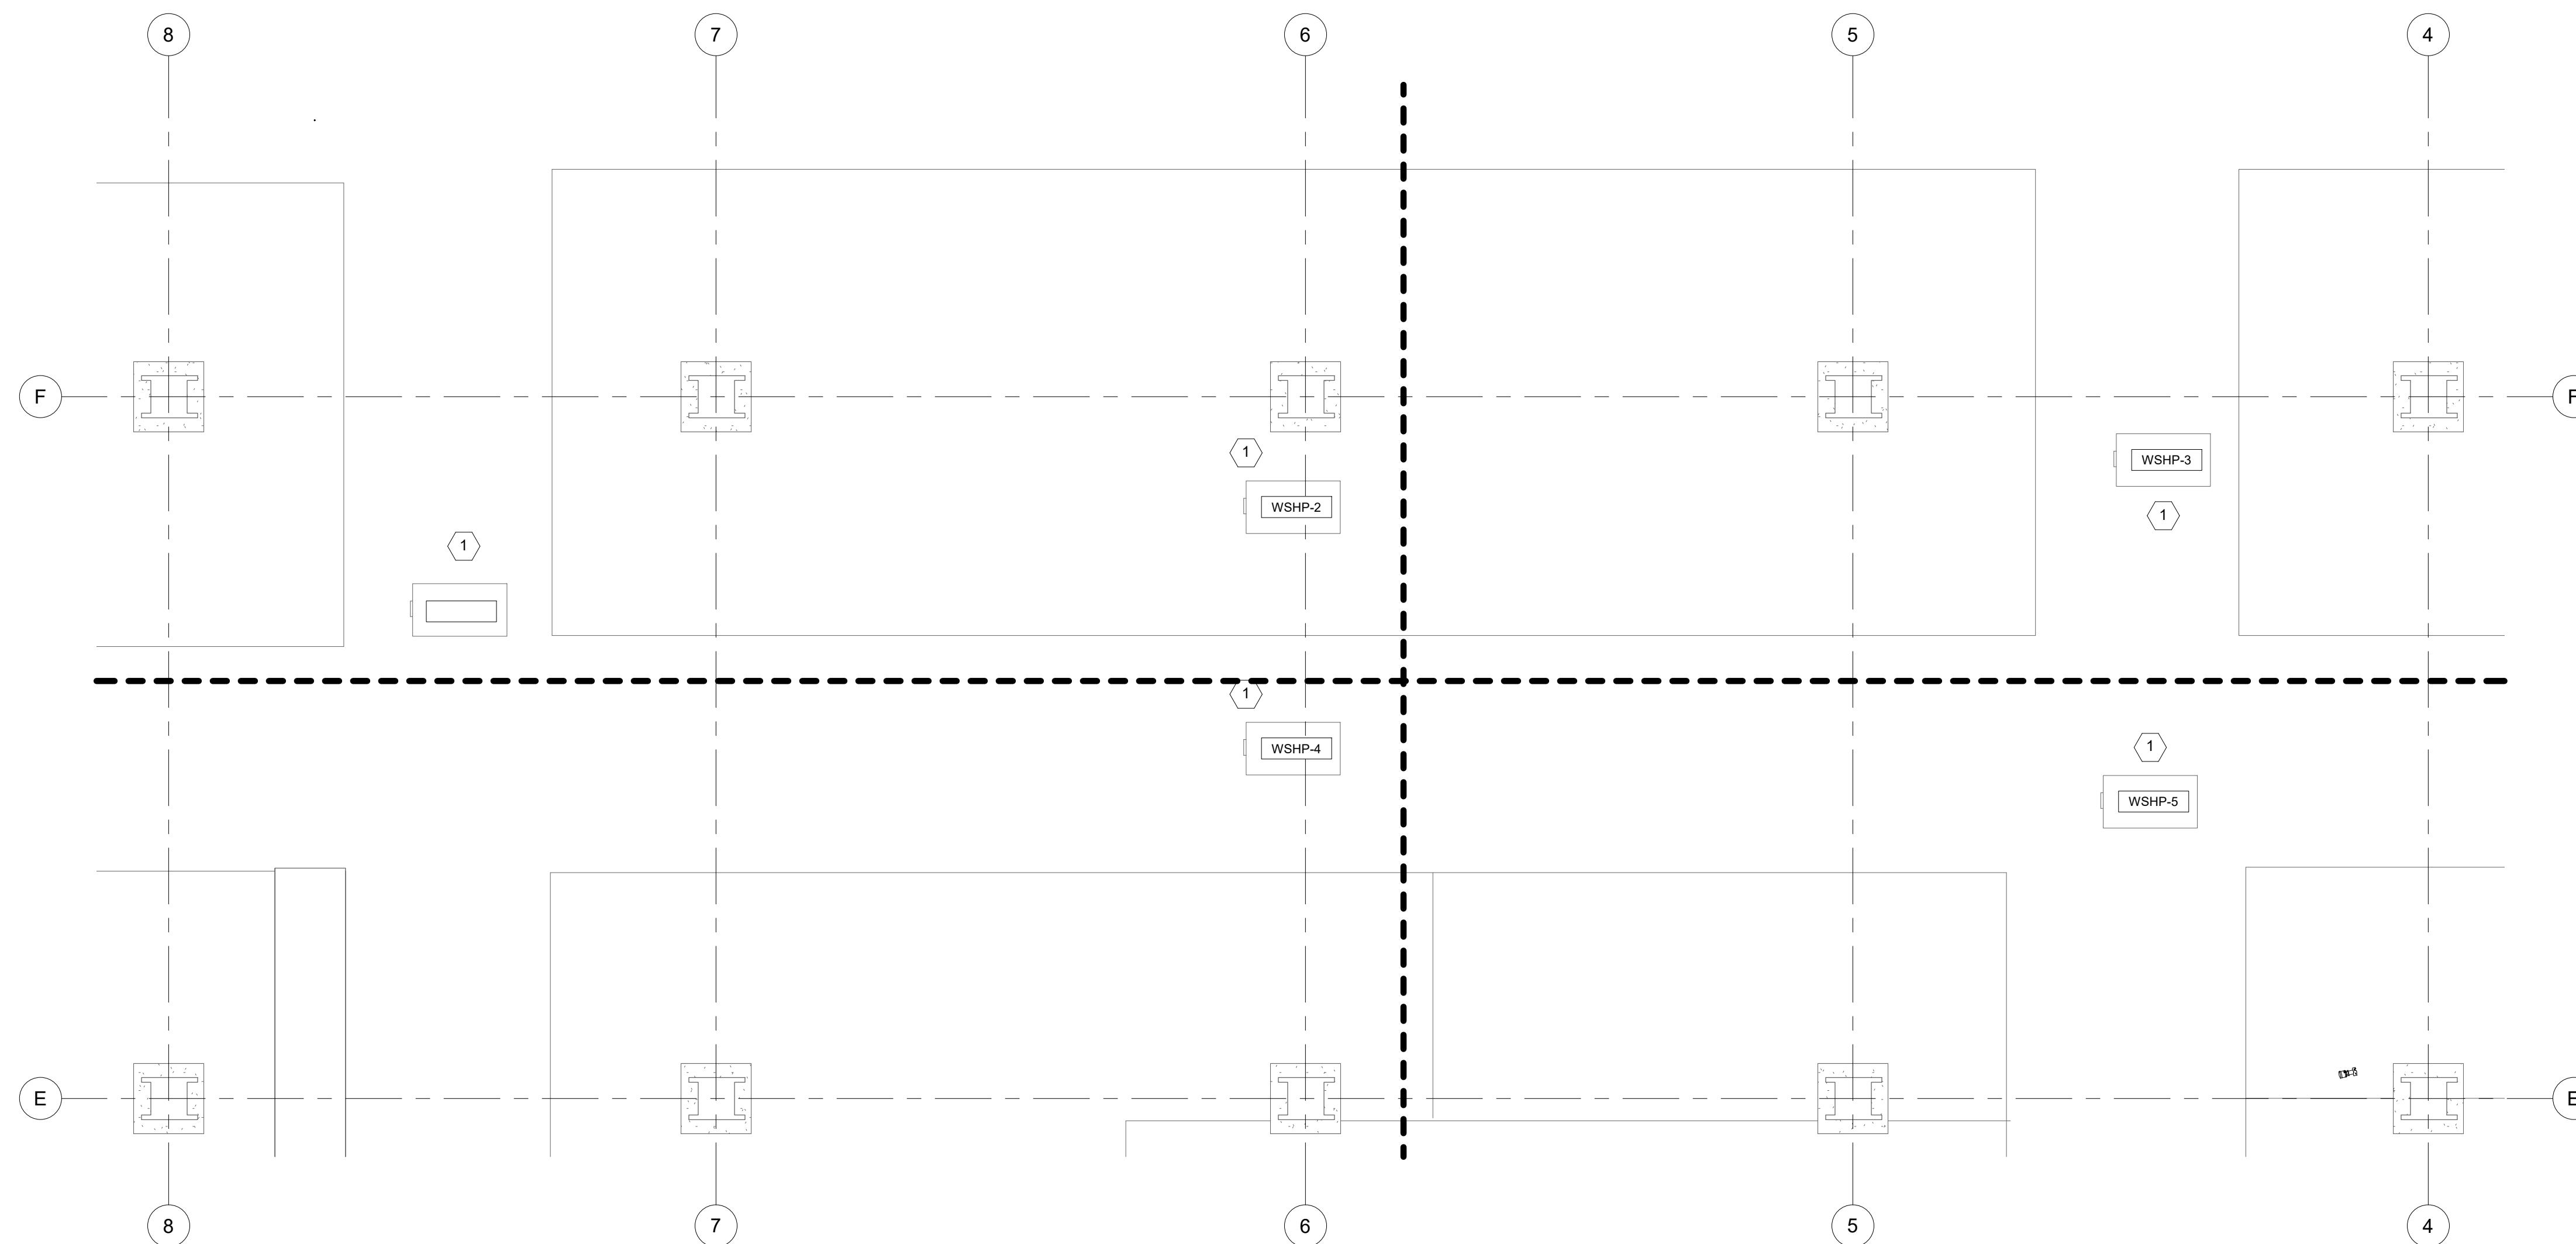
DATE:
02/03/23

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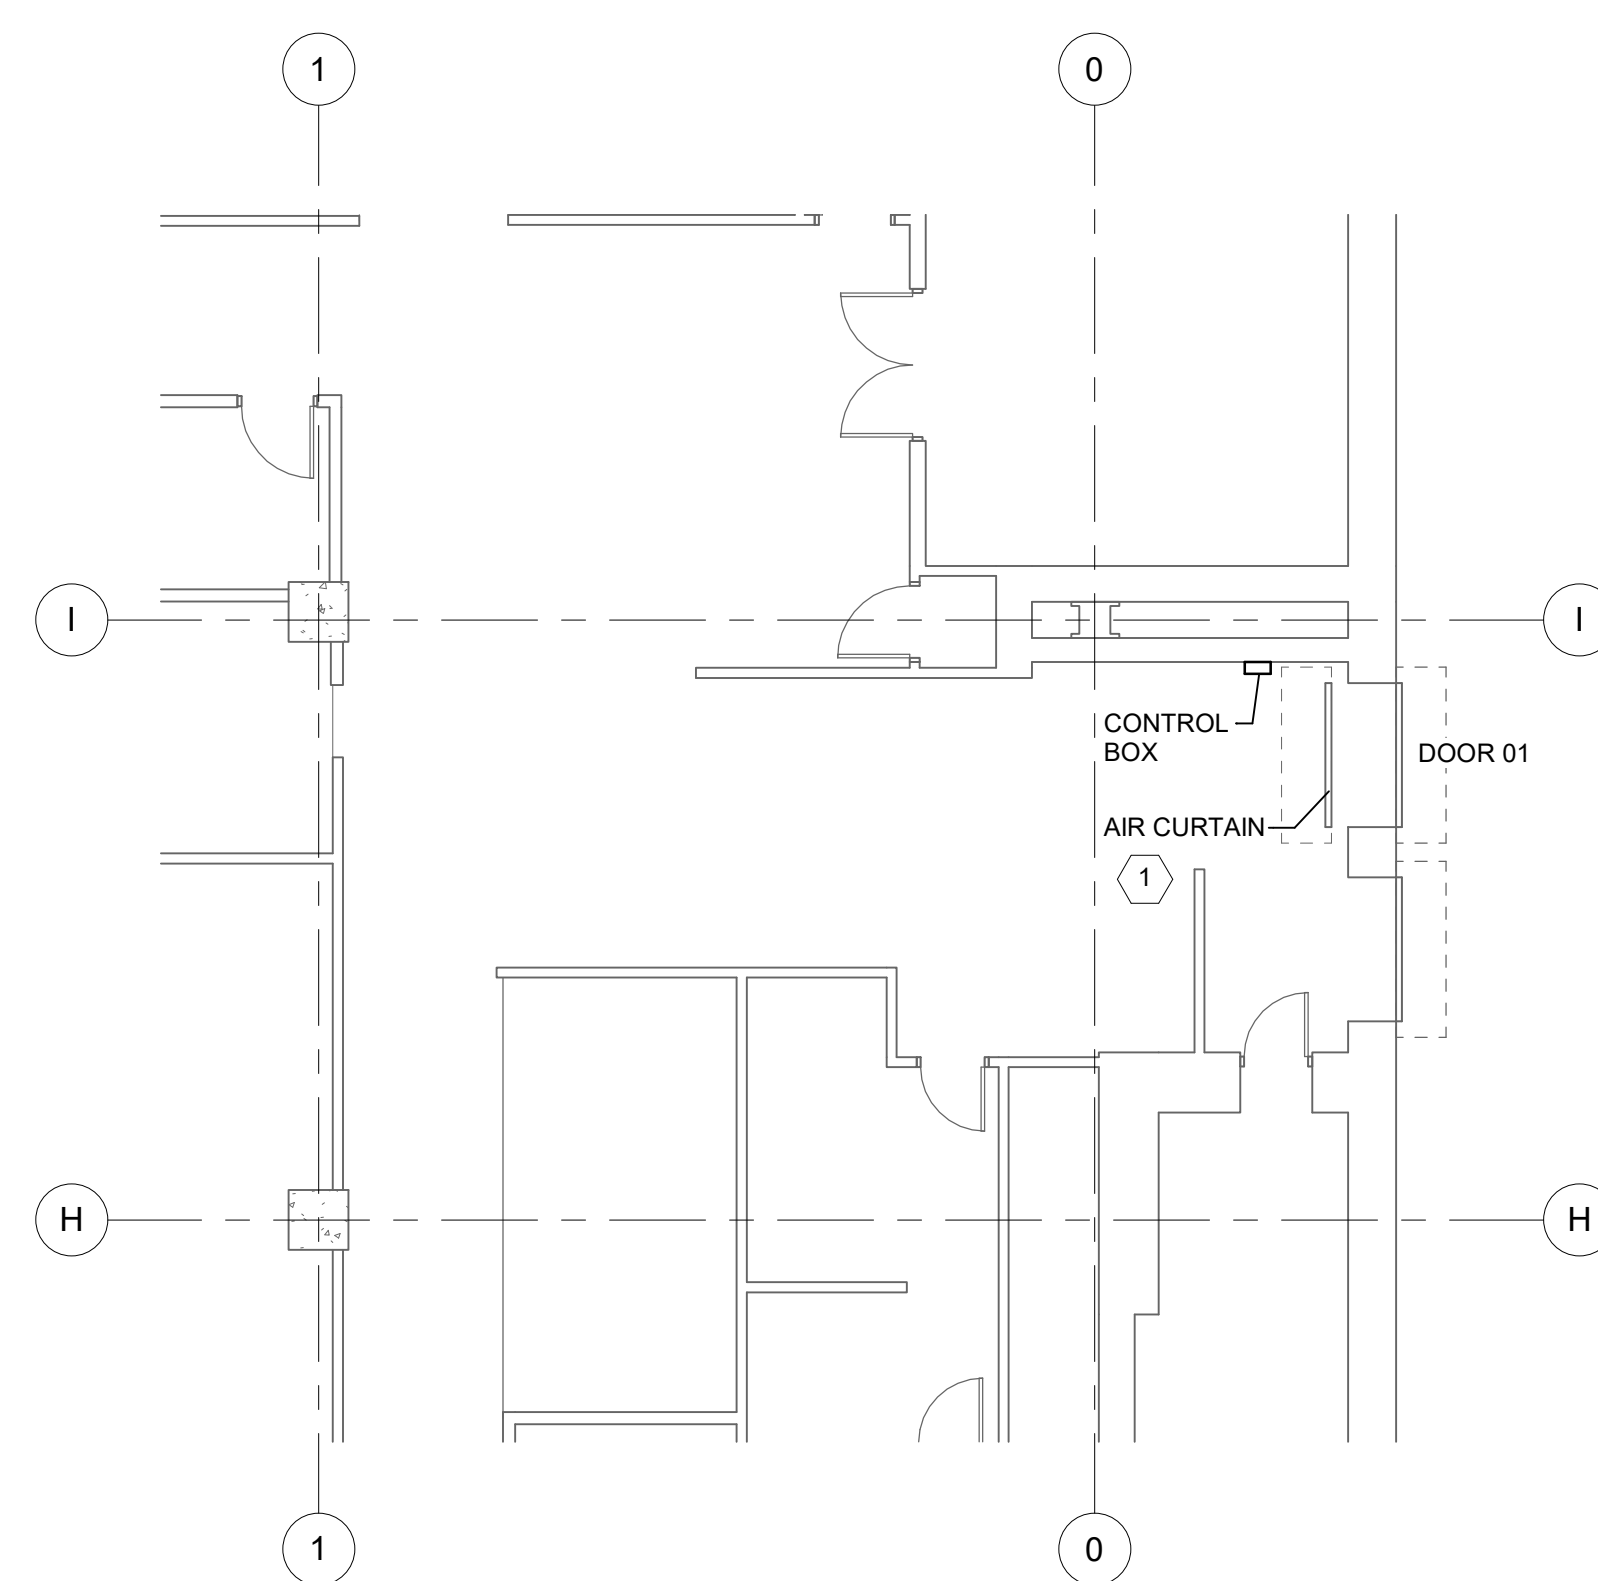
ELECTRICAL
GROUND FLOOR
ENLARGED NEW WORK
PLANS

DRAWING NO.:


E102






1 ELECTRICAL GROUND FLOOR NEW WORK ENLARGED PLAN
SCALE: 1/4" = 1'-0"



3 ELECTRICAL ENLARGED NEW WORK PLAN - AREA B (AIR CURTAIN)
SCALE: 1/8" = 1'-0"

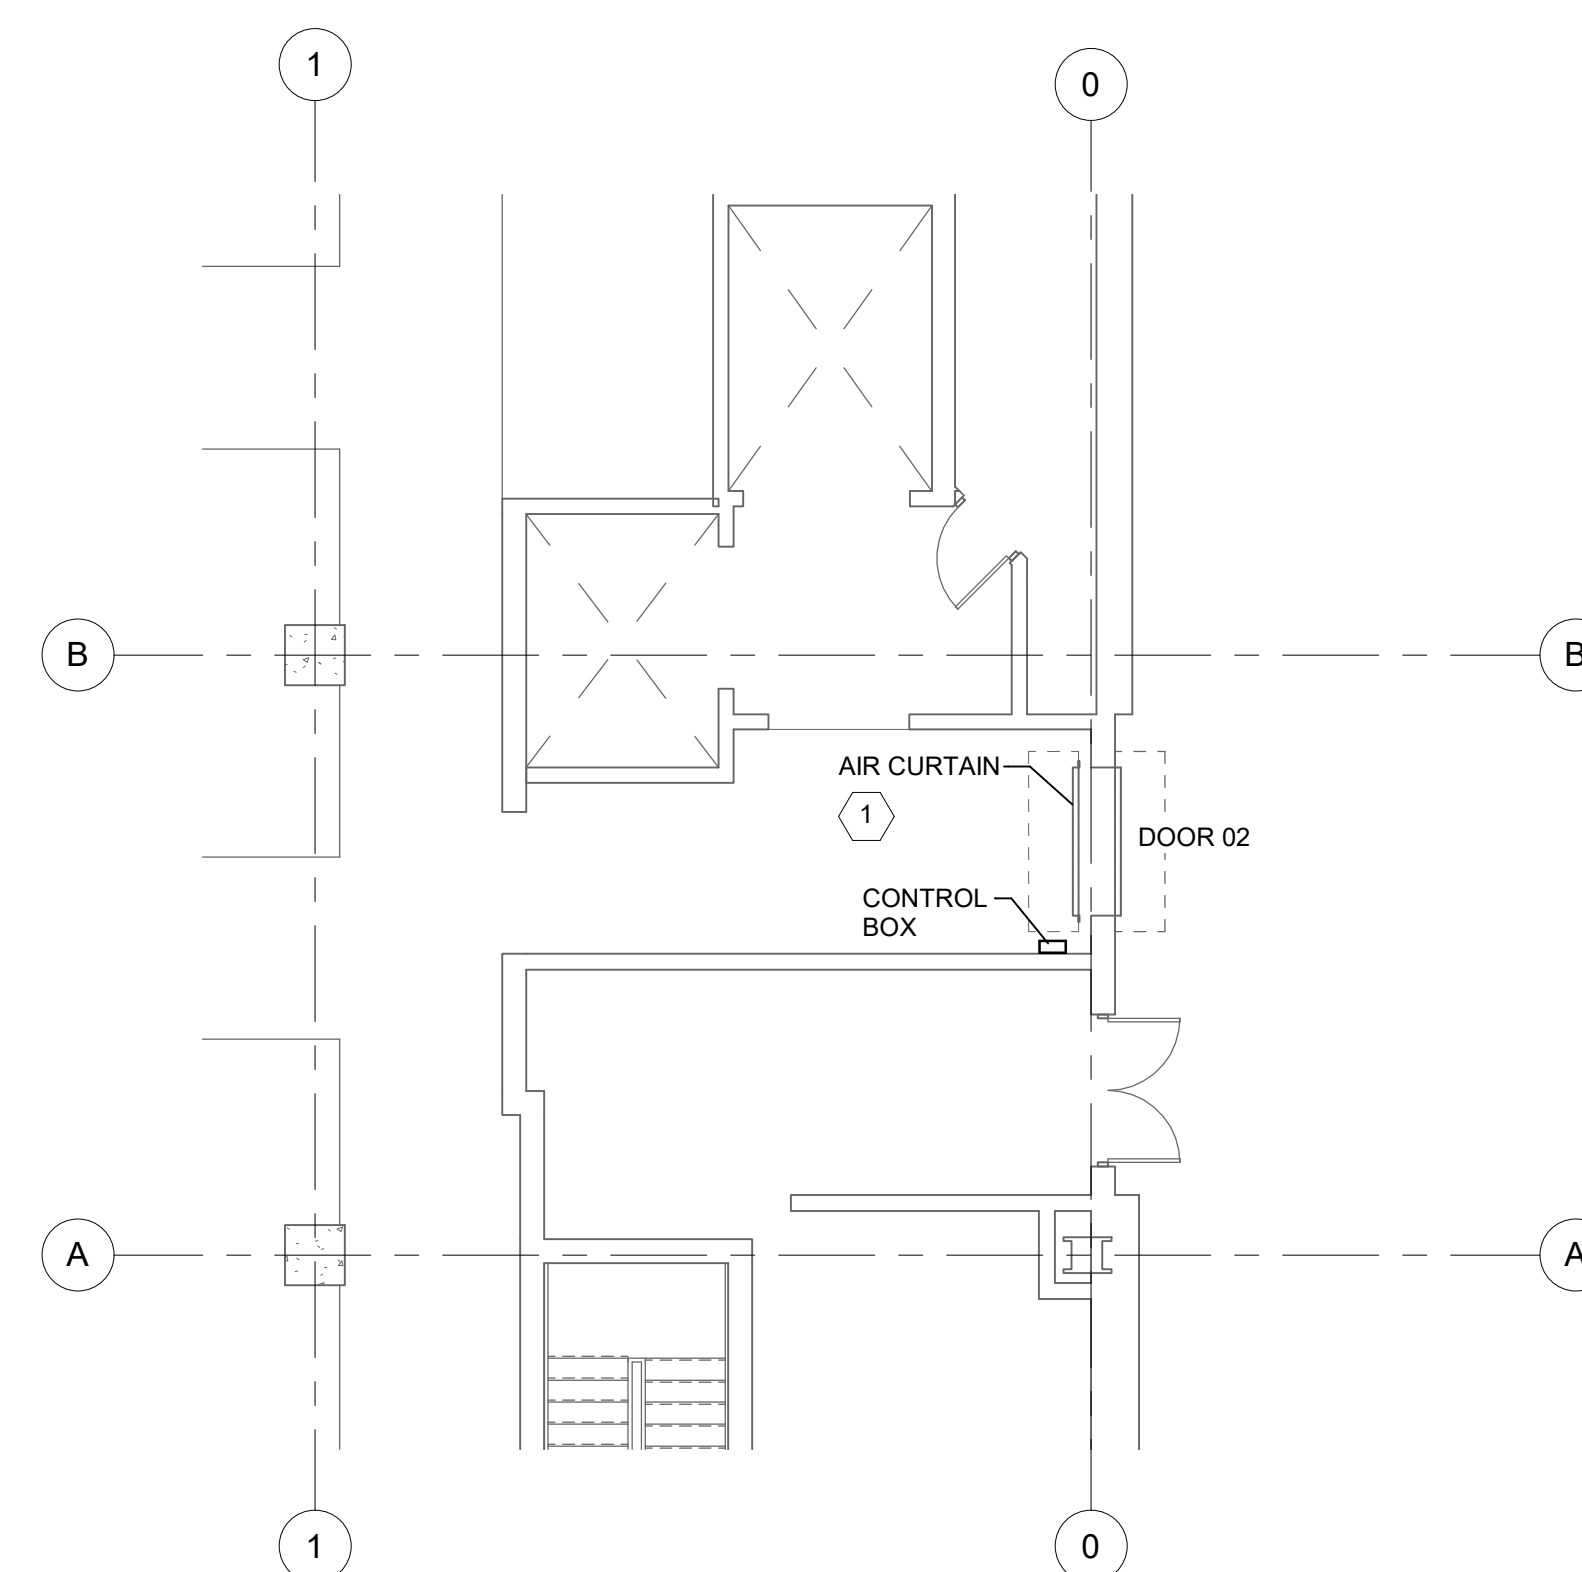

4 ELECTRICAL ENLARGED NEW WORK PLAN - AREA D (AIR CURTAIN)
SCALE: 1/8" = 1'-0"

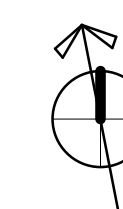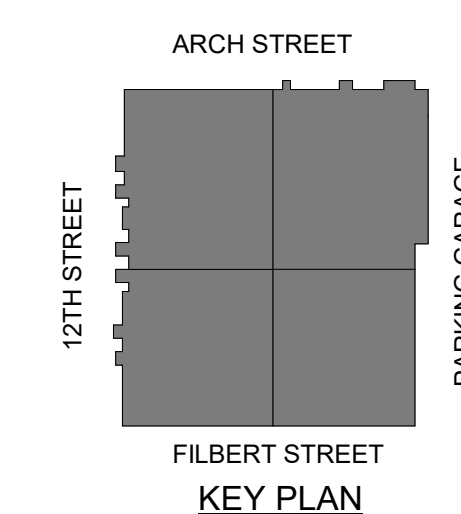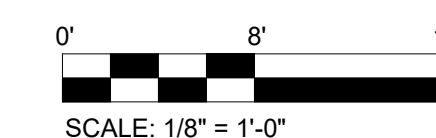

READING TERMINAL MARKET CAPITAL IMPROVEMENTS

READING TERMINAL MARKET

51 NORTH 12TH STREET,
PHILADELPHIA PA 19107

09/26/2022

GENERAL PACKAGE

EXTERIOR DOORS & STOREFRONT

GENERAL	
G001	COVER SHEET
ARCHITECTURAL	
A201	FLOOR PLAN AND EXISTING DOOR PHOTOS
A202	DOOR SCHEDULE DOOR TYPES AND DETAILS
A203	DOOR DETAILS
ELECTRICAL	
E000	ELECTRICAL COVERSHEET
E400	ELECTRICAL FIRST FLOOR POWER & SYSTEMS PLAN



VITETTA

ARCHITECTURE ENGINEERING PLANNING INTERIOR DESIGN
105 CHESLEY DRIVE, SUITE 200
MEDIA, PENNSYLVANIA 19063
T 215.218.4747 F 215.405.2729

NOTE:

- PHOTOS SHOWN ARE OF EXISTING DOORS.
- NEW DOORS SHALL ALL BE THE SAME DESIGN.



(001) (002)
DOOR TYPE - A & A1
ALUMINUM

BASE BID: REPLACE DOORS ONLY.
VIT ALT # 1: REPLACE FRAME & TRANSOM.
LOUVER & FRAME TO REMAIN



(003)
DOOR TYPE - B
ALUMINUM

BASE BID: REPLACE DOORS ONLY.
VIT ALT # 2: REPLACE FRAME AND ALL
GLASS/FRAME IN ENTIRE OPENING.



(004)
DOOR TYPE - C
ALUMINUM

BASE BID: REPLACE 4 DOORS ONLY.
VIT ALT # 2: REPLACE SIDELIGHTS,
FRAME & ALL WINDOWS IN ENTIRE
OPENING.



(005) (006)
DOOR TYPE - C1
ALUMINUM

BASE BID: REPLACE 4 DOORS ONLY.
VIT ALT # 2: REPLACE SIDELIGHTS,
FRAME & ALL WINDOW IN ENTIRE
OPENING



(007)
DOOR TYPE - D
ALUMINUM

BASE BID: REPLACE DOOR ONLY.
VIT ALT # 3: REPLACE SIDELIGHTS, FRAME,
SIDELIGHT & TRANSOM OPENING. EXISTING
WOOD FRAME AND SASH TO BE REPAINTED.



(008)
DOOR TYPE - E
ALUMINUM

BASE BID: REPLACE 2 DOORS, FRAMES
AND COLUMNS AT EACH OPENING.
VIT ALT # 3: REPLACE SIDELIGHTS,
FRAME, SIDELIGHT & TRANSOM GLASS.



(009)
DOOR TYPE - F
ALUMINUM


REPAINT ALL WOOD
FRAME & SASH TO
REMAIN.



(010)
DOOR TYPE - G
ALUMINUM

BASE BID: REPLACE DOOR,
VIT ALT # 3: REPLACE FRAME,
SIDELIGHTS & TRANSOM.

REPAINT ALL WOOD
FRAME & SASH TO
REMAIN.

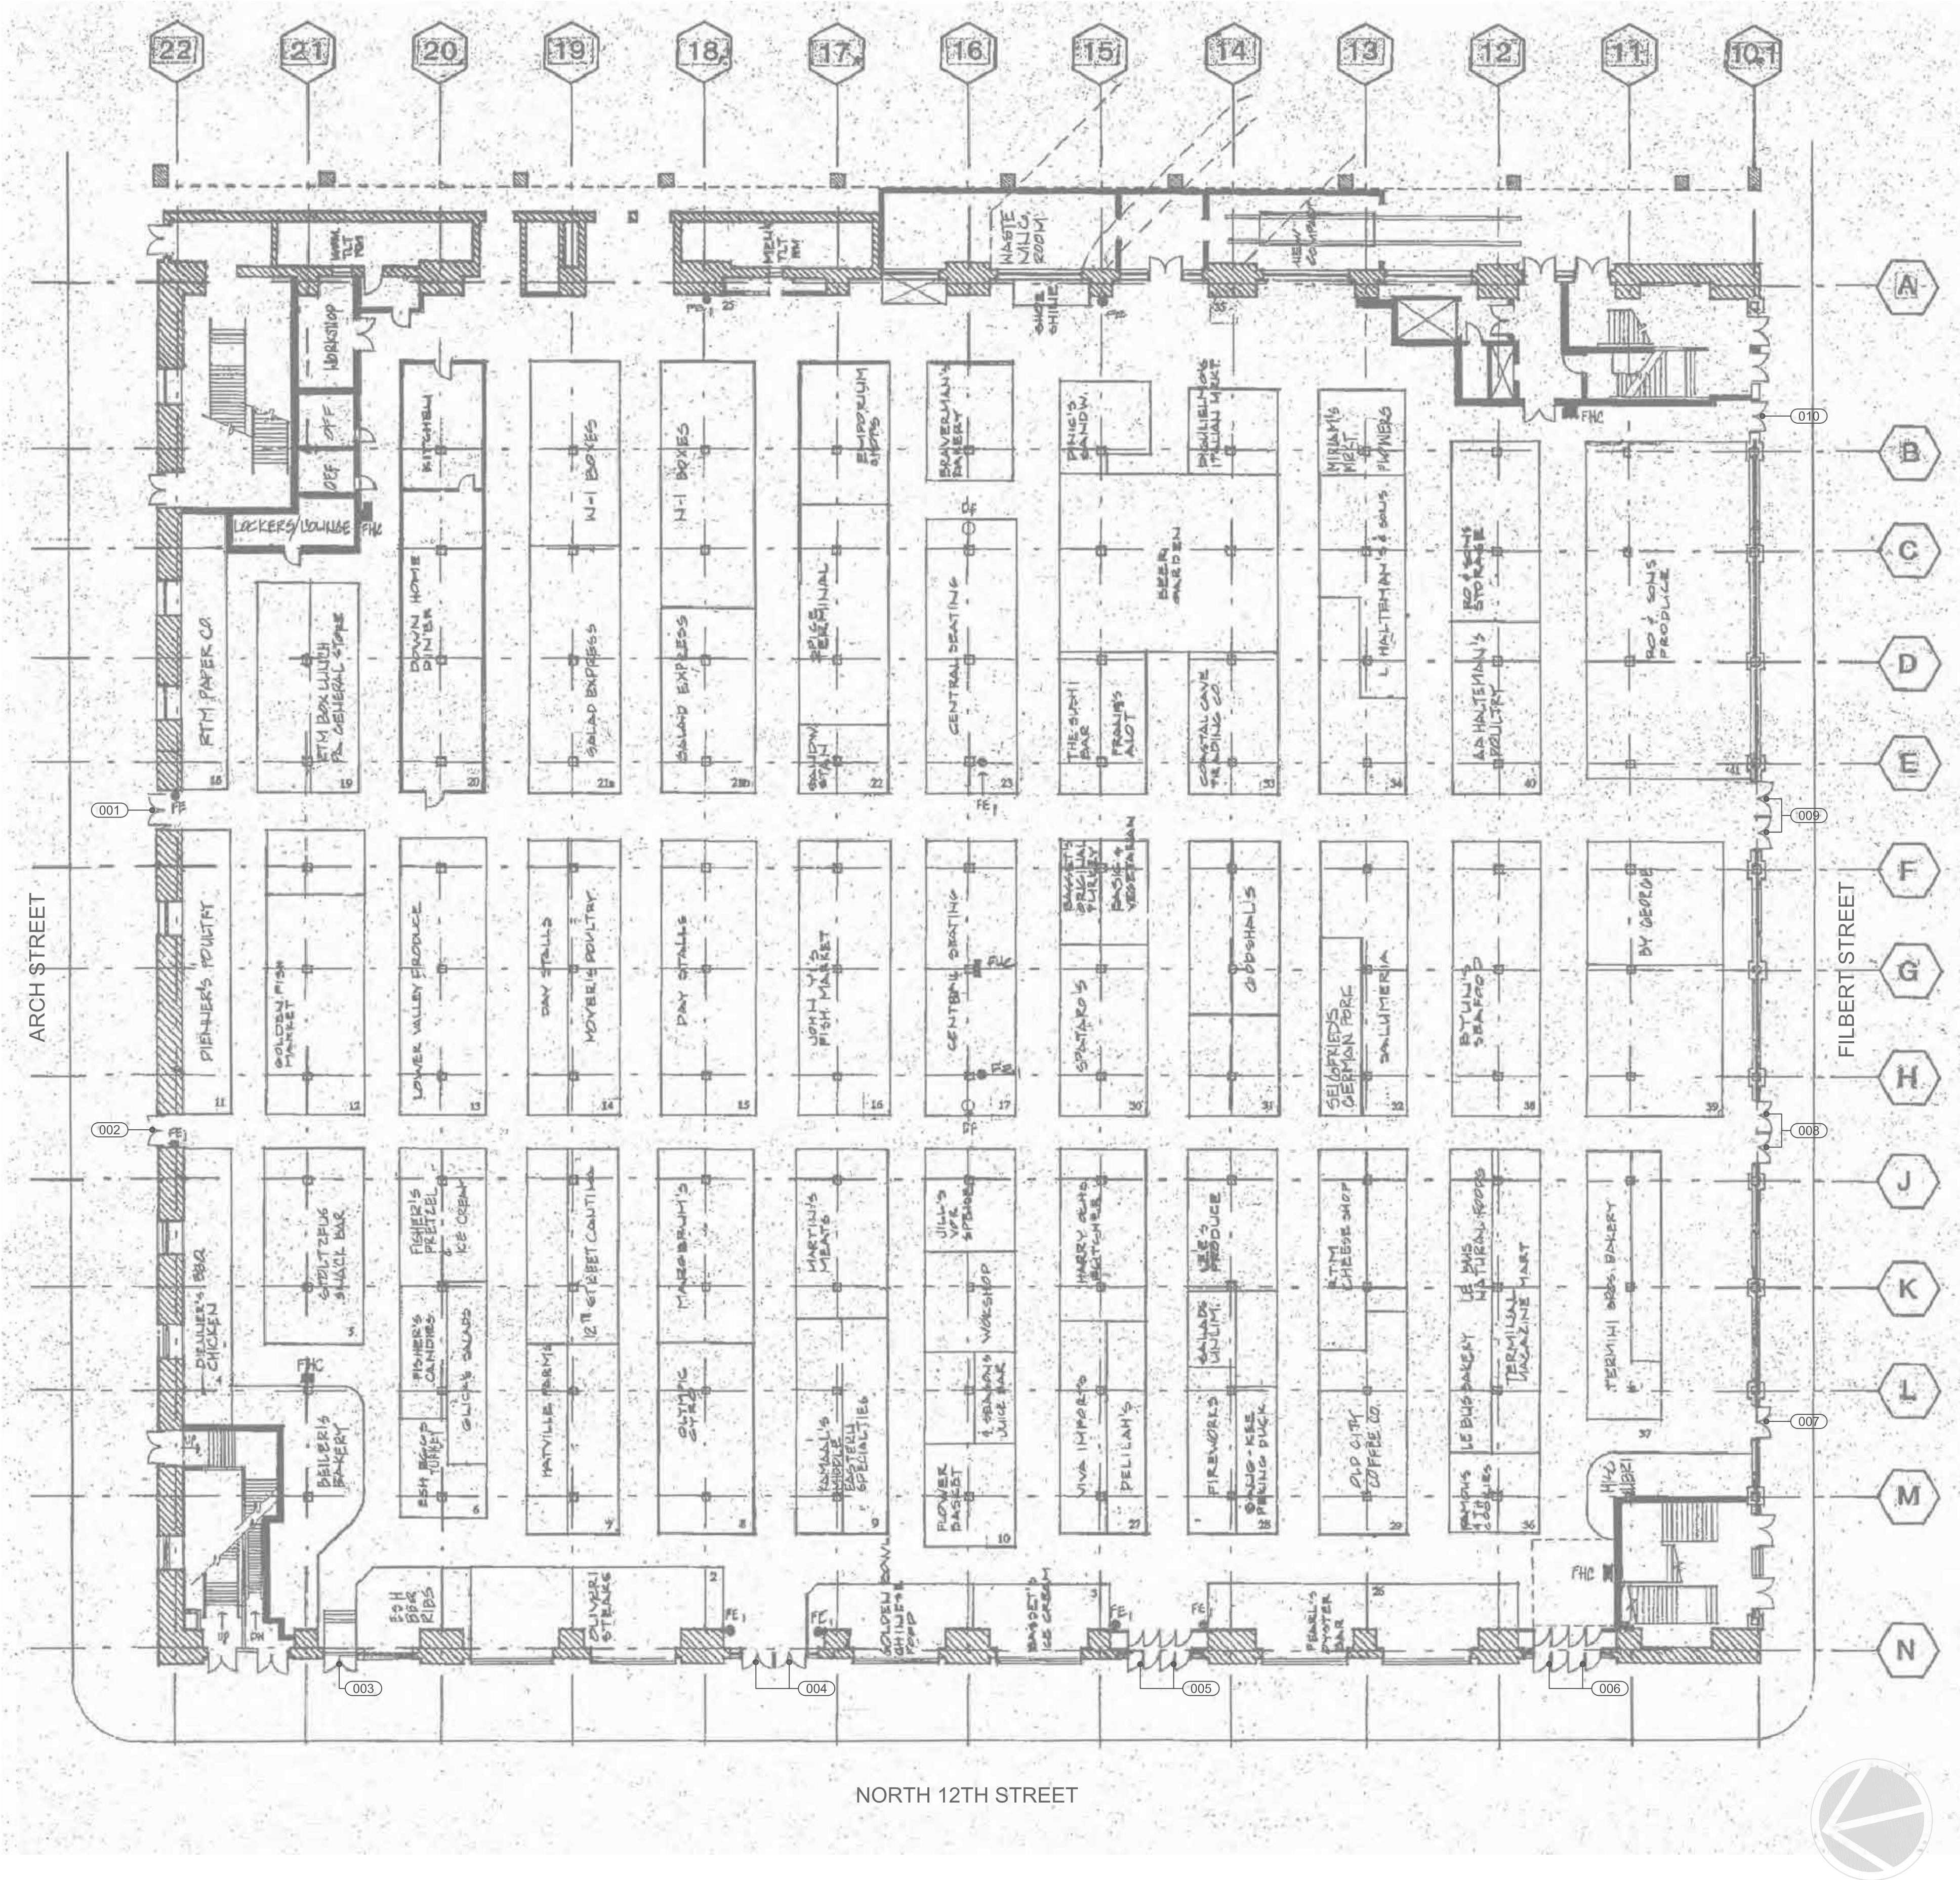

FIRST FLOOR PLAN OF READING TERMINAL MARKET 02

MARKET FLOOR PLAN ABOVE IS FOR LOCATION OF DOORS ONLY. SEE ELEVATIONS
BELOW FOR NUMBER OF DOORS AT EACH OPENING.

READING TERMINAL MARKET
RENOVATION PROJECT
DOOR & FRAME REPLACEMENT
51 NORTH 12TH STREET
PHILADELPHIA, PA 19107

FLOOR PLAN
AND EXISTING
DOOR PHOTOS

SCALE	AS NOTED
DRAWN	
CHECKED	
APPROVED	
DATE	SEPTEMBER 26, 2022


REVISIONS	
SYMBOL	DATE
	DESCRIPTION

DRAWING #

A-201

READING TERMINAL MARKET
RENOVATION PROJECT
DOOR & FRAME REPLACEMENT
51 NORTH 12TH STREET
PHILADELPHIA, PA 19107

DOOR SCHEDULE												
NO.	LOCATION	TYPE	SIZE			FINISH	GLASS	FRAME		FIRE RATING	HDW SET	REMARKS
			WIDTH	HEIGHT	THICK			TYPE	FINISH			
001	ARCH STREET	A1	35 1/2" (PAIR)	83"	1 3/4"	PREFINISHED	UL3	HM (ALT #1)	PREFINISHED	N/A	A	VERIFY ALL DIMS IN THE FIELD ADA ACCESSIBLE DOOR
002	ARCH STREET	A	35 1/2" (PAIR)	83"	1 3/4"	PREFINISHED	UL3	HM (ALT #1)	PREFINISHED	N/A	B	VERIFY ALL DIMENSIONS IN THE FIELD
003	12TH STREET	B	36"(PAIR)	82 3/4"	1 3/4"	PREFINISHED	UL3	HM (ALT #2)	PREFINISHED	N/A	C	VERIFY ALL DIMENSIONS IN THE FIELD
004	12TH STREET	C	±36" (FOUR)	82 3/4"	1 3/4"	PREFINISHED	UL3	HM (ALT #2)	PREFINISHED	N/A	D	VERIFY ALL DIMENSIONS IN THE FIELD
005	12TH STREET	C1	±36" (FOUR)	82 3/4"	1 3/4"	PREFINISHED	UL3	HM (ALT #2)	PREFINISHED	N/A	D	VERIFY ALL DIMENSIONS IN THE FIELD
006	12TH STREET	C1	±36" (FOUR)	82 3/4"	1 3/4"	PREFINISHED	UL3	HM (ALT #2)	PREFINISHED	N/A	D	VERIFY ALL DIMENSIONS IN THE FIELD
007	FILBERT STREET	D	35 3/8"	83"	1 3/4"	PREFINISHED	UL3	HM (ALT #3)	PREFINISHED	N/A	E	VERIFY ALL DIMENSIONS IN THE FIELD
008	FILBERT STREET	E	(2) 35 3/8"	83"	1 3/4"	PREFINISHED	UL3	HM	PREFINISHED	N/A	F	VERIFY ALL DIMS IN THE FIELD ADA ACCESSIBLE DOOR
009	FILBERT STREET	F	(2) 35 3/8"	83"	1 3/4"	PREFINISHED	UL3	HM	PREFINISHED	N/A	G	VERIFY ALL DIMENSIONS IN THE FIELD
010	FILBERT STREET	G	35 3/8"	83"	1 3/4"	PREFINISHED	UL3	HM (ALT #3)	PREFINISHED	N/A	E	VERIFY ALL DIMENSIONS IN THE FIELD

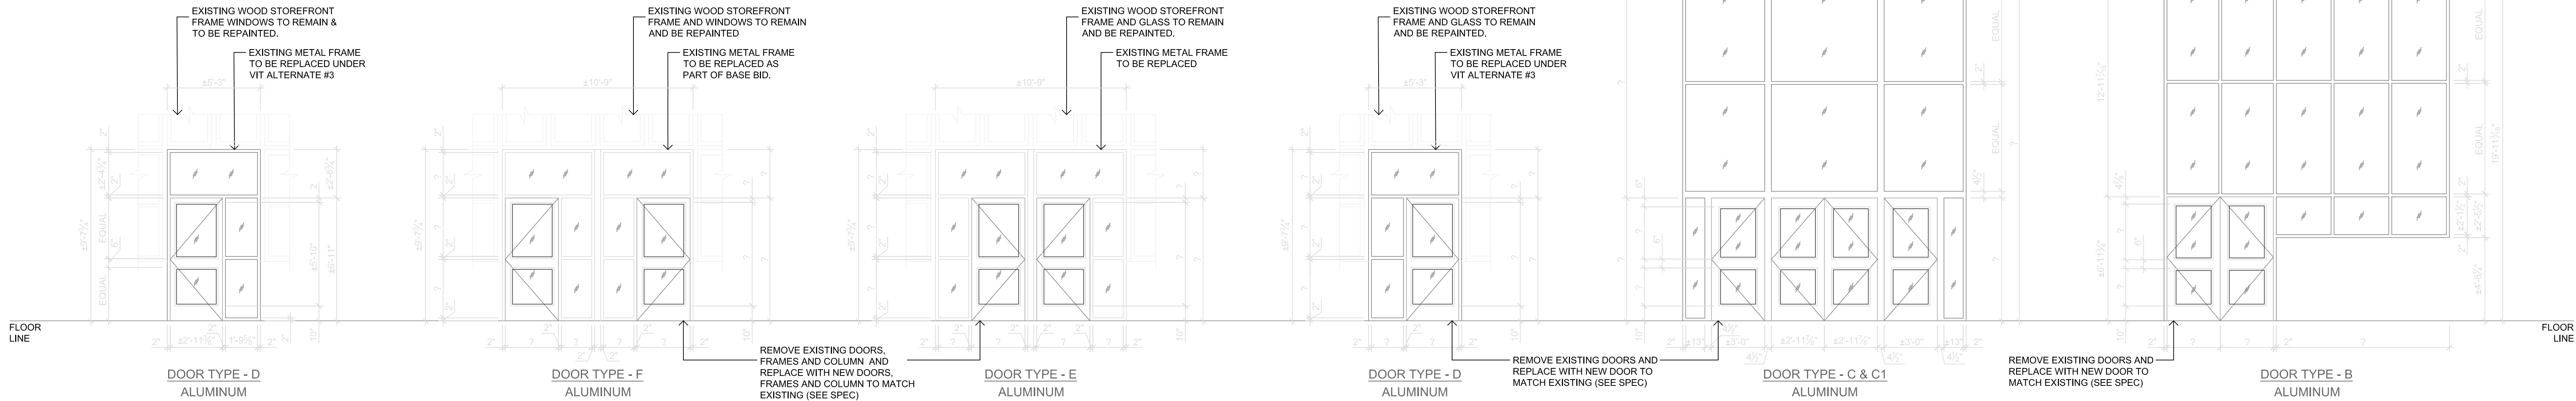

DOOR SCHEDULE
DOOR TYPES
AND DETAILS

SCALE	AS NOTED	
DRAWN		
CHECKED		
APPROVED		
DATE	SEPTEMBER 26, 2022	
REVISIONS		
SYMBOL	DATE	DESCRIPTION
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DRAWING #		

A-202

ELECTRICAL SYMBOL LIST

- POWER**
- EWC ELECTRIC WATER COOLER - PROVIDE 20A, 125V SIMPLEX RECEPTACLE AND DEDICATED CIRCUIT. MOUNT RECEPTACLE WITHIN COOLER ENCLOSURE.
- DUPLEX RECEPTACLE - 125V, 20A GROUNDING TYPE, 3W
- INDICATES DEVICE IS MOUNTED ABOVE COUNTER HEIGHT, BACKSPASH, OR AS NOTED ON DRAWINGS
- QUADRAPLEX RECEPTACLE - 125V, 20A, GROUNDING TYPE, 3W
- DUPLEX GROUND FAULT RECEPTACLE - 125V, 20A, GROUNDING TYPE, 3W
- DUPLEX GROUND FAULT RECEPTACLE - 125V, 20A, GROUNDING TYPE, 3W MOUNTED ABOVE COUNTER HEIGHT, BACKSPASH, OR AS INDICATED ON DRAWINGS
- SINGLE RECEPTACLE - SPECIAL PURPOSE (AS NOTED ON DRAWINGS)
- FLOOR MOUNTED DUPLEX RECEPTACLE - 125V, 20A GROUNDING TYPE, 3W
- FLOOR MOUNTED QUADRAPLEX RECEPTACLE - 125V, 20A, GROUNDING TYPE, 3W
- CEILING MOUNTED DUPLEX RECEPTACLE - 125V, 20A GROUNDING TYPE, 3W
- JUNCTION BOX (FLOOR, CEILING, WALL MOUNTED)
- PULL BOX
- MOTOR
- TRANSFORMER
- GROUND ROD
- TELEPHONE/DATA**
- COMBINATION TELEPHONE/DATA OUTLET
DENOTES ABOVE COUNTER MOUNTING HEIGHT
- DATA COMMUNICATION OUTLET
- TELEPHONE OUTLET
- FLOOR MOUNTED DATA OUTLET
- FLOOR MOUNTED TELEPHONE OUTLET
- FLOOR MOUNTED COMBINATION TELEPHONE/DATA OUTLET
- AUDIO/VISUAL JUNCTION BOX (FLOOR, CEILING, WALL MOUNTED)
- WIRELESS ACCESS POINT JUNCTION BOX (CEILING)
- FIRE ALARM**
- FIRE ALARM MANUAL PULL STATION
- FIRE ALARM AUDIBLE SIGNAL AND STROBE LIGHT COMBINATION
- FIRE ALARM STROBE LIGHT
- AREA SMOKE DETECTOR, PHOTOELECTRIC (900 SQ. FT. COVERAGE)
- THERMAL, FIXED TEMPERATURE TYPE, 200° (625 SQ. FT. COVERAGE)
- DUCT MOUNTED SMOKE DETECTOR, PHOTOELECTRIC
- FIRE ALARM CONTROL PANEL
- FIRE ALARM ANNUNCIATOR PANEL
- SPRINKLER FLOW SWITCH
- SPRINKLER TAMPER SWITCH
- FIRE ALARM RELAY MODULE
- FIRE ALARM MONITORING MODULE
- CIRCUIT PROTECTION**
- MANUAL MOTOR STARTER
- DISCONNECT SWITCH, UNFUSED TYPE
- DISCONNECT SWITCH, FUSED TYPE
- PANELBOARDS**
- SURFACE MOUNTED ELECTRICAL PANELBOARD
- RECESSED MOUNTED ELECTRICAL PANELBOARD
- SYSTEMS PANEL OR TERMINAL CABINET (AS INDICATED ON DRAWING)
- DISTRIBUTION PANEL
- SECURITY**
- CARD READER
- MAGNETIC LOCK
- ELECTRIC STRIKE
- DOOR CONTACT
- CCTV CAMERA CEILING JUNCTION BOX

- LIGHTING (NOTE: LOWER CASE LETTER INDICATES SWITCHING ARRANGEMENT)**
- FLUORESCENT LIGHTING FIXTURE (LETTER INDICATES TYPE)
- FLUORESCENT STRIP FIXTURE (LETTER INDICATES TYPE)
- FLUORESCENT DOWNLIGHT (LETTER INDICATES TYPE)
- WALL BRACKET FIXTURE (LETTER INDICATES TYPE)
- EMERGENCY BATTERY PACK (LETTER INDICATES TYPE)
- EXIT SIGN (LETTER INDICATES TYPE)
- LIGHTING FIXTURE ON EMERGENCY (LETTER INDICATES TYPE)
- SWITCHING**
- SINGLE POLE SWITCH
- THREE WAY AND FOUR WAY SWITCHES
- SWITCH WITH INTEGRAL VACANCY SENSOR & LOW VOLTAGE DIMMING (0-10V)
- LOW VOLTAGE DIMMING (0-10V) SWITCH
- OCCUPANCY SENSOR
- DAYLIGHT SENSOR
- AUTOMATIC DOOR LIGHT SWITCH
- LOCAL EXHAUST FAN SWITCH
- BRANCH CIRCUIT WIRING (WHERE SHOWN)**
- BRANCH CIRCUIT WIRING AND/OR CONDUIT WITH WIRE, CONCEALED IN FLOOR OR BELOW GRADE. PROVIDE GROUND WIRES IN PVC CONDUITS WHERE PVC CONDUITS ARE PERMITTED.
- BRANCH CIRCUIT WIRING AND/OR CONDUIT WITH WIRE, CONCEALED IN CEILING OR WALL.
- BRANCH CIRCUIT WIRING AND/OR CONDUIT WITH WIRE, EXPOSED
- BRANCH CIRCUIT WIRING TO PANEL
- DENOTES CIRCUIT NUMBER AT PANELBOARD
- DENOTES PANELBOARD IDENTITY (NAME)
- BRANCH CIRCUIT WIRE AND/OR CONDUIT WITH WIRE, TURNING UP TOWARD OBSERVER
- BRANCH CIRCUIT WIRE AND/OR CONDUIT WITH WIRE, TURNING AWAY FROM OBSERVER
- POWER DISTRIBUTION (SINGLE LINE DIAGRAM)**
- CURRENT TRANSFORMER (CT)
- POTENTIAL TRANSFORMER (PT)
- METER (ELECTRIC)
- CIRCUIT BREAKER
- DISCONNECT SWITCH
- FUSE
- TRANSFORMER
- TRANSFER SWITCH
- TRANSIENT VOLTAGE SURGE SUPPRESSOR
- SHUNT TRIP

ABBREVIATIONS

1P	ONE POLE	LTO	LIGHTING
2P	TWO POLE	MCB	MAIN CIRCUIT BREAKER
3P	THREE POLE	MDP	MAIN DISTRIBUTION PANEL
4P	FOUR POLE	(ME)	MODIFY EXISTING
A	AMPERE	MISC	MISCELLANEOUS
AB	ABOVE CEILING	MLO	MAIN LUGS ONLY
AC	ABOVE COUNTER	MOD	MOTOR OPERATED DISCONNECT SWITCH
AFCI	ARC FAULT CURRENT INTERRUPTER	MTD	MOUNTED
AFF	ABOVE FINISHED FLOOR	MTG	MOUNTING
AIC	AMPS INTERRUPTING CURRENT	MTS	MANUAL TRANSFER SWITCH
AFG	ABOVE FINISHED GRADE	(N)	NEW
ARCH	ARCHITECT	N/A	NOT APPLICABLE
ATS	AUTOMATIC TRANSFER SWITCH	NEC	NATIONAL ELECTRICAL CODE
BLDG	BUILDING	NIC	NOT IN CONTRACT
C	CONDUIT	NL	NIGHT LIGHT
CATV	CABLE TELEVISION	#	NUMBER
CB	CIRCUIT BREAKER	NTS	NOT TO SCALE
CD	CANDELA	P	POLE
CIR	CIRCUIT	PB	PULL BOX
CMT	EMPTY CONDUIT	PH Ø	PHASE
C.T.	CURRENT TRANSFORMER	PNL	PANEL
DISC	DISCONNECT	PVC	POLYVINYL CHLORIDE CONDUIT
DWG	DRAWING	PWR	POWER
(E)	EXISTING TO REMAIN	(R)	REMOVE EXISTING
EC	ELECTRICAL CONTRACTOR	(RE)	RELOCATED EXISTING
(ER)	EXISTING TO BE RELOCATED	(RR)	REMOVE & REPLACE
EWC	ELECTRIC WATER COOLER	REC	RECESSED
FA	FIRE ALARM	SCP	SECURITY CONTROL PANEL
FACP	FIRE ALARM ANNUNCIATOR PANEL	ST	SHUNT TRIP
FLA	FIRE ALARM CONTROL PANEL	SWBD	SWITCHBOARD
FLA	FULL LOAD AMPS	SYS	CONNECTION TO SYSTEMS FURNITURE
GC	GENERAL CONTRACTOR	TC	TIME CLOCK
GFCI	GROUND FAULT CIRCUIT INTERRUPTER	TEL/DATA	TELEPHONE/DATA
GND	GROUNDING	TEL	TELEPHONE
HP	HORSEPOWER	TIB	TELEPHONE TERMINAL BOARD
HV	HIGH VOLTAGE	TVSS	TRANSIENT VOLTAGE SURGE SUPPRESSION
Hz	HERTZ (CYCLE) PER SECOND	TYP	TYPICAL
IG	ISOLATED GROUND	UON	UNLESS OTHERWISE NOTED
JB	JUNCTION BOX	V	VOLT
KCMIL	THOUSAND CIRCULAR MILS	W	WATT
KVA	KILOVOLT AMPERE	WP	WEATHERPROOF
KW	KILOWATT	XFMR	TRANSFORMER
LP	LIGHTING PANEL	+	INDICATES MOUNTED ABOVE CENTER OR AS NOTED ON DWG.
		#1/E5.1	DETAIL NUMBER/DRAWING NUMBER

A. SCOPE OF WORK

1. THE WORK UNDER THIS SPECIFICATION INCLUDES THE SATISFACTORY COMPLETION OF ELECTRICAL SYSTEMS AS SHOWN ON THE DRAWINGS, INCLUDING, BUT NOT LIMITED TO THE FOLLOWING:

- A. POWER: MODIFY EXISTING BRANCH CIRCUITING AND PROVIDE NEW BRANCH CIRCUIT WIRING TO AUTOMATIC DOOR OPERATORS SERVING THE MARKET AND TO THE NEW SECURITY SYSTEM HEAD END LOCATED WITHIN THE SECURITY OFFICE.
- B. SECURITY: EXISTING DOOR CONTACTS AND WIRING AT ALL EXTERIOR MARKET DOORS TO BE REMOVED. PROVIDE NEW SECURITY HEAD END, ASSOCIATED PROGRAMMING, AND NEW RECESSED DOOR CONTACTS AND WIRING TO MONITOR ALL EXTERIOR DOORS SERVING THE MARKET.
- C. FIRE ALARM: REMOVE AND REINSTALL FIRE ALARM DEVICES TO ACCOMMODATE INSTALLATION OF NEW EXTERIOR DOORS AND DOOR FRAMES SERVING THE MARKET.

B. INTENT:

1. THE ELECTRICAL CONTRACTOR SHALL OBTAIN PERMITS, PAY FEES, AND ARRANGE INSPECTIONS FOR CODE COMPLIANT AND FULLY FUNCTIONING SYSTEMS. NOTIFY THE ARCHITECT OF ANY DEVIATIONS FROM THESE PLANS.
2. IT IS THE INTENT OF THE DRAWINGS AND SPECIFICATIONS THAT ALL WORK, LIGHT FIXTURES, APPURTENANCES, CONTROLS, AND WIRING BE FURNISHED AND INSTALLED COMPLETED AND READY FOR OPERATION.
3. UNLESS FUNCTIONALLY NECESSARY, ALL WORK SHALL BE CONCEALED. ALL EXPOSED ITEMS WILL BE SUBJECT TO THE ARCHITECT'S APPROVAL. BOTH FOR POSITION AND FINISH. WHEN AN ITEM, DEVICE, OR FIXTURE IS SHOWN ON THE ARCHITECTURAL DRAWINGS THESE POSITIONS SHALL TAKE PRECEDENCE OVER THE ELECTRICAL DRAWINGS. IF THE VARIATION IN POSITION IS GREATER THAN 18", THE CONTRACTOR SHALL BRING IT TO THE ATTENTION OF THE ARCHITECT FOR RESOLUTION.
4. DRAWINGS ARE DIAGRAMMATIC. SMALL SCALE, AND INDICATE THE GENERAL ARRANGEMENT OF SYSTEMS AND WORK INCLUDED. HOWEVER, CERTAIN APPURTENANCES AND RELATED SPECIALTIES ARE NOT SHOWN, BUT SHALL BE PROVIDED TO ENSURE A COMPLETE INSTALLATION.

C. LAWS AND REGULATIONS:

1. PERFORM WORK IN ACCORDANCE WITH RULES, REGULATIONS, STANDARDS, CODES, ORDINANCES, AND LAWS OF LOCAL, STATE, AND FEDERAL GOVERNMENTS AND AUTHORITIES HAVING JURISDICTION AND BE RESPONSIBLE FOR COMPLIANCE HEREWITH.
2. ANY CHANGES NECESSARY IN ORDER THAT THE WORK COMPLY WITH SUCH LAWS, ORDINANCES, RULES AND REGULATIONS SHALL BE MADE BY THE ELECTRICAL CONTRACTOR, WITH THE APPROVAL OF THE ARCHITECT, AND AT NO ADDITIONAL COST TO THE OWNER.
3. UNLESS OTHERWISE NOTED OR SPECIFIED, ALL MATERIALS AND EQUIPMENT PROVIDED SHALL BE NEW AND SHALL CONFORM TO THE GRADE, QUALITY AND STANDARDS SPECIFIED HEREIN.
4. MATERIALS AND EQUIPMENT PROVIDED UNDER THESE SPECIFICATIONS SHALL BE LIMITED TO PRODUCTS REGULARLY PRODUCED AND RECOMMENDED BY THE MANUFACTURER FOR THE SERVICE INTENDED. THIS MATERIAL AND EQUIPMENT SHALL HAVE CAPACITIES AND RATINGS SUFFICIENT TO MEET THE REQUIREMENTS OF THE PROJECT. THE CAPACITIES AND RATINGS SHALL NOT BE IN EXCESS OF THOSE PUBLISHED BY THE MANUFACTURER, BUT MUST BE IN ACCORDANCE WITH ENGINEERING DATA OR OTHER COMPREHENSIVE DATA MADE AVAILABLE TO THE PUBLIC BY THE MANUFACTURER AND IN EFFECT AT THE TIME OF THE OPENING OF THE BIDS.
5. ELECTRICAL DEVICES, MATERIALS, AND EQUIPMENT OF A TYPE APPROVED AND LABELED BY UNDERWRITERS LABORATORY SHALL BE PROVIDED WHEREVER AVAILABLE ON THE MARKET, COMPLETE WITH LABEL.

D. CUTTING, PATCHING AND PAINTING:

1. UNLESS OTHERWISE INDICATED, ALL CUTTING AND PATCHING FOR WORK REQUIRED SHALL BE BY THE ELECTRICAL CONTRACTOR REQUIRING THE OPENING.
2. PATCH EXISTING HOLES LEFT AS A RESULT OF REMOVAL IN ALL SURFACES, VISIBLE OR NOT.

E. INSTALLATION:

1. ALL WIRING SHALL BE COPPER CONDUCTORS, ALUMINUM AND ALUMINUM ALLOY ARE NOT ACCEPTABLE UNLESS APPROVED BY THE OWNER OR ENGINEER, WITH RE-ENGINEERED WIRE SIZES BY THE INSTALLING CONTRACTOR.
2. ALL CONDUCTORS SHALL BE COLOR CODED AS FOLLOWS:
- | | |
|-------------|------------------|
| PHASE-A,B,C | BLACK, RED, BLUE |
| NEUTRAL | WHITE |
| GROUND | GREEN |
3. ALL WIRING, UNLESS OTHERWISE NOTED ON DRAWINGS, SHALL BE MINIMUM #12AWG, 600V INSULATION TYPE THHN/THWN STRANDED CONDUCTORS, RATED FOR TFC TEMPERATURE.
4. THE ELECTRICAL CONTRACTOR SHALL LABEL ALL RECEPTACLES, JUNCTION BOXES, AND EQUIPMENT WITH SOURCE PANEL AND CIRCUIT NUMBER.
5. REFER TO ARCHITECTURAL DRAWINGS FOR EXACT LOCATION OF ELECTRICAL DEVICES. REFER TO ARCHITECTURAL ROOM FINISH SCHEDULE OR CEILING TYPES AND PROVIDE APPROPRIATE MOUNTING HARDWARE, PLASTER FRAMES, PENDANTS, ETC.

F. LOW-VOLTAGE CONDUCTORS:

1. MANUFACTURERS:
GENERAL CABLE CORPORATION
SOUTHWIRE INCORPORATED
OKONITE CABLE COMPANY
ALLIED WIRE & CABLE
2. MATERIALS:
A. FEEDERS: COPPER STRANDED FOR NO. 6AWG AND LARGER.
B. BRANCH CIRCUITS: COPPER, STRANDED FOR NO. 12AWG AND LARGER.
3. APPLICATION:
A. ALL INSTALLATIONS: THHN/THWN SINGLE CONDUCTORS IN RACEWAY.
6. RACEWAYS AND BOXES:

1. MANUFACTURERS:
ALLIED TUBE & CONDUIT
THOMAS & BETTS CORPORATION
WHEATLAND TUBE COMPANY
2. GENERAL:
A. RIGID STEEL: COMPLY WITH ANSI C80.2 AND UL6.
B. EMT: COMPLY WITH ANSI C80.3 AND UL 797.
C. FMC: COMPLY WITH UL1; ZINC-COATED STEEL.
3. EMT:
A. 3/4-INCH TRADE SIZE MINIMUM
B. SET-SCREW CONNECTORS
4. SHEET METAL DEVICE BOXES:
A. COMPLY WITH NEMA OS-1 AND UL 514A
B. ZINC PLATED STEEL

H. SECURITY AND ACCESS CONTROL

1. SECURITY AND ACCESS CONTROL SYSTEM DELEGATED-DESIGN SUBMITTAL: SCHNEIDER ELECTRIC ECOSYSTEM SECURITY EXPERT ACCESS CONTROL SYSTEM OR APPROVED EQUAL.
2. PROVIDE MINIMUM 3/4" BOX AND CONDUIT RACEWAY SYSTEM TO SUPPORT INSTALLATION OF THE FOLLOWING:
1. SECURITY SYSTEM HEAD END.
2. DOOR POSITION MONITORING AT ALL EXTERIOR MARKET DOORS.
3. SYSTEM PROGRAMMING AND NETWORK INTERFACE FOR LOCAL AND REMOTE MONITORING. AUDIBLE ALARM SHALL SOUND IN SECURITY ROOM AND ANNUNCIATE AT LOCAL COMPUTER. ALARMS SHALL PUSH TO NETWORK FOR REMOTE MONITORING.
4. SCHEDULING CONSISTING OF THE FOLLOWING:
4.1. DOORS TO ALARM WHEN HELD OPEN LONGER THAN 30 SECONDS DURING MARKET OPERATING HOURS.
4.2. DOORS TO ALARM WHEN OPENED DURING MARKET CLOSED HOURS.
- 4.3. PROVIDE OPERATOR ABILITY TO OVERRIDE ALARM AT SELECT DOORS WHEN MARKET VENDORS ARE BRINGING PRODUCT THROUGH EXTERIOR DOORS.

3. PROVIDE RECESSED MOUNT, 3/4" DIAMETER, DOOR CONTACT MAGNETIC REED SWITCH WITH SPST FORM A, NORMALLY OPEN, CONTACTS AT EACH LOCATION SHOWN ON PLANS. PROVIDE SENTEX PN BR-1021T OR APPROVED EQUAL.

I. ELECTRICAL SYSTEM TESTING:

1. TEST FOR SHORT CIRCUIT AND GROUND PRIOR TO ENERGIZING.
2. AFTER VERIFICATION OF THE ABOVE SYSTEMS, SCHEDULE ROUGH-IN AND FINAL ELECTRICAL INSPECTIONS BY APPROVED INSPECTION AGENCY. ALL FEES ASSOCIATED WITH ELECTRICAL AND FIRE ALARM INSPECTIONS SHALL BE COVERED BY THE ELECTRICAL CONTRACTOR AS PART OF THEIR BID.
3. VERIFY THE PROPER OPERATION OF AUTOMATIC ADA DOOR OPERATORS AFTER INSTALLATION IS COMPLETE UNDER WITNESS BY RTMA.
4. VERIFY OPERATION OF DOOR CONTACTS UNDER WITNESS BY RTMA.

J. WARRANTY:

1. THE ELECTRICAL CONTRACTOR SHALL FURNISH, BEFORE FINAL PAYMENT, A WRITTEN FULL WARRANTY FOR THIS INSTALLATION AND ITS PARTS.
2. SUCH WARRANTY SHALL BE IN EFFECT FOR A PERIOD OF ONE YEAR FROM DATE OF ACCEPTANCE OF THE SYSTEMS AS A WHOLE, AS SIGNIFIED BY THE ARCHITECT'S APPROVAL OF THE FINAL REQUEST FOR PAYMENT.

VITETTA

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CONSULTANTS



SEAL

PROJECT # 6328.00

ALL DIMENSIONS MUST BE VERIFIED BY CONTRACTOR AND THE ARCHITECT NOTIFIED OF ANY DISCREPANCIES BEFORE PROCEEDING WITH THE CONSTRUCTION

DO NOT SCALE DRAWINGS
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PROJECT TITLE

READING TERMINAL MARKET
RENOVATION PROJECT
DOOR & FRAME REPLACEMENT
51 NORTH 12TH STREET
PHILADELPHIA, PA 19107

DRAWING TITLE

ELECTRICAL COVER SHEET

SCALE	AS NOTED
DRAWN	DM
CHECKED	CMF
APPROVED	J&M PROJECT: 21-049
DATE	09/23/2022

REVISIONS

SYMBOL	DATE	DESCRIPTION

DRAWING #

E000

